



2 WATER SHEETING FROM ROAD AND DRIVEWAY TOWARDS CHANNEL



3 SIGNIFICANT WATER POOLING IN FRONT OF PROPERTY



4 PATH OF WATER ALONG SHADY EDGE OF PROPERTY



5 DEEP LEAF LITTER ALONG STEEP SLOPE AT BACK OF PROPERTY



6 INVASIVE JAPANESE KNOTWEED AND WATER POOLING IN BACK YARD

Proj

SUSTAINABLE YARD DESIGN CASE STUDY 4 WORCESTER, MA



Weston & Sampson Engineers, Inc. 55 Walkers Brook Drive, Suite 100 Reading, MA 01867

978.532.1900

.1900 800.SAMPSON

www.westonandsampson.com


www.westonandsampson.com								
Revisions:								
No.	Date Description							
Issue	Issued For: NOT RELEASED FOR CONSTRUCTION							
Scal	Scale: 1" = 20'-0"							
Date	:	05/09/24						
Draw	n By:	CD						
Revi	ewed By:	AS						
Аррі	oved By:	JM						
W&S Project No.: ENG22 - 1048 W&S File No.:								

Drawing Title:

EXISTING CONDITIONS PHOTOS

Sheet Number:


C102

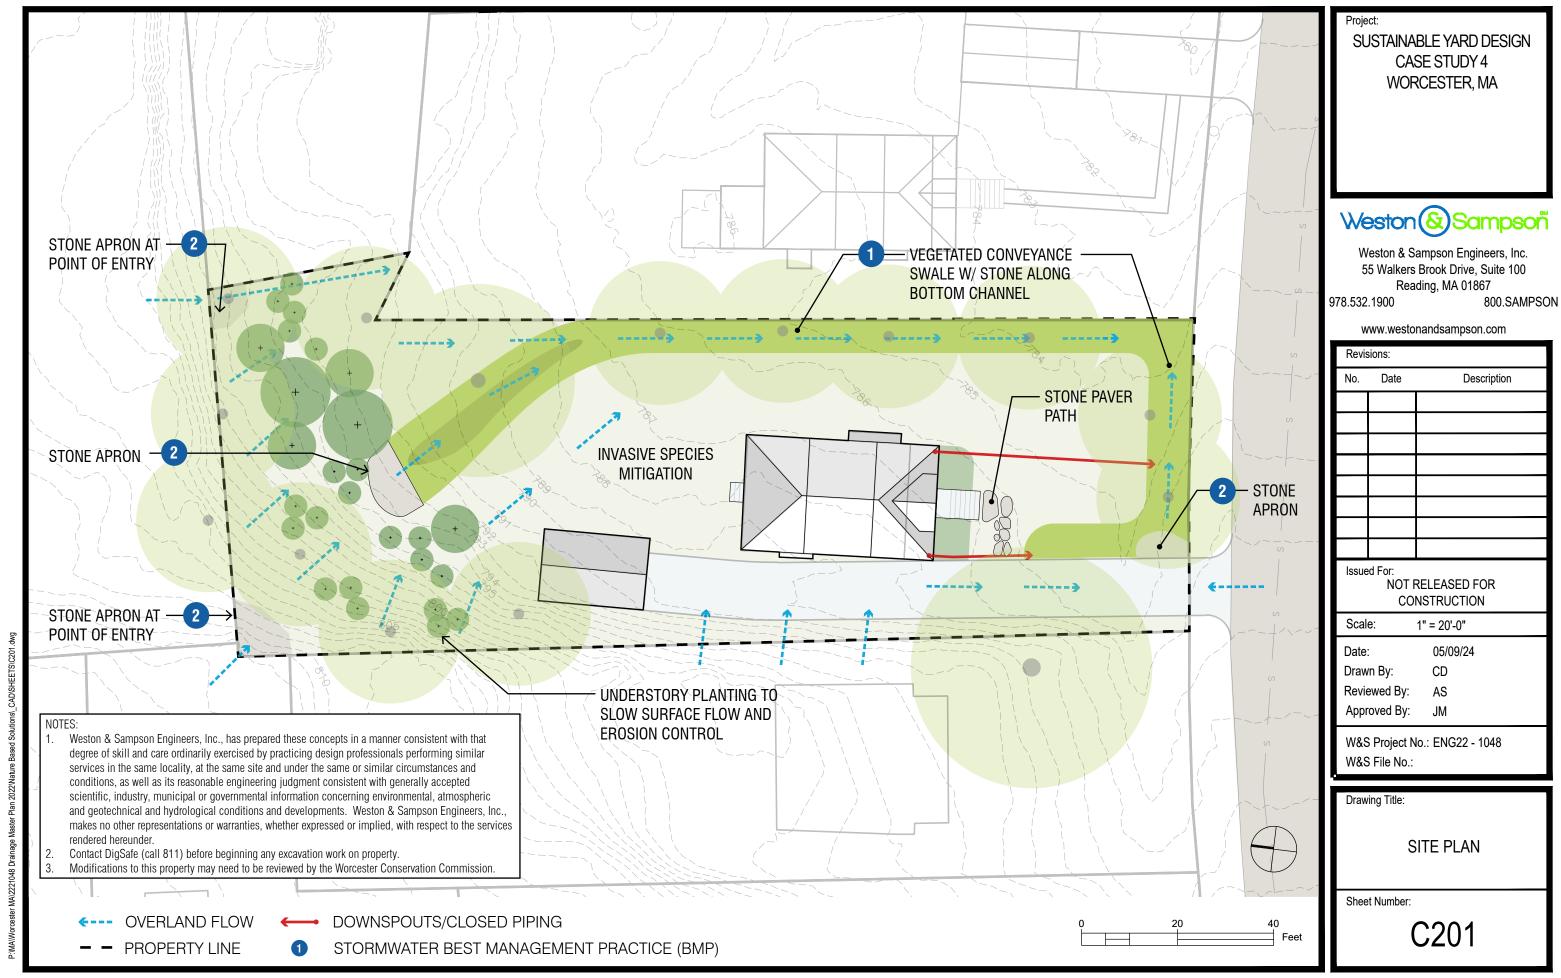

# STORMWATER BEST MANAGEMENT PRACTICE (BMP)





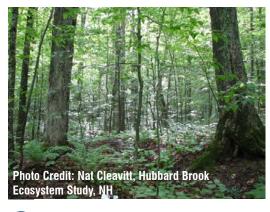

UNDERSTORY PLANTING FOR **EROSION CONTROL** 



# STONE APRON

# **NATURE-BASED SOLUTIONS RESOURCES**

- Easthampton Homeowner's Guide to Do-It-Yourself Stormwater Management Solutions that Improve Community Resilience (easthamptonma.gov/DocumentCenter/ View/3891/Residential-Guide-to-Stormwater-Management---English?bidId=)
- National Fish and Wildlife (www. stormwaterguide.org/static/ HomeownersGuide.pdf)

# **CONSIDERATIONS FOR PLANTING**

Refer to the UMASS Extension Landscape, Nursery and Urban Forestry Program "Plant Selection for Managed Landscapes: Right plant, right place" guidelines below when selecting landscape plants.

Some site conditions to keep in mind when selecting landscape

- light availability, intensity and duration (full sun to deep shade)
- water availability, both quantity and quality
- exposure to wind and temperature extremes
- soil type, drainage, compaction
- hardiness zone
- · competition from existing vegetation
- below ground conditions in urban sites
- above ground wires or obstructions

Aesthetic considerations for plant selection include:

- growth habit, i.e. pyramidal, columnar, spreading, etc.
- season and color of bloom
- foliage color, texture, and shape
- winter interest of bark, fruit, or structure
- benefits to wildlife
- fall color
- longevity

#### PLANT SELECTION BY FUNCTION

- Pollinator Garden (massnrc.org/ppd/)
- Rain Garden (mass.gov/info-details/stormwater-solutionsfor-homeowners)
- Understory Planting for Erosion Control (mass.gov/infodetails/stormwater-solutions-for-homeowners)
- Vegetated Buffer (mass.gov/info-details/stormwatersolutions-for-homeowners)
- Vegetated Swale (mass.gov/info-details/stormwatersolutions-for-homeowners)

#### WHERE TO PURCHASE NATIVE PLANTS

- Grow Native Massachusetts (grownativemass.org/Great-Resources/nurseries-seed)
- Native Plant Trust (nativeplanttrust.org)
- Native Plant Initiative (apcc.org/our-work/education/nativeplant-initiative/)
- Blue Stem Natives (bluestemnatives.com)
- New England Wetland Plants (newp.com)
- <u>Tree Talk Natives</u> (treetalknatives.com)
- American Beauties Native Plants (abnativeplants.com)
- Lady Bird Johnson Wildflower Center (wildflower.org)
- National Nursery and Seed Directory (npn.rngr.net/ resources/directory)
- Arbor Day Foundation (arborday.org)

# **SAMPLE PLANT LIST**

## **VEGETATED CONVEYANCE SWALE**

**Grasses & Perennials** 

- Blue Flag Iris (Iris versicolor)
- Canada Bluejoint (Calamagrostis canadensis)
- Cardinal Flower (Lobelia cardinalis)
- Marsh Marigold (Caltha palustris)
- Swamp Milkweed (Asclepias incarnata)
- Sweet Joe-Pye Weed (Eutrochium purpureum)
- Tussock Sedge (Carex stricta)
- Little Bluestem (Schizachvrium scoparium)
- New England Aster (Aster novae-angliae)
- Pennsylvania Sedge (Carex pensylvanica) Shrubs & Trees
- Sweet Gale (Myrica gale)
- Highbush Blueberry (Vaccinium corymbosum)
- American Witch Hazel (Hamamelis virginiana)

#### **UNDERSTORY PLANTING**

**Grasses & Perennials** 

- Pennsylvania Sedge (Carex pensylvanica)
- Red Columbine (Aquilegia Canadensis)
- Little Bluestem (Schizachyrium scoparium)
- White Turtlehead (Chelone glabra)
- Foamflower (Tiarella cordifolia)

#### Shrubs & Trees

- American Witch Hazel (Hamamelis virginiana)
- Mountain Laurel (Kalmia latifolia)
- Highbush blueberry (Vaccinium corymbosum)
- Serviceberry (Amelanchier spp.)

#### JAPANESE KNOTWEED RESOURCES

- PennState Extension (https://extension.psu. edu/japanese-knotweed)
- Ontario Invasive Plant Council (https:// www.ontarioinvasiveplants.ca/wpcontent/uploads/2016/06/OIPC BMP JapaneseKnotweed.pdf)

SUSTAINABLE YARD DESIGN CASE STUDY 4 WORCESTER, MA



Weston & Sampson Engineers, Inc. 55 Walkers Brook Drive, Suite 100 Reading, MA 01867

978.532.1900

800.SAMPSON

www westonandsampson com

		·							
Revisions:									
No.	Date	Description							
Issue	Issued For: NOT RELEASED FOR CONSTRUCTION								
Scal	Scale:								
Date: 05/09/24									
Draw	n By:	CD							
Revi	ewed By:	AS							
Approved By: JM									
W&S Project No.: ENG22 - 1048 W&S File No.:									

Drawing Title:

SITE PLAN

Sheet Number:

C202

NOTE: Plant suitability is not limited to the sample plant list. A professional horticulturalist, landscape designer, or landscape architect can help in exploring additional species suitable for your site.



## Prepared by Weston & Sampson, May 2024

Item Description	Quantity	Unit	Unit Price	Total Price Notes	Reference Link
Gutters, Downspouts, and Downspout Extensions					
Tatters, Tomopouto, and Bornispout Extensions					
Aluminum Downspout	11	10 FT	\$16.50	\$181.50 Downspout piping typically sold in 10-ft segments. $\sim$ \$16.50 for 2"x3"x10' segment, per Home Depot. Larger size (3"x4"x10') is $\sim$ \$18. Assume 40 ft needed for vertical downspouts, 65 ft for horizontal extensions.	https://www.homedepot.com/p/Amerimax-Home-Products-2-in-x-3-in-x-10-ft-White-Aluminum-Downspout-2601000120/100016183
Aluminum Downspout A-Elbow	2	EA	\$4.25	\$8.50 2"x3" ~\$4.25, 3"x4" ~\$5.25, per Home Depot.	https://www.homedepot.com/p/Amerimax-Home-Products-2-in-x-3-in-White-Aluminum-Downspout-A-Elbow-27064/100065489
Aluminum Gutters	8	16 FT	\$26.00	\$208.00 Assume gutters installed on all four sides of roof; total ~128 ft. Typical sold in 16 ft segments.	https://www.homedepot.com/p/Amerimax-Home-Products-5-in-x-16-ft-White-Aluminum-K-Style-Gutter-2600200192/100013979
Aluminum Gutter End with Drop Outlet	2	EA	\$10.00	\$20.00 One needed for each downspout (2 total)	$\underline{\text{https://www.homedepot.com/p/Amerimax-Home-Products-5-in-White-Aluminum-K-Style-Gutter-End-with-2-in-x-3-in-Drop-Outlet-27010/100086452}$
River Stone Apron at Downspout Outlet	5	CF	\$10.00	\$50.00 Assume 10 sf x 3" deep per apron. 2 aprons needed. Per home depot, one 0.5-cf bag costs ~\$5.	https://www.homedepot.com/p/Vigoro-0-5-cu-ft-Bagged-River-Pebble-Landscape-Rock-54250V/100558618
			Subtotal	\$468.00	
Contingency	20%			\$93.60	
			Total	\$561.60	
Companyone Stude Segment 4 Deals and St. M.					
Conveyance Swale Segment 1 - Back and Side Yard				or 10 F of agrees of the state of arrival and a second of the state of of th	
Stone Apron	27	CF	\$10.00	*270.00 (\$5 per 0.5-cf bag)	
Stone Channel	170	CF	\$10.00	\$1,700.00 Assume 4 ft wide, 3" deep channel along bottom of segment 1 (~170 ft long). Assume same river stone as the stone aprons.	
Mulch - 3"	373	CF	\$2.00	\$746.00 3" depth over ~1490 sf conveyance swale segment.	https://www.homedepot.com/p/Vigoro-2-cu-ft-Bagged-Premium-Black-Wood-Mulch-52050197/205606445
Bioretention Soil Mix - 18"	83	CY	\$30.00	2,490.00 18" depth over $1490$ sf conveyance swale segment.	Other projects
Coarse Sand - 1"	5	CY	\$55.00	\$275.00 1" depth over ~1490 sf conveyance swale segment.	Other projects
Pea Gravel - 3"	14	CY	\$86.00	\$1,204.00 3" depth over ~1490 sf conveyance swale segment.	Other projects
3/4" Crushed Stone - 8"	37	CY	\$50.00	\$1,850.00 8" depth over ~1490 sf conveyance swale segment.	https://www.aawillmaterials.com/store/3-4-Crushed-Stone-p281934456
Geotextile Fabric	2340	SF	\$0.10	$^{\sim}1490$ sf total area of conveyance swales, plus assume an additional 5 ft along the 170-ft length of swale segment to line the sides. Assume $0.10$ per sf based on multiple Home Depot options.	
Erosion Control/Restoration Mix for Moist Sites	3	LBS	\$39.00	\$117.00 1250 sf per lb, minimum order 3 lbs. ~1490 sf total.	https://newp.com/product/new-england-erosion-control-restoration-mix-for-detention-basins-and-moist-sites/
Contingency	20%		Subtotal	\$8,886.00 \$1,777.20 \$10,663.20	
Conveyance Swale Segment 2 - Front Yard					
Stone Apron	12.5	CF	\$10.00	\$125.00 ~50 sf apron at start of swale. Assume 3" depth. Assume same river stone as the aprons for downspout outlets (\$5 per 0.5-cf bag)	5
Stone Channel	70	CF	\$10.00	Assume 4 ft wide, 3" deep channel along bottom of segment 1 (~70 ft long). Assume same river stone as the stone aprons.	•
Mulch - 3"	129	CF	\$2.00	\$258.00 3" depth over ~515 sf conveyance swale segment.	https://www.homedepot.com/p/Vigoro-2-cu-ft-Bagged-Premium-Black-Wood-Mulch-52050197/205606445
Bioretention Soil Mix - 18"	29	CY	\$30.00	\$870.00 18" depth over ~515 sf conveyance swale segment.	Other projects
Coarse Sand - 1"	2	CY	\$55.00	\$110.00 1" depth over ~515 sf conveyance swale segment.	Other projects
Pea Gravel - 3"	5	CY	\$86.00	\$430.00 3" depth over ~515 sf conveyance swale segment.	Other projects
3/4" Crushed Stone - 8"	13	CY	\$50.00	\$650.00.8" depth over ~515 sf conveyance swale segment	https://www.aawillmaterials.com/store/3-4-Crushed-Stone-n281934456
Geotextile Fabric	865	SF	\$0.10	\$86.50 *515 sf total area of conveyance swales, plus assume an additional 5 ft along the 70-ft length of swale segment to line the sides. Assume \$0.10 per sf based on multiple Home Depot options.	
Erosion Control/Restoration Mix for Moist Sites	3	LBS	\$39.00	\$117.00 1250 sf per lb, minimum order 3 lbs. ~515 sf total.	https://newp.com/product/new-england-erosion-control-restoration-mix-for-detention-basins-and-moist-sites/
Contingency	20%		Subtotal	\$3,346.50 \$669.30 \$4,015.80	



#### Prepared by Weston & Sampson, May 2024

Item Description	Quantity	Unit	Unit Price	Total Price	Notes	Reference Link
Understory Plantings & Stone Aprons at Points of Entry - Backyard						
Tree Plantings	5	EA	\$350.00	\$1,750.0	Assume 2-2.5" caliper.	
						NEWP: https://newp.com/catalog/shrubs/
Shrub Plantings	21	EA	\$12.00	\$252.0	) 1 gal buckets ~\$12 per NEWP, other plant size options available, see links to right	NPT: https://newfs-society.s3.amazonaws.com/documents/2024-05-
						02 NPT 2024 Plants Price Availability List.pdf
Stone Aprons	40	CF	\$10.00	\$400.0	2160 sf (two aprons) at points of entry. Assume 3" depth. Assume same river stone as the aprons for downspout outlets (\$5 per 0.5-cf bag)	
			Subtotal	\$2,402.0		
Contingency	20%		1	\$480.4		
			Total	\$2,882.4		
Front Walkway						
Stone Pavers	1	LS	\$900.00	\$900.0	Assume one 60 sf pallet of stone pavers needed for walkway.	https://www.homedepot.com/p/Southwest-Boulder-Stone-14-in-x-12-in-x-2-in-60-sq-ft-Storm-Mountain-
			0.11.1		_	Natural-Flagstone-for-Landscape-Gardens-and-Pathways-02-0221/312655103
Constitution of the Consti	200/		Subtotal	\$900.0		
Contingency	20%		Total	\$180.0		
			iotai	\$1,080.0		
TOTAL COST				\$19,203.0		

#### Notes:

- 1. Costs are for materials only and exclude labor costs (contractor).
- 2. Costs are presented in 2024 US dollars and include a 20% contingency.
- 3. Costs are based on pricing from Home Depot, New England Wetland Plants, Inc., Native Plant Trust, and reference pricing from other projects

<sup>4.</sup> Weston & Sampson Engineers, Inc. has no control over the cost of labor, materials, equipment or services furnished by others, or any methods of determining prices, or competitive bidding or market conditions when the project will be constructed. Weston & Sampson Engineers, Inc. cannot and does not guarantee that a contractor's bids or actual construction costs will not vary from cost estimates prepared. If property owner desires greater assurance as to probable construction cost, property owner should obtain a quote from a contractor.