CLASSROOM RENOVATIONS CHANDLER MAGNET ELEMENTARY SCHOOL

FOR

WORCESTER PUBLIC SCHOOLS

525 CHANDLER ST WORCESTER, MA

MAY 31, 2023



CHANDLER MAGNET ELEMENTARY


TEL: (508)755-6134


FAX: (508) 754-4661

ARCHITECT: NAULT ARCHITECTS, INC.

71 HOPE AVENUE

■ WORCESTER, MA 01603

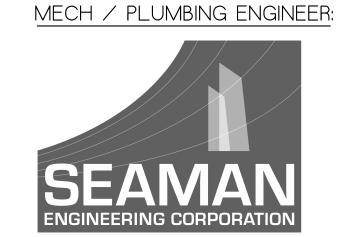

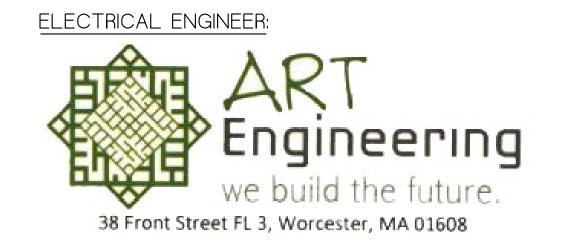

LIST OF DRAWINGS

A1 - DEMOLITION PLAN AND DETAILS

E1.0 - ELECTRICAL FLOOR PLANS

COVER SHEET

JOB NUMBER: NAULT #1676

CLASSROOM RENOVATIONS CHANDLER MAGNET ELEM. SCHOOL

WORCESTER PUBLIC SCHOOLS


NAULT ARCHITECTS, INC.


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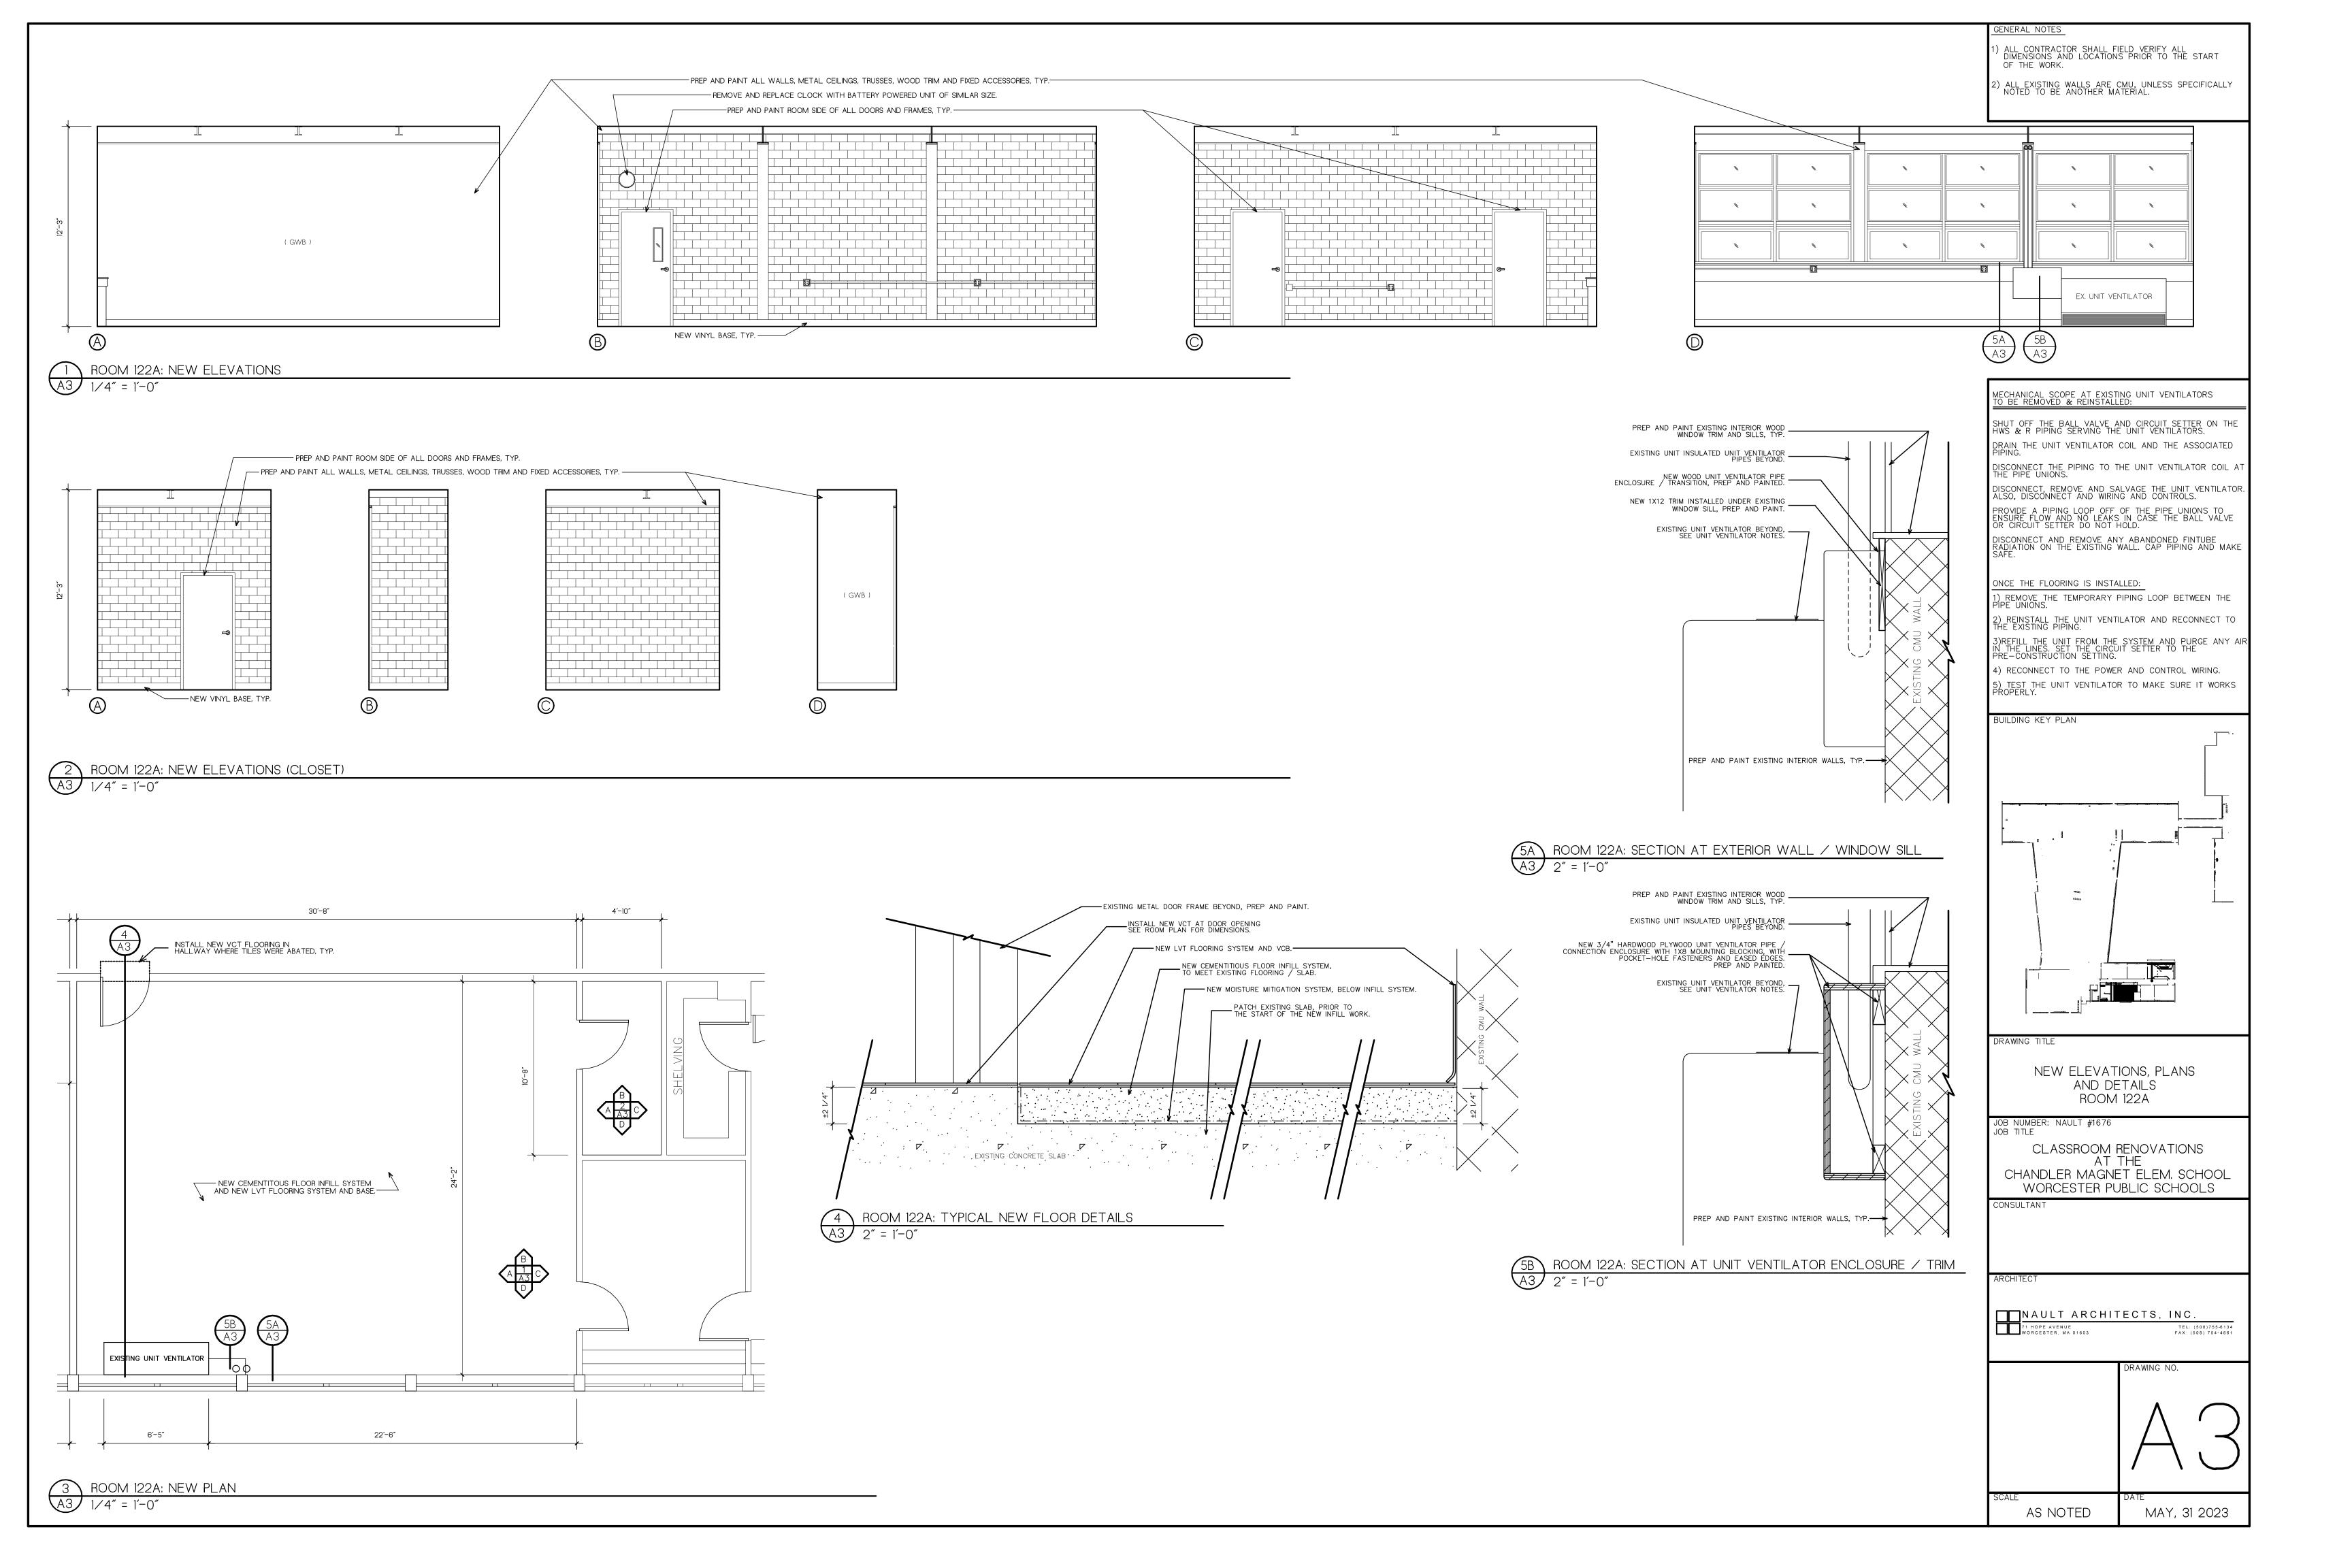
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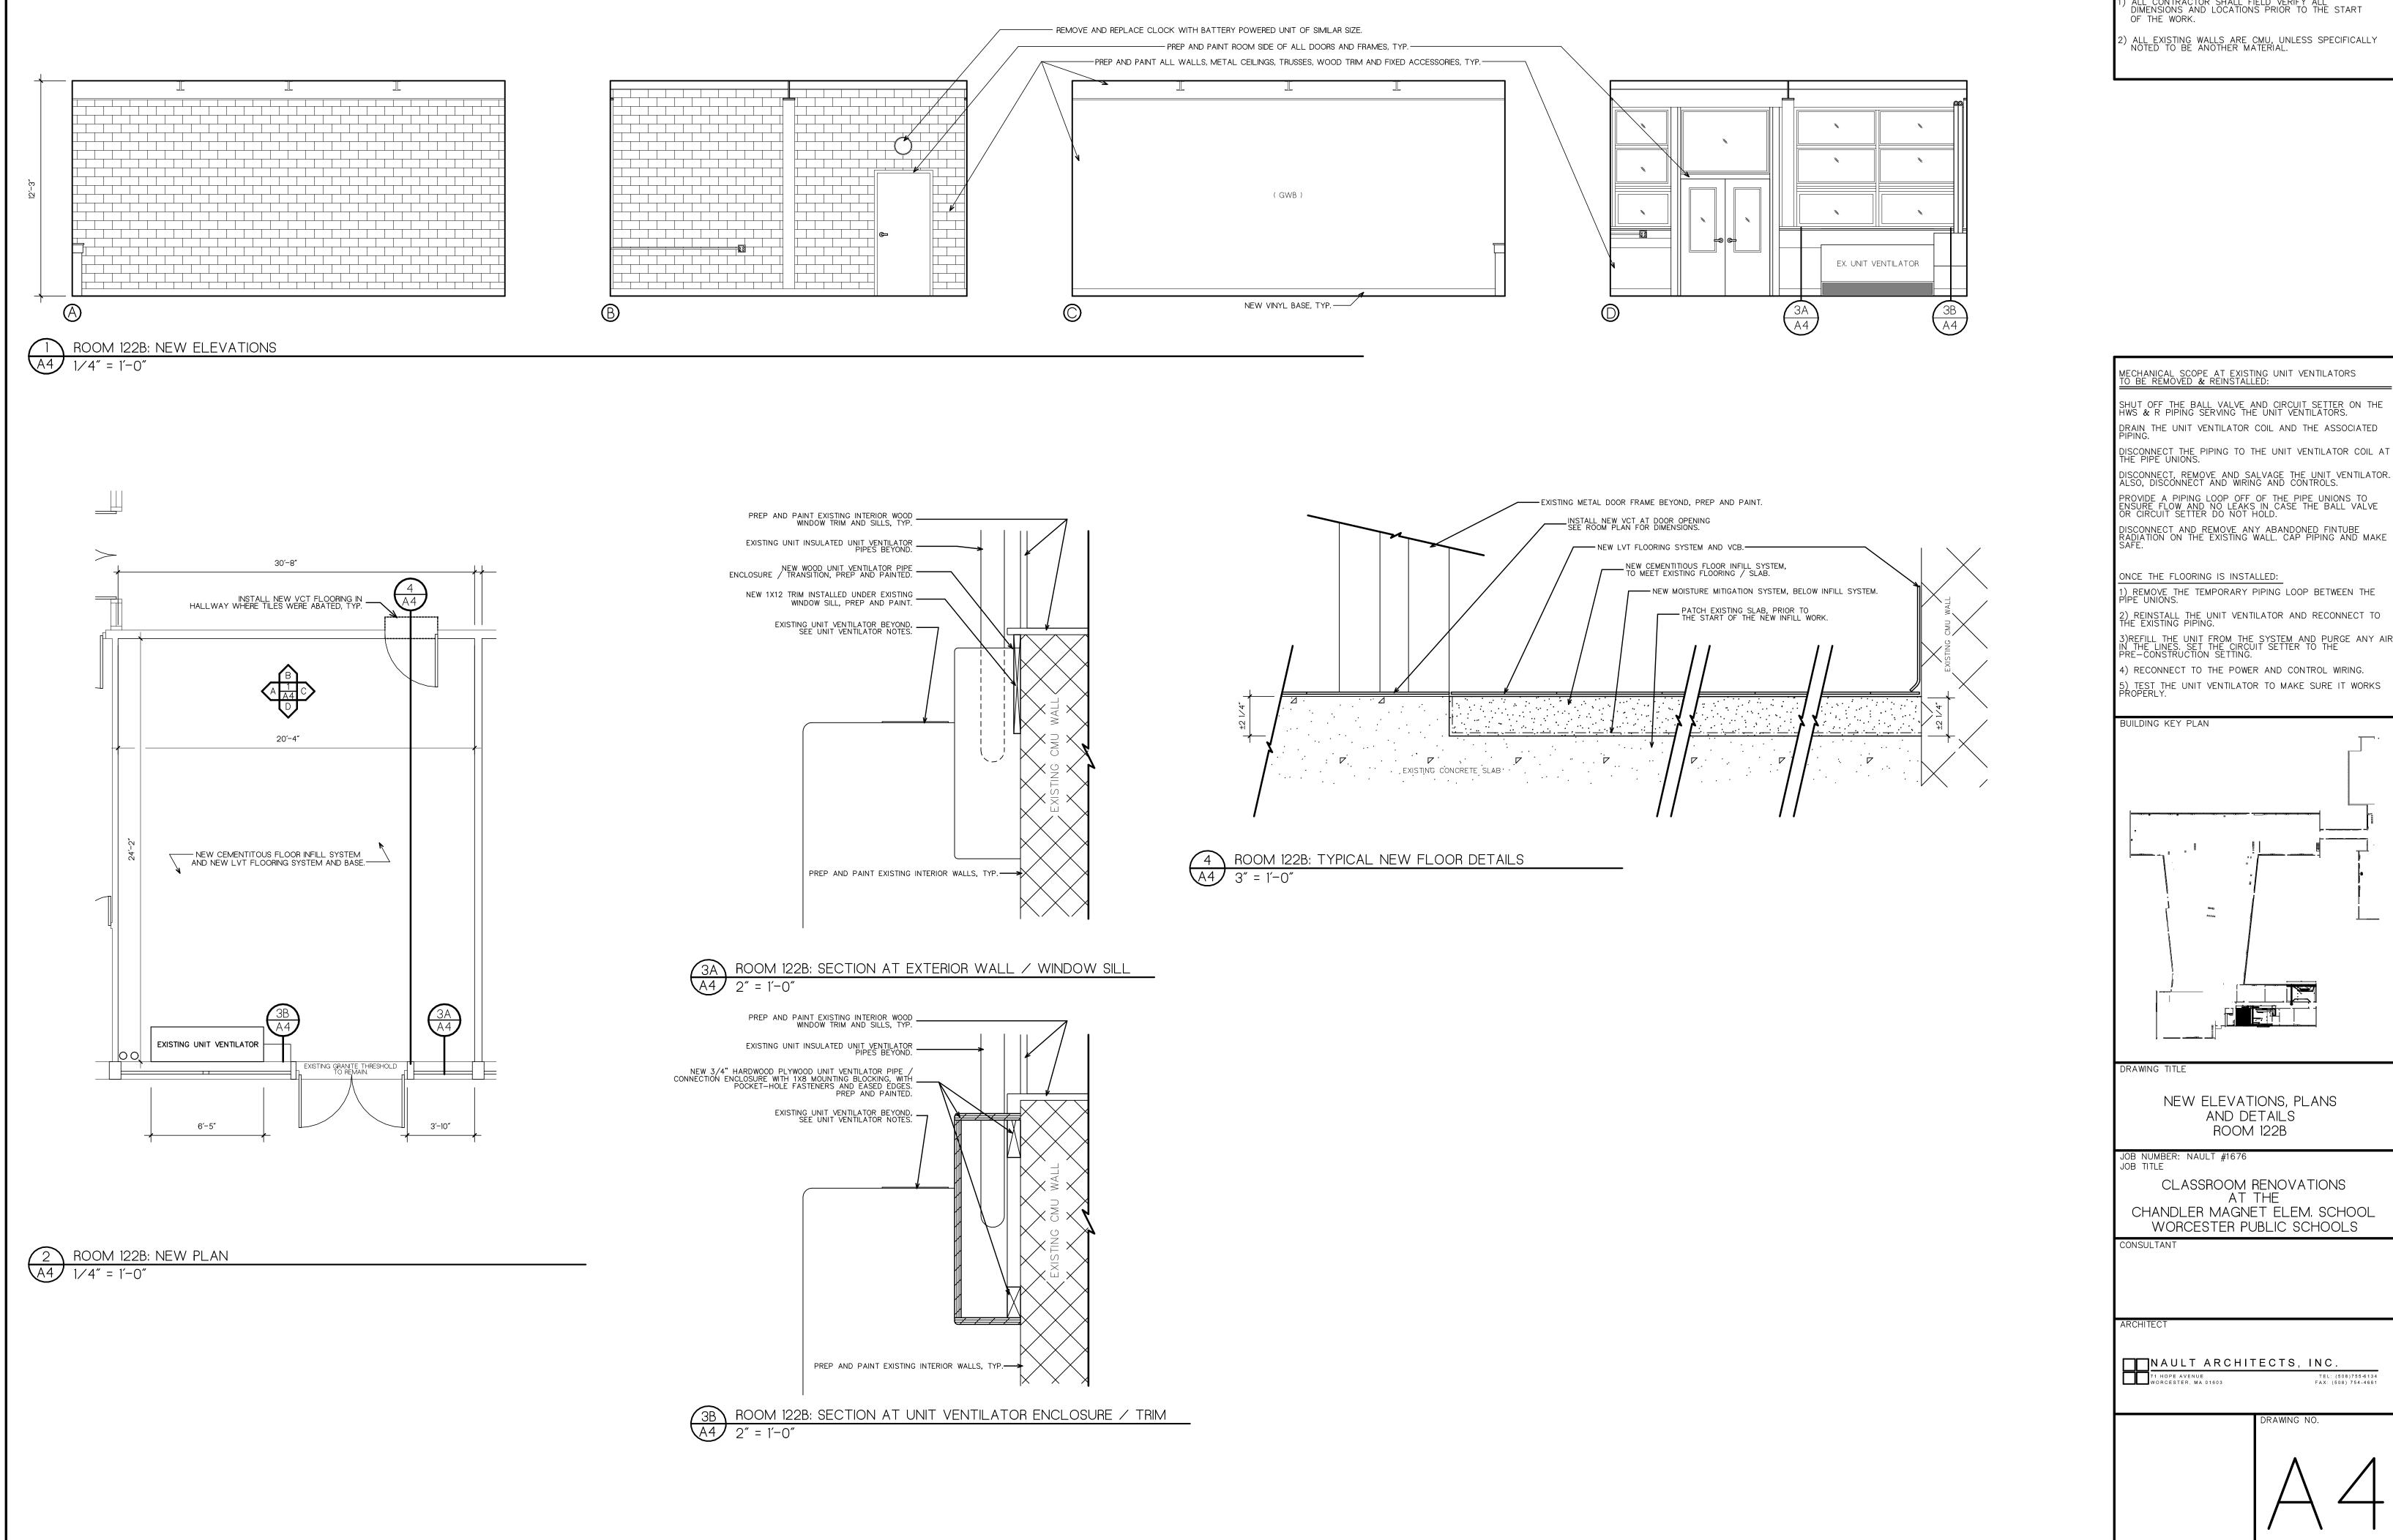
MAY 31, 2023

AS NOTED





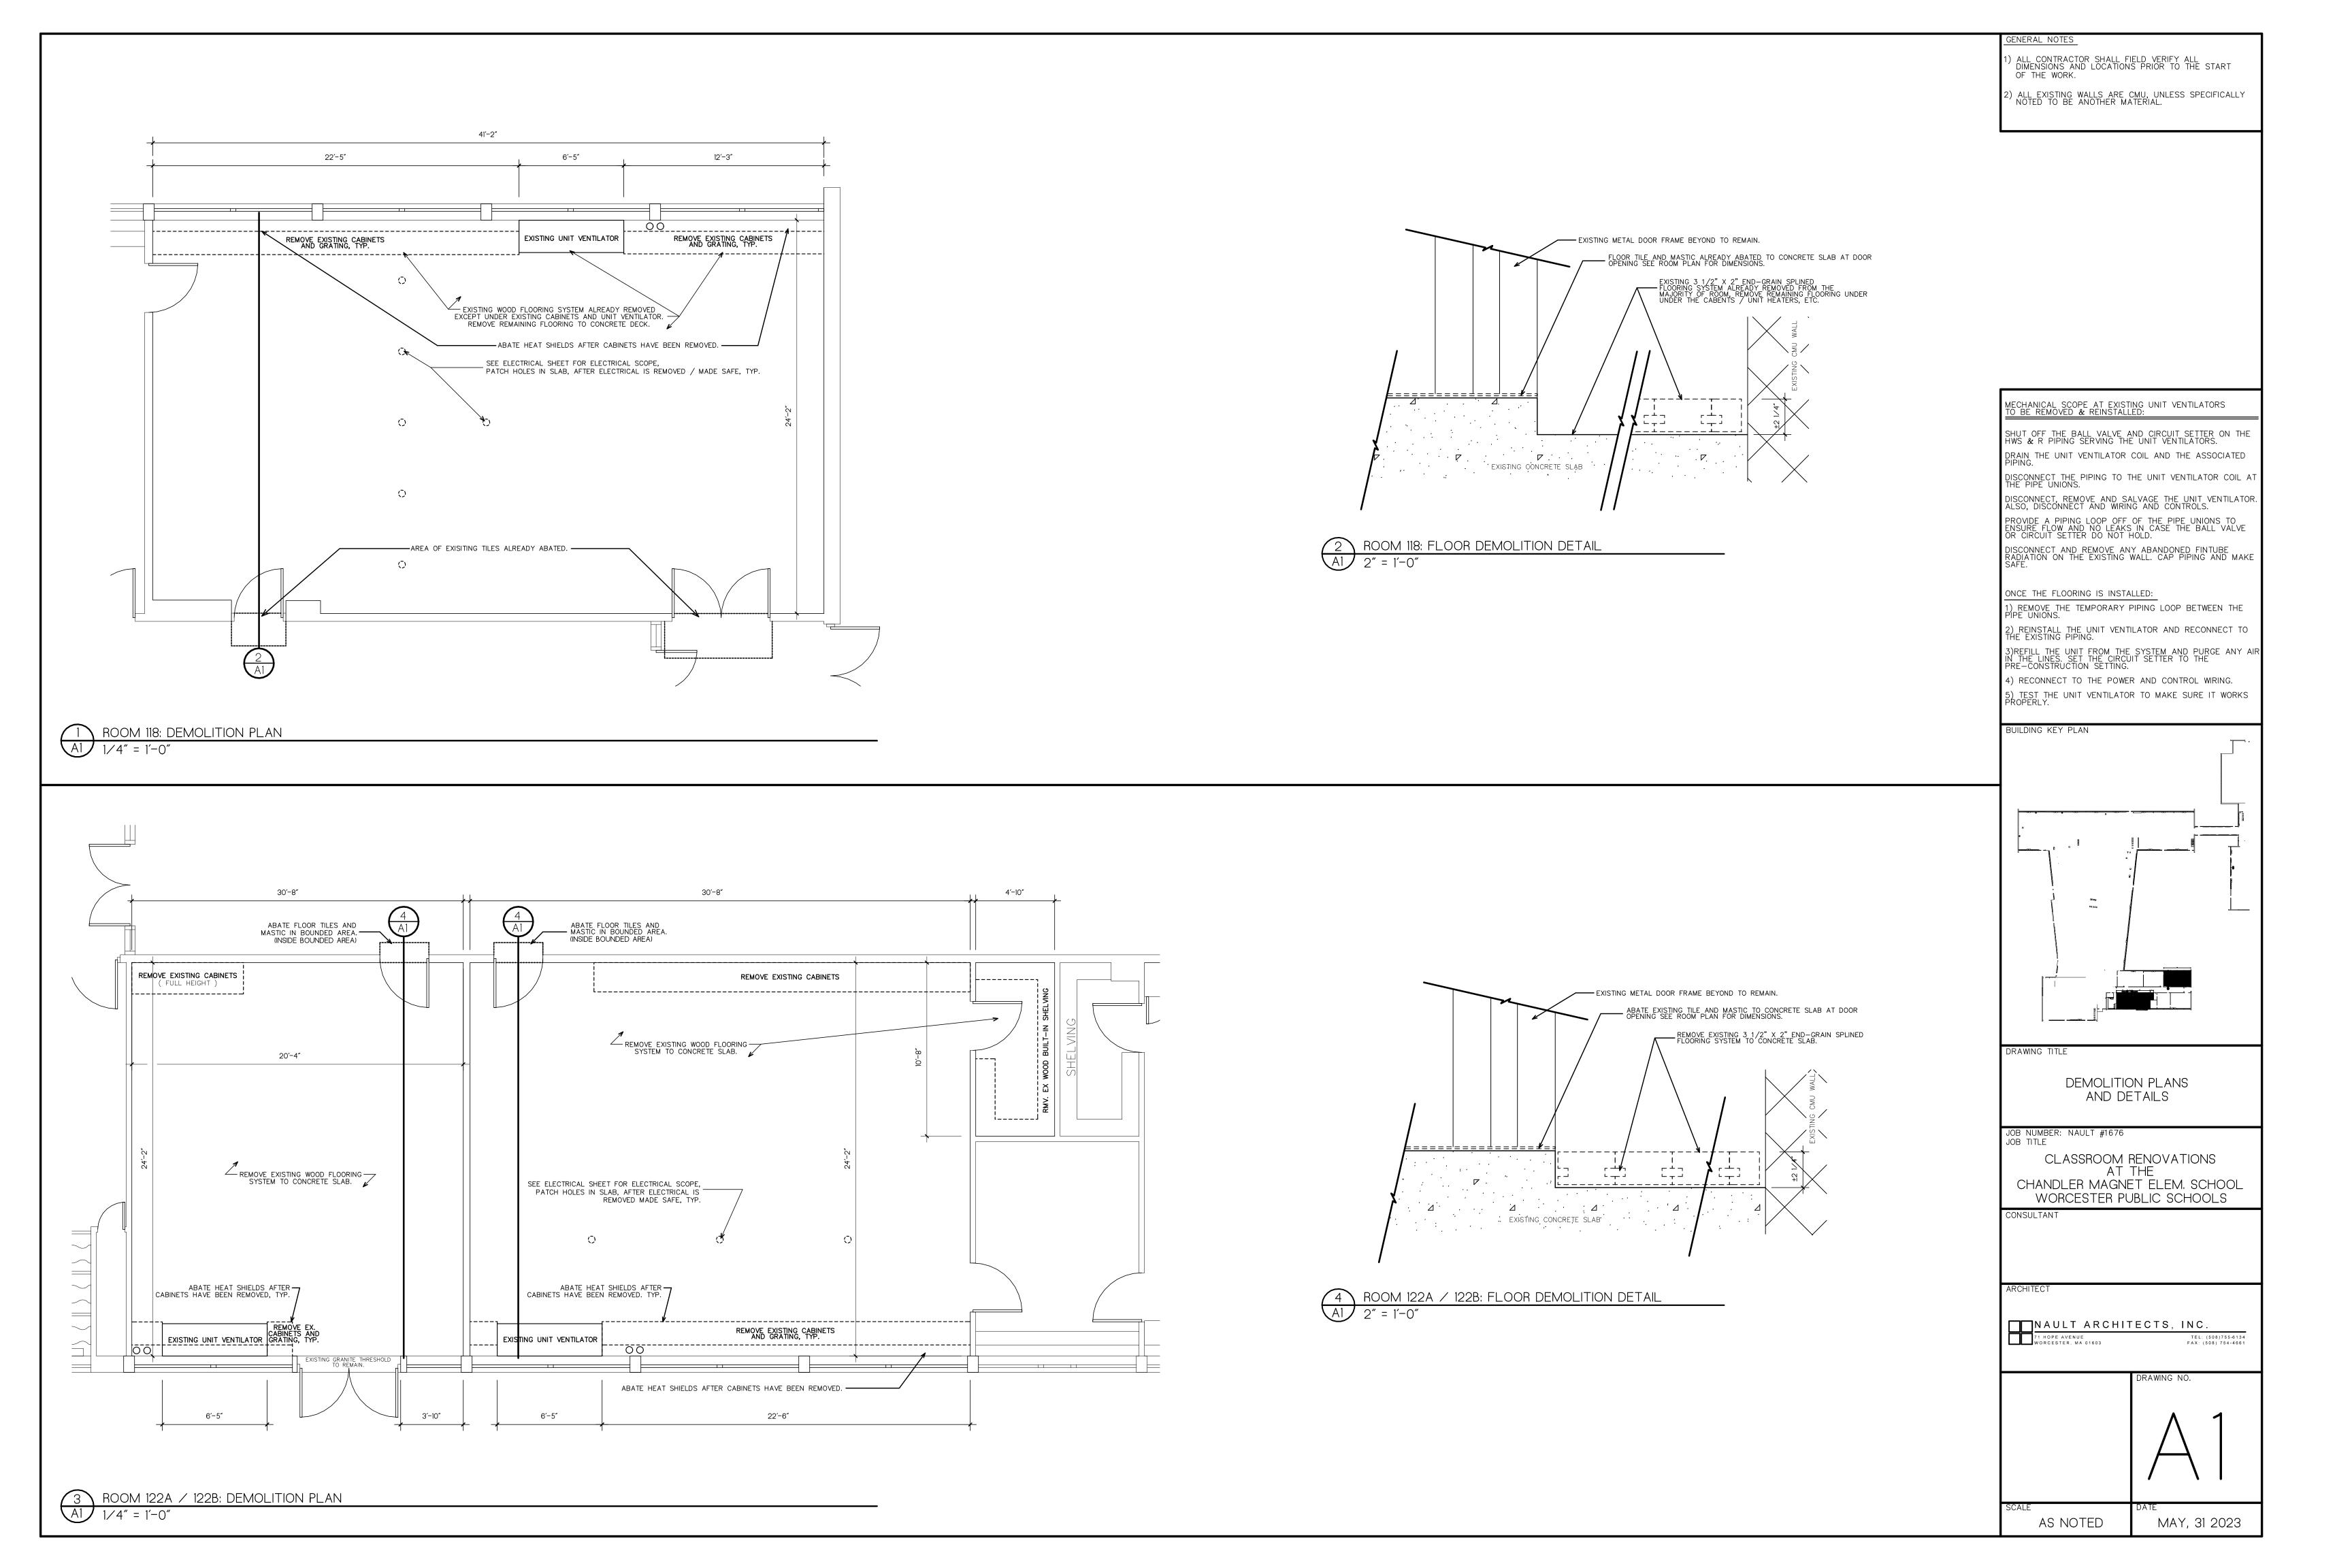

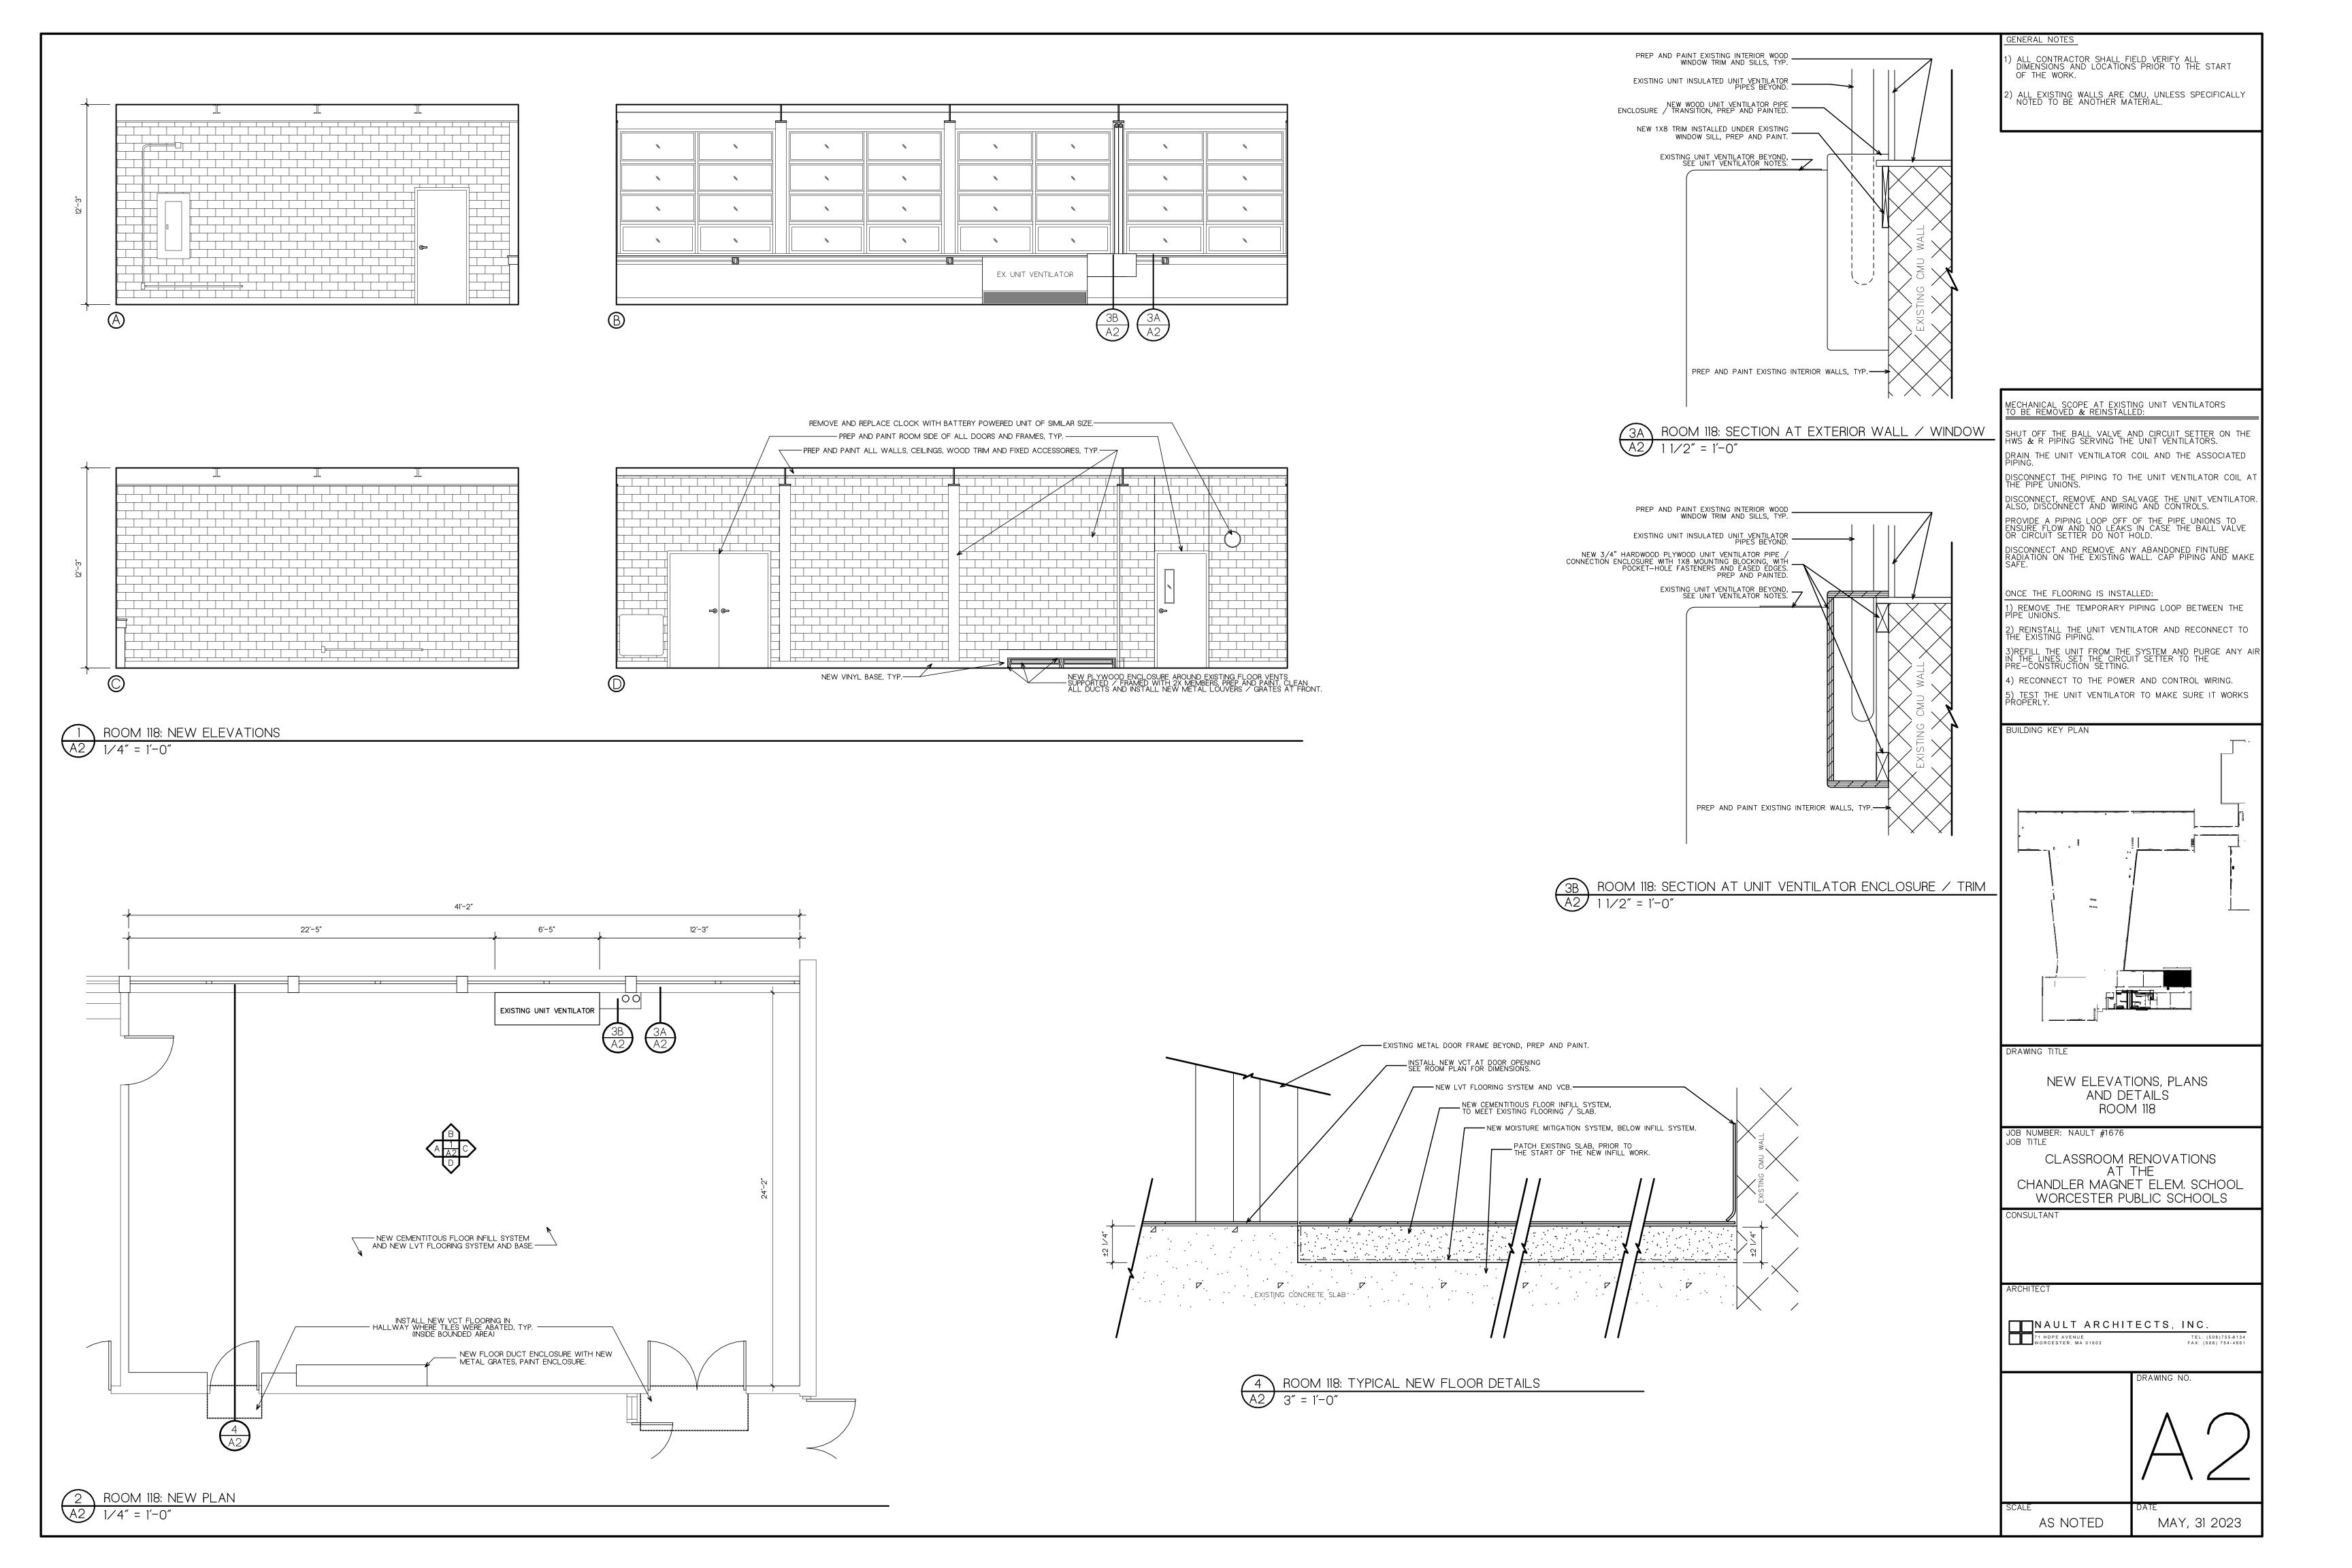

NAULT ARCHITECTS, INC. AS NOTED MAY, 31 2023

NEW ELEVATIONS, PLANS

AND DETAILS

ROOM 122B

CLASSROOM RENOVATIONS AT THE CHANDLER MAGNET ELEM. SCHOOL WORCESTER PUBLIC SCHOOLS

) ALL CONTRACTOR SHALL FIELD VERIFY ALL DIMENSIONS AND LOCATIONS PRIOR TO THE START OF THE WORK.

MECHANICAL SCOPE AT EXISTING UNIT VENTILATORS TO BE REMOVED & REINSTALLED:

ONCE THE FLOORING IS INSTALLED:

DRAWING TITLE


CONSULTANT

DRAIN THE UNIT VENTILATOR COIL AND THE ASSOCIATED PIPING.

1) REMOVE THE TEMPORARY PIPING LOOP BETWEEN THE PIPE UNIONS.


2) REINSTALL THE UNIT VENTILATOR AND RECONNECT TO THE EXISTING PIPING.

RECONNECT TO THE POWER AND CONTROL WIRING.

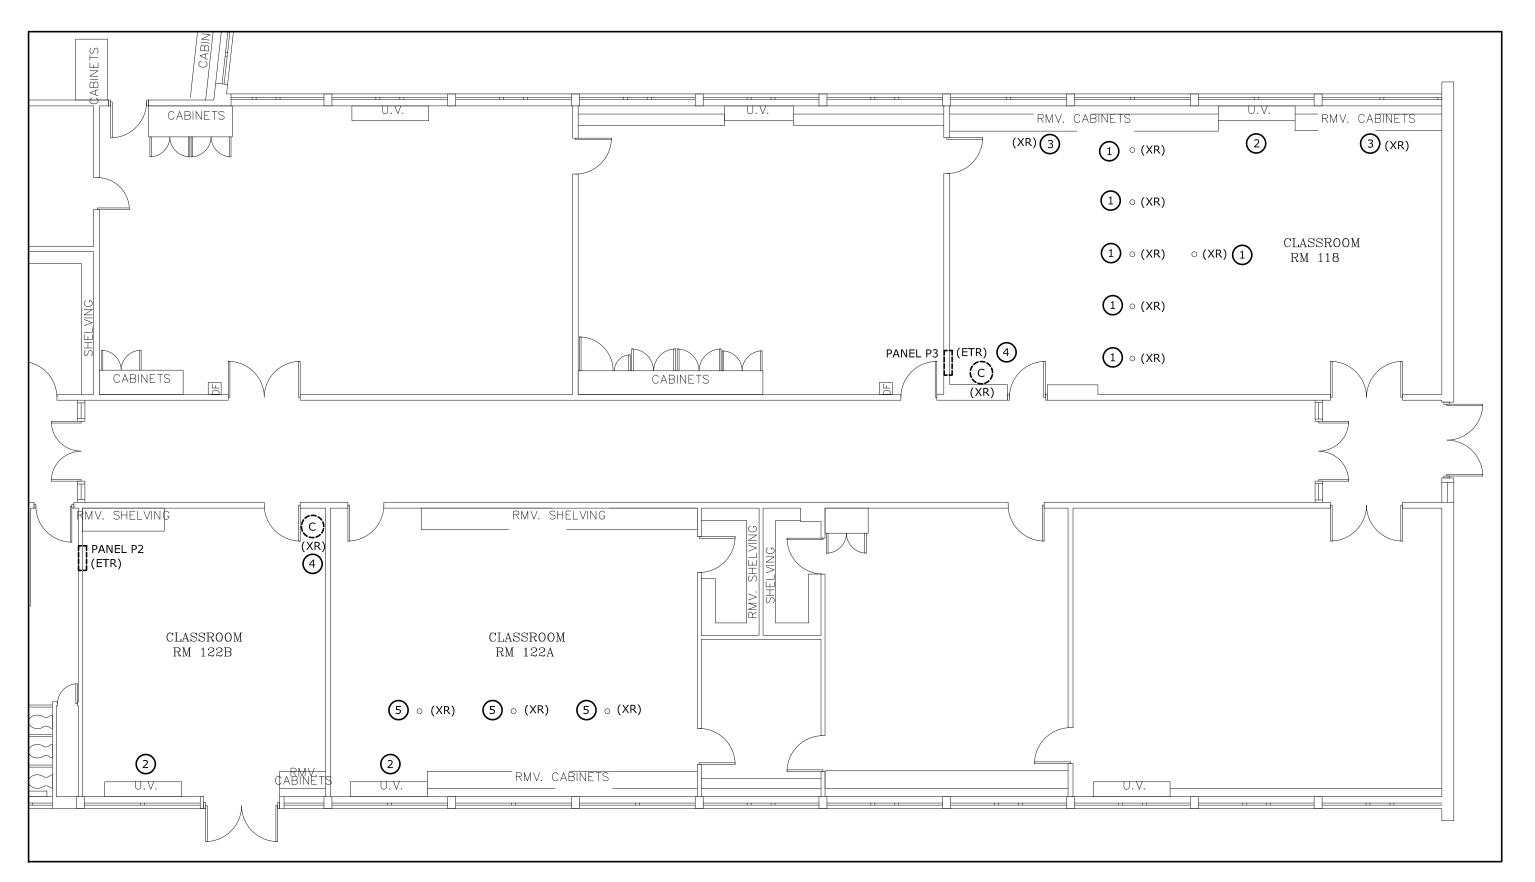

Electrical - Demolition Plan

1/8" = 1'-0"

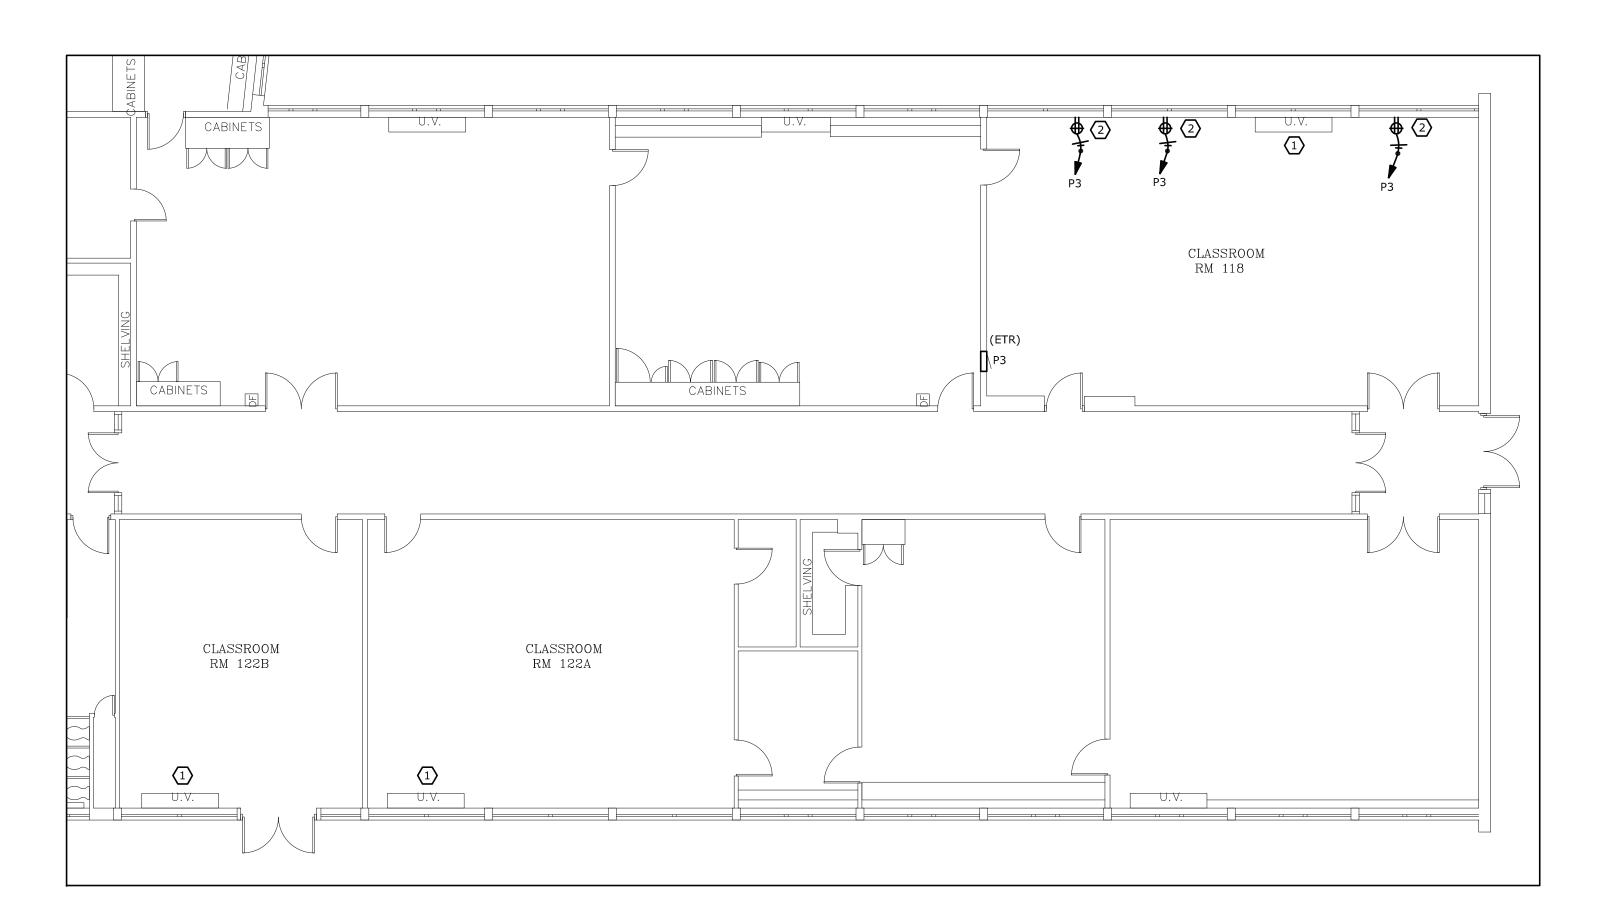

2 Electrical - Proposed Plan

1/8" = 1'-0"

GENERAL NOTES:

) THE CONTRACTOR SHALL FIELD VERIFY ALL DIMENSIONS AND LOCATIONS PRIOR TO THE START OF THE PROJECT.


KEYED NOTES FOR ELECTRICAL DEMOLITION PLAN

- TRACE CIRCUITS FEEDING THE EXISTING FLOOR BOXES, AND LOCKOUT/TAGOUT. REMOVE ABANDONED CIRCUIT CONDUCTORS FROM EACH FLOOR BOX TO PANEL P3. REVISE PANEL CIRCUIT DIRECTORY TO INDICATE CIRCUIT BREAKERS ARE NOW SPARE. FLUSH FLOOR BOXES ARE TO REMAIN AND BE COVERED BY FLOOR IN-FILL. TYPICAL FOR SIX (6).
- TRACE CIRCUIT FEEDING THE EXISTING UNIT VENTILATOR, AND LOCKOUT/TAGOUT. DISCONNECT ELECTRICAL POWER TO EXISTING UNIT VENTILATOR. MAINTAIN CIRCUITRY TO RECONNECT AFTER NEW FLOOR IS COMPLETED.
- TRACE CIRCUITS FEEDING THE EXISTING CABINET SURFACE WIREMOLD, AND LOCKOUT/TAGOUT. DISCONNECT AND REMOVE EXISTING SURFACE WIREMOLD AND RECEPTACLES, AND BRANCH CIRCUIT CONDUIT AND WIRING FROM THE FACE OF EXISTING CABINETS. REVISE PANEL CIRCUIT DIRECTORY TO INDICATE CIRCUIT BREAKERS ARE NOW SPARE.
- TRACE THE CIRCUIT FEEDING THE EXISTING SURFACE WALL CLOCK AND LOCKOUT/TAGOUT. DISCONNECT AND REMOVE THE EXISTING SURFACE WALL CLOCK. MARK THE CIRCUIT NUMBER ON THE CONDUCTORS. PROVIDE WIRE NUTS ON DISCONNECTED CIRCUIT CONDUCTORS. PROVIDE A BLANK SURFACE WALL PLATE ON THE EXISTING OUTLET BOX.
- TRACE CIRCUITS FEEDING THE EXISTING FLOOR BOXES, AND LOCKOUT/TAGOUT. REMOVE ABANDONED CIRCUIT CONDUCTORS FROM EACH FLOOR BOX TO PANEL P2. REVISE PANEL CIRCUIT DIRECTORY TO INDICATE CIRCUIT BREAKERS ARE NOW SPARE. IF FLOOR BOX COVERS CANNOT BE OPENED, DISCONNECT BRANCH CIRCUIT CONDUCTORS AND CUT AT CONDUIT ENTRANCE INTO PANEL. FLUSH FLOOR BOXES ARE TO REMAIN AND BE COVERED BY FLOOR IN-FILL. TYPICAL FOR THREE (3).

KEYED NOTES FOR ELECTRICAL PROPOSED PLAN

- RECONNECT REINSTALLED UNIT VENTILATOR FROM DISCONNECTED MAINTAINED CIRCUIT. REMOVE LOCKOUT/TAGOUT AND CLOSE CIRCUIT BREAKER WHEN INSTRUCTED BY HVAC INSTALLER.
- PROVIDE SURFACE OUTLET BELL BOXES AND QUAD RECEPTACLES WITH A TWO-GANG STAINLESS PLATE AND 3/4" CONDUIT WITH THREE (3) #12 THHN AWG COPPER CONDUCTORS TO EXISTING PANEL P3 AS A DEDICATED CIRCUIT. CONNECT NEW CIRCUITS TO 20A 1-POLE CIRCUIT BREAKERS THAT BECAME SPARE DUE TO THE REMOVAL OF THE FLOOR BOX OUTLETS. REVISE CIRCUIT PANEL DIRECTORY TO REFLECT NEW DEDICATED OUTLETS. TYPICAL FOR THREE (3) LOCATIONS.

BUILDING KEY PLAN

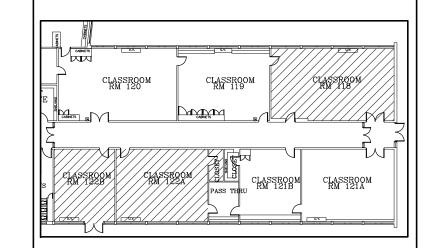

DRAWING TITLE

ELECTRICAL FLOOR PLANS

JOB NUMBER: NAULT #1676
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DRAWING NO.

E1.0

AS NOTED

MAY 31, 2023