

LOCATION PLAN  
SCALE: 1"=500'

SHEET INDEX

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# CITY OF WORCESTER



## KELLEY SQUARE PYLON WORCESTER, MA 01604

SEPTEMBER 18, 2025

## BID DOCUMENTS



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1.1 TOPOGRAPHICAL INFORMATION SHOWN WAS DIGITIZED FROM THE CONSTRUCTION PLAN SET "KELLEY SQUARE SAFETY IMPROVEMENTS ON MADISON STREET AND VERNON STREET" BY MASSDOT HIGHWAY DIVISION ON JULY 15, 2019. THE INFORMATION WAS GEOGRAPHICALLY REFERENCED USING AutoCADs GEOLOCATION FEATURE.

1.2 THE LOCATIONS OF EXISTING UNDERGROUND UTILITIES ARE SHOWN IN AN APPROXIMATE WAY ONLY AND HAVE NOT BEEN INDEPENDENTLY VERIFIED BY THE OWNER OR ITS REPRESENTATIVE. THE CONTRACTOR SHALL DETERMINE THE EXACT LOCATION OF ALL EXISTING UTILITIES BEFORE COMMENCING WORK, AND AGREES TO BE FULLY RESPONSIBLE FOR ANY AND ALL DAMAGES WHICH MIGHT BE OCCASIONED BY THE CONTRACTOR'S FAILURE TO EXACTLY LOCATE AND PRESERVE ANY AND ALL UNDERGROUND UTILITIES. THE CONTRACTOR SHALL DIG TEST PITS WITH THE LOCATIONS BEING APPROVED BY THE ENGINEER PRIOR TO COMMENCEMENT OF WORK TO EXACTLY LOCATE EXISTING UTILITIES.

1.3 WHERE AN EXISTING UTILITY IS FOUND TO CONFLICT WITH THE PROPOSED WORK, THE LOCATION, ELEVATION AND SIZE OF THE UTILITY SHALL BE ACCURATELY DETERMINED WITHOUT DELAY BY THE CONTRACTOR AND THE INFORMATION FURNISHED TO THE ENGINEER FOR RESOLUTION OF THE CONFLICT.

1.4 THE CONTRACTOR SHALL MAKE ALL ARRANGEMENTS FOR THE ALTERATION AND ADJUSTMENT OF ELECTRIC AND ANY OTHER PRIVATE UTILITIES BY THE UTILITY OWNER. ANY ALTERATIONS SHALL BE INCIDENTAL TO THE PROJECT.

1.5 AREAS OUTSIDE THE LIMITS OF PROPOSED WORK DISTURBED BY THE CONTRACTOR'S OPERATIONS SHALL BE RESTORED BY THE CONTRACTOR TO THEIR ORIGINAL CONDITION AT THE CONTRACTOR'S EXPENSE.

1.6 THE TERM "PROPOSED (PROP)" INDICATES WORK TO BE CONSTRUCTED USING NEW MATERIALS OR, WHERE APPLICABLE, RE-USING EXISTING MATERIALS IDENTIFIED AS "REMOVE AND RESET (R&R)".

1.7 ALL EXCESS MATERIAL FROM THE EXCAVATION PROCESS SHALL BE REUSED ON SITE OR REMOVED FROM THE SITE AND DISPOSED OF IN A LEGAL AND PROPER MANNER.

1.8 THE CONTRACTOR SHALL CALL DIGSAFE AT 1-888-344-7233 AT LEAST 72 HOURS, SATURDAYS, AND HOLIDAYS EXCLUDED, PRIOR TO EXCAVATING AT ANY LOCATION. A COPY OF THE DIGSAFE PROJECT REFERENCE NUMBER(S) SHALL BE GIVEN TO THE TOWN PRIOR TO EXCAVATION.

1.9 THE CONTRACTOR SHALL VERIFY BY TEST PIT, THE LOCATION OF EXISTING UTILITIES WHICH MAY CONFLICT WITH THE PROPOSED FOUNDATION. ANY FIELD ADJUSTMENTS REQUIRED WILL BE MADE AS APPROVED OR DIRECTED BY THE ENGINEER. ONLY AFTER THE CONTRACTOR VERIFIES ELEVATIONS FOR THE CONSTRUCTABILITY OF THE FOUNDATION, THE MATERIALS SHALL BE ORDERED.

1.10 THE CONTRACTOR SHALL BE AWARE THAT ONLY CITY PERSONNEL ARE ALLOWED TO OPERATE WATER GATES AND HYDRANTS. ANY REQUESTS TO OPERATE THE HYDRANTS SHALL BE COORDINATED THROUGH THE CITY.

1.11 THE CONTRACTOR SHALL COORDINATE ANY WORK FOR THE PROJECT WITH ALL ADJACENT/CONCURRENT PROJECTS AND CONTRACTORS.

1.12 THE CONTRACTOR SHALL INSTALL PRIOR TO COMMENCEMENT OF WORK, MAINTAIN, AND REMOVE AT THE END OF THE PROJECT INLET SEDIMENT CONTROL BAGS IN ALL CATCH BASINS, WITHIN OR ADJACENT TO THE PROJECT LIMITS. THE CONTRACTOR SHALL ALSO MAINTAIN SILT FENCE AND COMPOST FILTER TUBES AS SHOWN ON THE PLANS THROUGHOUT THE DURATION OF THE PROJECT AND REMOVE AT THE END.

1.13 ANY GRASS AREAS DISTURBED BY THE WORK SHALL BE RESTORED WITH LOAM AND SEED.

1.14 ANY LANDSCAPED AREAS DISTURBED BY THE WORK SHALL BE RESTORED TO EXISTING CONDITIONS WITH EXISTING OR NEW GROUND COVER MATERIALS AS DIRECTED BY THE ENGINEER. ANY PLANTS, SHRUBS, OR FLOWERS DISTURBED BY THE WORK SHALL BE RESET TO EXISTING CONDITIONS OR REPLACED WITH NEW PLANTS, SHRUBS, OR FLOWERS AS DIRECTED BY THE ENGINEER. ALL WORK TO RESTORE LANDSCAPE AREAS, NEW GROUND COVER MATERIALS, NEW PLANTS, NEW SHRUBS, OR NEW FLOWERS REQUIRED BY THE ENGINEER SHALL BE INCIDENTAL TO THE PROJECT.

1.15 THE STRUCTURAL DRAWINGS SHALL BE USED IN CONJUNCTION WITH ALL OTHER CONTRACT DRAWINGS AND SPECIFICATIONS. REFER TO CIVIL, ARCHITECTURAL, AND ELECTRICAL DRAWINGS FOR LOCATION, DIMENSIONS, AND DETAILS

1.16 THE CONTRACTOR IS RESPONSIBLE FOR CHECKING, COORDINATING AND VERIFYING ALL DIMENSIONS IN THE FIELD PRIOR TO COMMENCING WORK. THE CONTRACTOR SHALL IMMEDIATELY REPORT ANY DISCREPANCY TO THE ENGINEER AS A REQUEST FOR INFORMATION (RFI) BEFORE PROCEEDING WITH WORK.

1.17 THE CONTRACTOR IS RESPONSIBLE FOR VERIFYING IN THE FIELD THE EXISTENCE AND LOCATION OF OVERHEAD, BURIED AND/OR EMBEDDED UTILITIES AFFECTED BY THE WORK OF THIS CONTRACT.

1.18 ALL WORK IS TO CONFORM WITH THE FOLLOWING CODES AND STANDARDS:  
(A) "780 CMR: MASSACHUSETTS AMENDMENTS MASSACHUSETTS STATE BUILDING CODE" - 10TH EDITION (MSBC)  
(B) INTERNATIONAL BUILDING CODE (IBC 2021)  
(C) "BUILDING CODE REQUIREMENTS FOR STRUCTURAL CONCRETE" - AMERICAN CONCRETE INSTITUTE (ACI 318)  
(D) "MANUAL OF STEEL CONSTRUCTION" - AMERICAN INSTITUTE OF STEEL CONSTRUCTION (AISC 360)  
(E) "STRUCTURAL WELDING CODE - STEEL" - AMERICAN WELDING SOCIETY (AWS D1.1)  
(F) "LRFD STRUCTURAL SUPPORTS FOR HIGHWAY SIGNS, LUMINAIRES, AND TRAFFIC SIGNALS" 2015 AASHTO  
(G) FOR ADDITIONAL CODES AND STANDARDS REFER TO SPECIFICATIONS.

1.19 THE CONTRACTOR SHALL NOTIFY THE ENGINEER OF UNFORESEEN CONDITIONS THAT MAY BE UNCOVERED DURING CONSTRUCTION AS A REQUEST FOR INFORMATION (RFI) BEFORE PROCEEDING WITH WORK.

1.20 DETAILS AND NOTES SHOWN ON STRUCTURAL DRAWINGS SHALL BE APPLICABLE TO ALL PARTS OF THE STRUCTURAL WORK EXCEPT WHERE SPECIFICALLY REQUIRED OTHERWISE BY CONTRACT DOCUMENTS. CONDITIONS NOT SPECIFICALLY SHOWN SHALL BE SIMILAR TO THOSE SHOWN FOR LIKE CONDITIONS AS DETERMINED BY THE ENGINEER.

1.21 IN ACCORDANCE WITH SPECIFICATION SECTION 01 45 23. TESTING AND INSPECTION OF STRUCTURAL WORK SHALL BE PERFORMED BY AN INDIVIDUAL TESTING AGENCY HIRED BY THE OWNER (CITY). THE COSTS FOR TESTING AND INSPECTIONS WILL BE PAID BY THE OWNER (CITY). THE CONTRACTOR IS RESPONSIBLE FOR PROVIDING A 48-HOUR NOTICE PRIOR TO ANY 3RD PARTY TESTING AND INSPECTIONS.

1.22 THE CONTRACTOR SHALL DESIGN AND PROVIDE ALL REQUIRED SHORING AND TEMPORARY BRACING TO RESIST FORCES ON THE STRUCTURE THROUGHOUT THE CONSTRUCTION PERIOD.

- 2.01 THE CONTRACTOR SHALL DESIGN AND PROVIDE ALL TEMPORARY EARTH SUPPORT, SHORING AND BRACING REQUIRED TO PERFORM THE WORK IN ACCORDANCE WITH OSHA, STATE AND LOCAL REQUIREMENTS.
- 2.02 THE CONTRACTOR SHALL DESIGN AND PROVIDE SHEETING, SHORING, BRACING, AND/OR UNDERPINNING IN ORDER TO PROTECT EXISTING UTILITIES FROM EXCESSIVE MOVEMENTS DURING THE CONSTRUCTION PERIOD, IN ACCORDANCE WITH OSHA, STATE & LOCAL REQUIREMENTS.
- 2.03 THE CONTRACTOR SHALL CARRY OUT CONTINUOUS CONTROL OF SURFACE AND SUBSURFACE WATER, DEWATER ANY AREAS REQUIRING EXCAVATION IN ADVANCE OF PERFORMING EXCAVATION. MAINTAIN GROUNDWATER LEVELS AT LEAST 2 FEET BELOW PLANNED SUBGRADES.
- 2.04 ALL SUBGRADES TO RECEIVE FILL MATERIALS, FOUNDATIONS, SLABS OR OTHER CONSTRUCTION SHALL BE FREE OF RUNNING OR STANDING WATER PRIOR TO PLACEMENT.
- 2.05 FOUNDATIONS SHALL BE INSTALLED IN THE GEOMETRY SHOWN IN THE PLANS, ANY ROCK ENCOUNTERED DURING EXCAVATION SHALL BE REMOVED TO CLEAR THE REQUIRED FOUNDATION GEOMETRY.

3.01 CONCRETE WORK SHALL CONFORM TO "BUILDING CODE REQUIREMENTS FOR REINFORCED CONCRETE" (ACI 318) AND "SPECIFICATIONS FOR STRUCTURAL CONCRETE FOR BUILDINGS" (ACI 301).

3.02 CONCRETE SHALL BE CONTROLLED CONCRETE, PROPORTIONED, MIXED AND PLACED IN THE PRESENCE OF A REPRESENTATIVE OF AN APPROVED TESTING AGENCY.

3.03 UNLESS NOTED OTHERWISE, CONCRETE SHALL BE NORMAL WEIGHT AND HAVE A MINIMUM 28 DAY COMPRESSIVE STRENGTH AS FOLLOWS:

(A) ALL STRUCTURAL CONCRETE: 4000 PSI

3.04 ALL PERMANENTLY EXPOSED VERTICAL AND HORIZONTAL CONCRETE SURFACES SHALL BE TREATED OR SEALED IN ACCORDANCE WITH PROJECT SPECIFICATIONS.

3.05 CONCRETE EXPOSED TO WEATHER (FREEZE-THAW CONDITIONS) IN THE FINISHED PROJECT SHALL BE AIR ENTRAINED PER SPECIFICATIONS REQUIREMENTS.

3.06 ALL CONCRETE SHALL BE WATER CURED UNLESS OTHERWISE AUTHORIZED BY THE ENGINEER.

3.07 NON-SHRINK, NON-METALLIC, GROUT SHALL HAVE A MINIMUM 28-DAY COMPRESSIVE STRENGTH OF 7,500 PSI (ASTM C942) AND A MINIMUM BOND STRENGTH OF 2,000 PSI AT 28-DAYS (ASTM C882). GROUT MAY BE EXTENDED WITH COARSE AGGREGATE PER THE MANUFACTURER'S RECOMMENDATIONS.

4.01 REINFORCEMENT DETAILING, FABRICATION, AND ERECTION SHALL CONFORM TO "ACI DETAILING MANUAL" - SP-66, "CRSI MANUAL OF STANDARD PRACTICE".

4.02 STEEL REINFORCEMENT, UNLESS NOTED OTHERWISE, SHALL CONFORM TO THE FOLLOWING:  
(A) BARS, TIES, AND STIRRUPS ASTM A615 GRADE 60

4.03 REINFORCING STEEL SHALL BE UNCOATED AND DEFORMED.

4.04 MINIMUM CONCRETE PROTECTIVE COVERING FOR REINFORCEMENT, UNLESS REQUIRED FOR FIRE PROTECTION OR NOTED OTHERWISE, SHALL BE AS FOLLOWS:  
(A) CONCRETE CAST AGAINST AND PERMANENTLY EXPOSED TO EARTH: \_\_\_\_"3"  
(B) CONCRETE EXPOSED TO EARTH OR WEATHER:  
(1) NO. 6 THRU NO. 18 BARS \_\_\_\_2"  
(2) NO. 6 BAR, W31 OR D31 WIRE AND SMALLER \_\_\_\_2"

4.05 REINFORCING STEEL SHALL BE CONTINUOUS THROUGH ALL CONSTRUCTION JOINTS, CORNERS, AND INTERSECTIONS UNLESS OTHERWISE NOTED. REINFORCING SHALL BE LAPPED AT NECESSARY SPLICES OR HOOKED AT DISCONTINUOUS ENDS, UNLESS OTHERWISE NOTED.

4.06 FOR REINFORCING STEEL SPLICE LAP LENGTHS REFER TO THE TABLE PROVIDED UNLESS OTHERWISE INDICATED.

4.07 MECHANICAL SPLICES SHALL BE PERMITTED SUBJECT TO APPROVAL BY THE ENGINEER. MECHANICAL SPLICES SHALL DEVELOP AT LEAST 125 PERCENT OF THE SPECIFIED YIELD STRENGTH OF THE BAR. NO WELDED CONNECTIONS ARE PERMITTED.

4.08 REINFORCEMENT SHALL NOT BE TACK WELDED.

4.09 NOTIFY THE TESTING LAB AND ENGINEER A MINIMUM OF 48 HOURS PRIOR TO SCHEDULED CONCRETE PLACEMENT IN ORDER TO ACCOMMODATE INSPECTION OF REINFORCEMENT AND CONCRETE TESTING. NO CONCRETE SHALL BE PLACED WITHIN 48 HOURS OF SUCH NOTIFICATION.

5.01 STRUCTURAL STEEL DESIGN, FABRICATION AND ERECTION SHALL CONFORM TO THE AISC "MANUAL OF STEEL CONSTRUCTION", "SPECIFICATION FOR STRUCTURAL STEEL BUILDINGS AND BRIDGES" (ANSI/AISC 360-10), AND "CODE OF STANDARD PRACTICE FOR STEEL BUILDINGS AND BRIDGES" (ANSI/AISC 303-10).

5.02 STRUCTURAL STEEL SHALL BE NEW STEEL CONFORMING TO THE FOLLOWING:  
(A) WIDE FLANGE SHAPES: \_\_\_\_\_ ASTM A992  
(B) OTHER STEEL SHAPES, PLATES AND BARS: \_\_\_\_\_ ASTM A572 OR ASTM A36.

5.03 ALL WELDED CONNECTIONS SHALL BE MADE BY APPROVED CERTIFIED WELDERS AND SHALL CONFORM TO A.W.S. SPECIFICATIONS AMENDED TO DATE. ELECTRODES SHALL BE E70XX.

5.04 BOLTS SHALL CONFORM TO ASTM A325 AND BE INSTALLED SNUG-TIGHT UNLESS NOTED OTHERWISE

5.05 STRUCTURAL STEEL FRAMING SHALL BE WITHIN TOLERANCE BEFORE CONNECTIONS ARE FINALLY BOLTED OR WELDED.

5.06 FIELD CUTTING OF STRUCTURAL STEEL OR ANY FIELD MODIFICATIONS OF STRUCTURAL STEEL SHALL NOT BE MADE WITHOUT PRIOR WRITTEN APPROVAL BY THE ENGINEER FOR EACH SPECIFIC USE.

5.07 STRUCTURAL STEEL SHAPES AND PLATES SHALL BE HOT-DIPPED GALVANIZED PER ASTM A123 U.N.O. FASTENERS SHALL BE HOT-DIPPED GALVANIZED PER ASTM A153 U.N.O. HOT-DIPPED GALVANIZING SHALL ALSO CONFORM TO ASTM A385. THE GALVANIZER SHALL SUBMIT A CERTIFICATE OF CONFORMANCE FOR RECORD.

5.08 PROVIDE FIELD TOUCH-UP AND REPAIR OF GALVANIZING AS REQUIRED PER ASTM A780 USING AN INORGANIC ZINC-RICH PRIMER.

5.09 WHEN DISSIMILAR METALS ARE IN CONTACT (E.G. STAINLESS STEEL IN CONTACT WITH GALVANIZED STEEL), COAT SURFACE WITH COAL TAR EPOXY OR PROVIDE OTHER APPROVED MEANS TO PROVIDE A BARRIER.

5.10 WELDS SHALL BE 1/4" FILLET WELDS MINIMUM UNLESS NOTED OTHERWISE ON THE DRAWINGS.

5.11 PROVIDE TEMPORARY ERECTION BRACING AND SUPPORTS TO HOLD STRUCTURAL STEEL FRAMING SECURELY IN POSITION. SUCH TEMPORARY BRACING AND SUPPORTS SHALL NOT BE REMOVED UNTIL PERMANENT BRACING HAS BEEN INSTALLED.

5.12 SUBMIT SHOP DRAWINGS AND PRODUCT DATA FOR APPROVAL PRIOR TO FABRICATION.

LOADS, LOADING CONDITIONS, AND COMBINATIONS SHALL BE IN ACCORDANCE WITH THE MASSACHUSETTS STATE BUILDING CODE 10th EDITION, IBC 2021, AND ASCE 7-16 AS APPLICABLE.



LOADS DESIGNATED BY "PSF" ARE UNIFORM LOADS, THOSE DESIGNATED BY "LB" ARE CONCENTRATED LOADINGS AND SHALL BE APPLIED AS REQUIRED BY THE MA STATE BUILDING CODE.

BUILDING OCCUPANCY CATEGORY \_\_\_\_\_ II \_\_\_\_\_

- D:\ms03\local\NSE Projects\MA\Public Art Structural Services\CAD\Structural\Worcester Kelly Square Sion Structural Sheets.dwg


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INSET  
SCALE: 3/8" = 1'-0"

PLAN  
SCALE: 1" = 10'

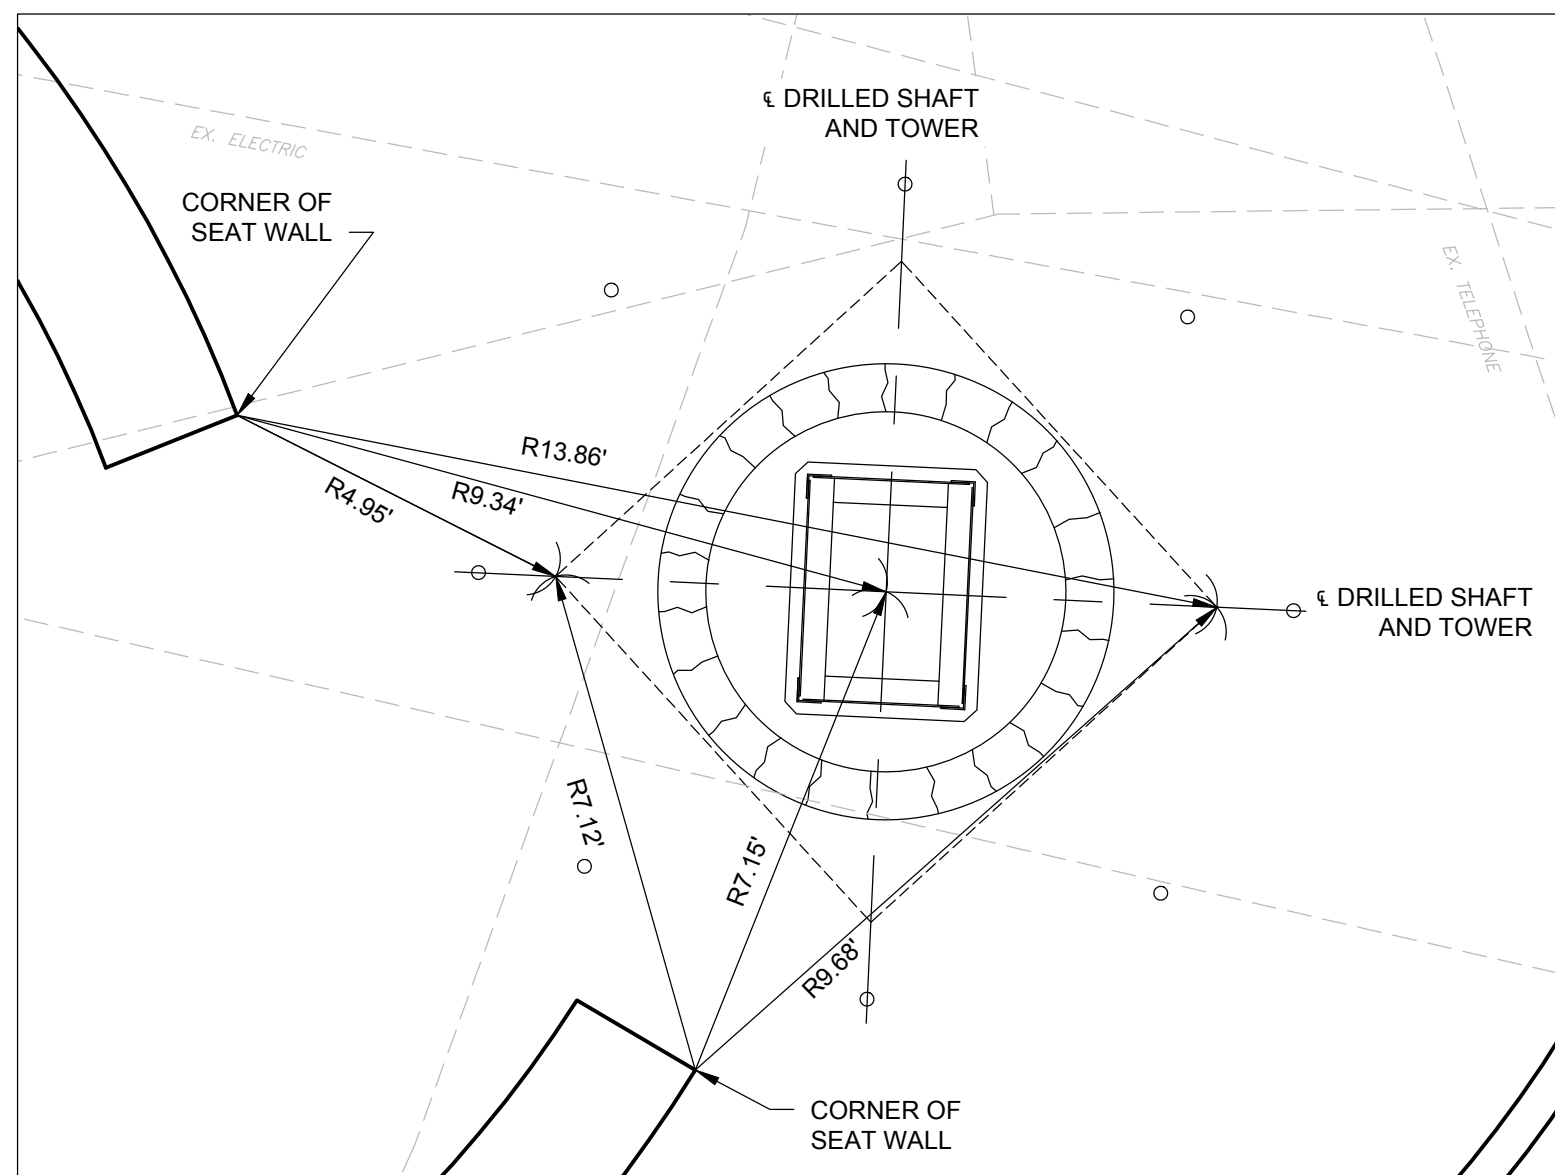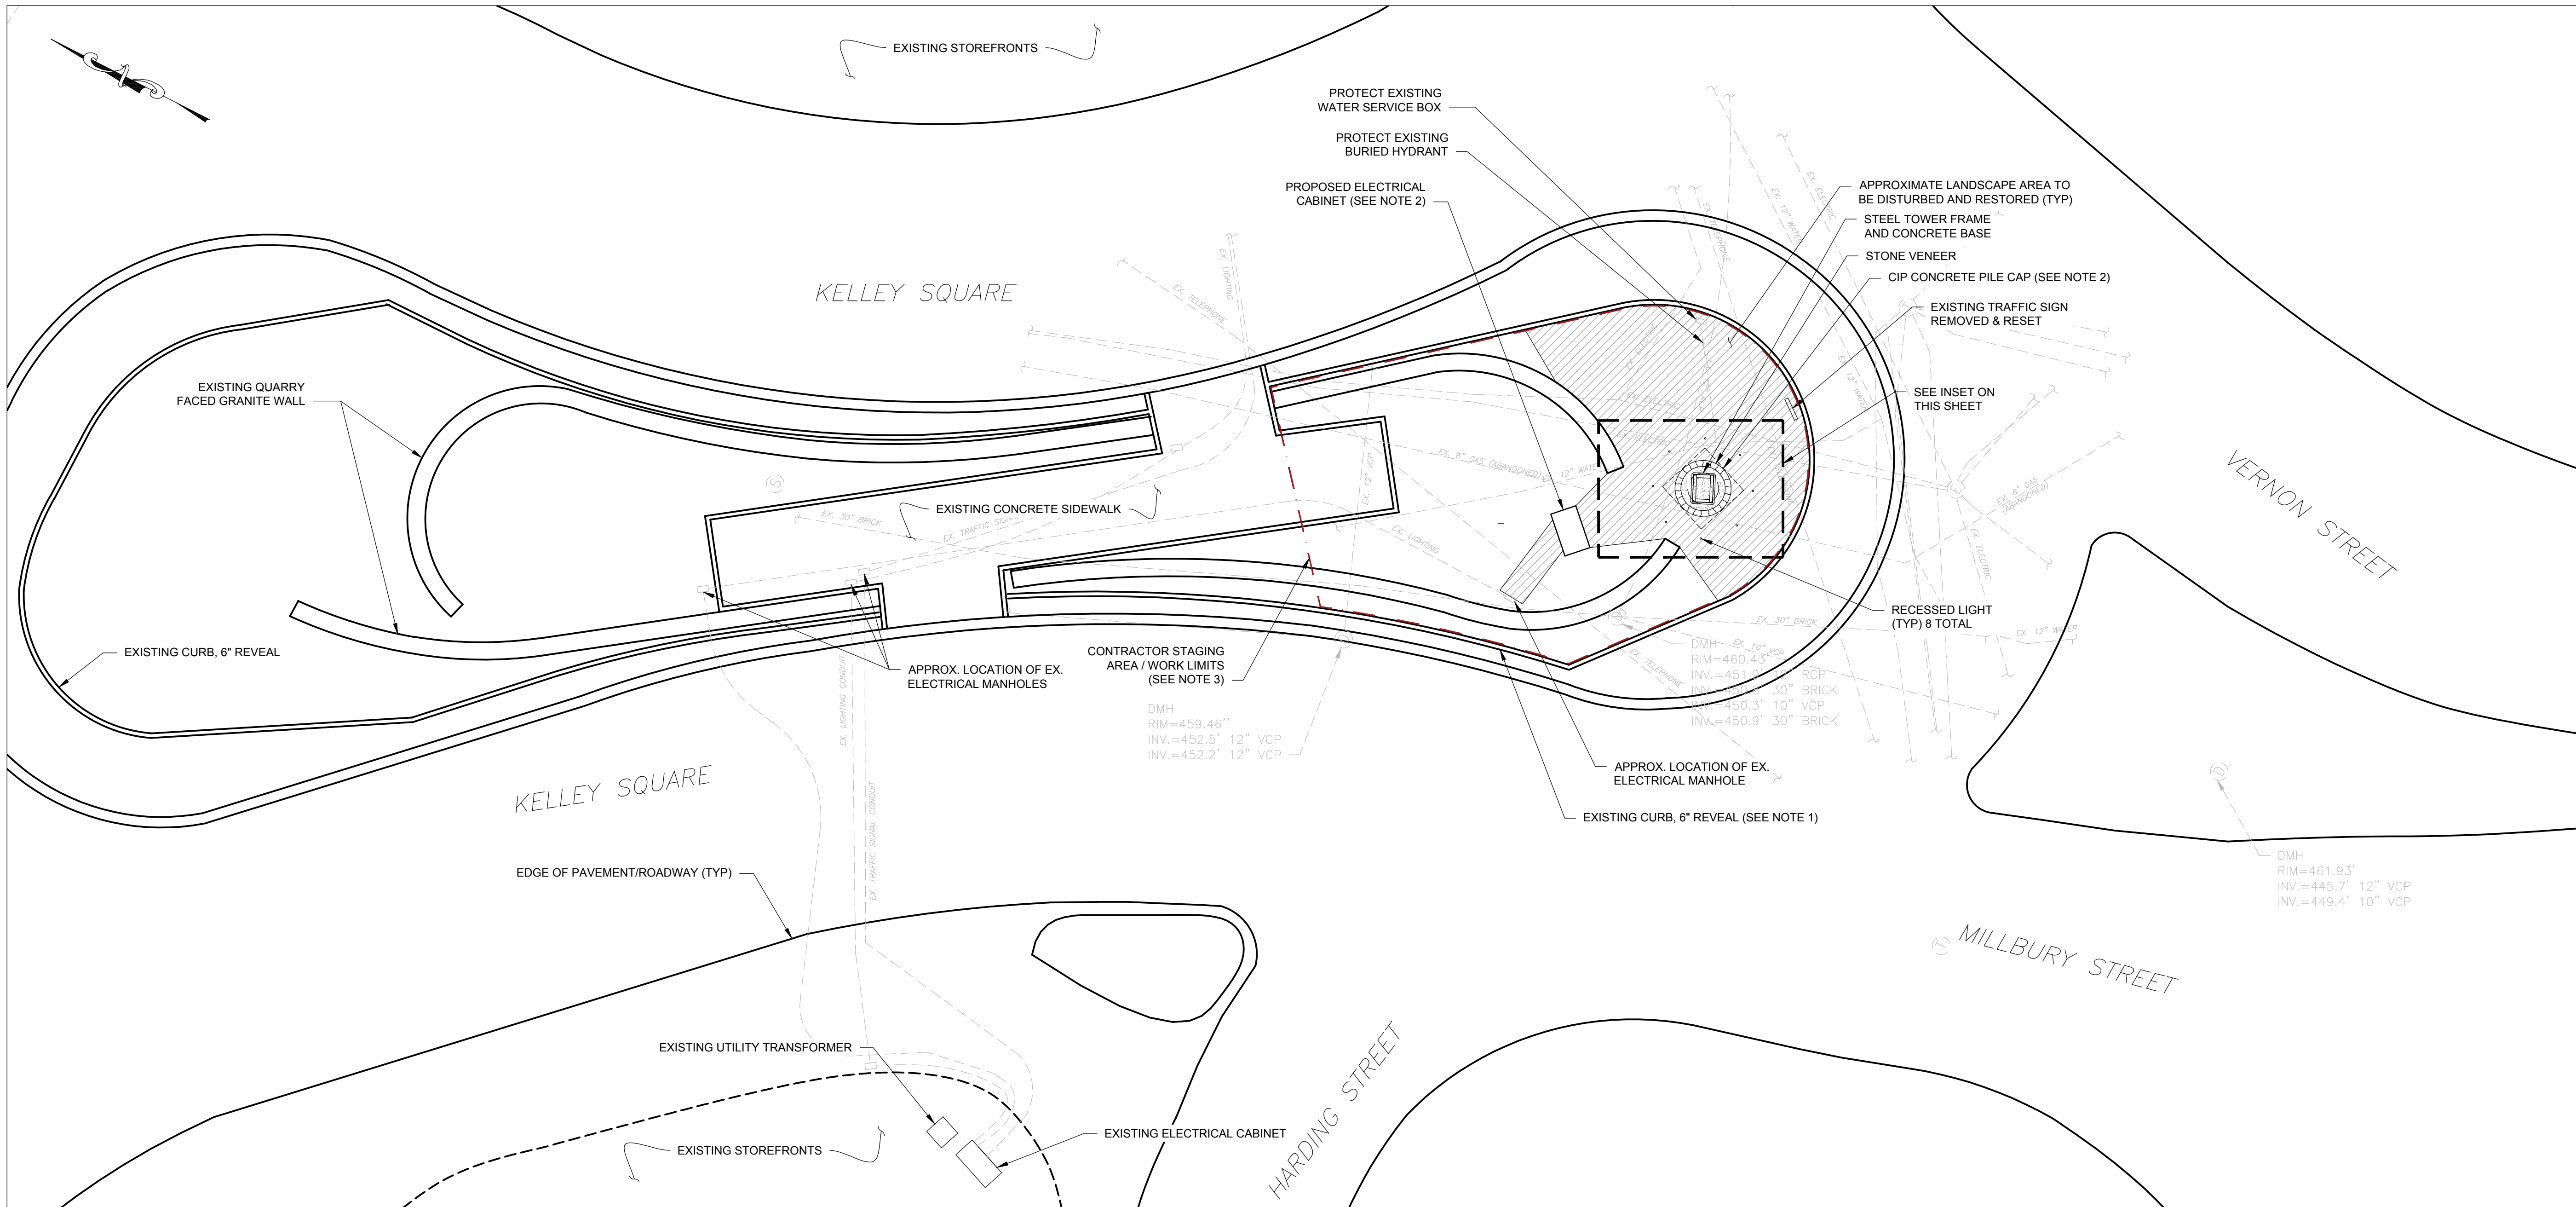

NOTE:

1. EXISTING CURBING IS TO REMAIN. CONTRACTOR IS RESPONSIBLE FOR PROVIDING TEMPORARY RAMPS TO ACCESS THE GRADE AT THE TOP OF THE CURB.
2. CONTRACTOR TO PERFORM EXPLORATORY TEST PITS TO VERIFY UTILITY LOCATIONS PRIOR TO FOUNDATION CONSTRUCTION.
3. SIDEWALK ACCESS MUST BE MAINTAINED DAILY FROM 5 AM TO 8 PM.
4. ANTI-GRAFFITI COATING SHALL BE APPLIED TO ALL STONE SURFACES AND ELECTRICAL CABINET SURFACES.

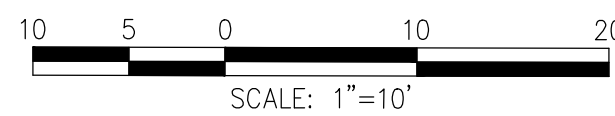Project: CITY OF WORCESTER  
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Revisions:

No.	Date	Description

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Seal:



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Scale: AS NOTED

Date: September 18, 2025  
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Reviewed By: QS  
Approved By: SRB

W&S Project No.: ENG21-1211  
W&S File No.:

Drawing Title:

SITE PLAN AND  
GENERAL NOTES

Sheet Number:

S001





SCALE: 1/2"=1'-0"

1. CONTRACTOR TO PERFORM ONE EXPLORATORY BORING AND PROVIDE RESULTS TO ENGINEER OF RECORD. BORING SHALL BE TO A DEPTH OF 15 FEET OR REFUSAL, WHICHEVER IS LESS. BORINGS SHALL BE BACKFILLED WITH SOIL CUTTINGS. METHOD OF SAMPLING INCLUDES STANDARD PENETRATION TEST (SPT).
2. CONTRACTOR TO SUBMIT STONE VENEER SAMPLE FOR CLIENT APPROVAL.
3. MASONRY VENEER WEEP HOLES TO BE PROVIDED PER MANUFACTURER RECOMMENDATIONS.
4. FULL LETTER MOCKUP TO BE PLACED AT APPROXIMATELY 12 FEET ABOVE GRADE AT THE LOCATION OF THE STRUCTURE TO CONFIRM ORIENTATION WITH CLIENT AND ENGINEER PRIOR TO INSTALLATION. REFER TO SPECIFICATION 10.14.00 EXTERIOR SIGNAGE.



SCALE: 1"=1'-0"



SCALE: 1"=1'-0"

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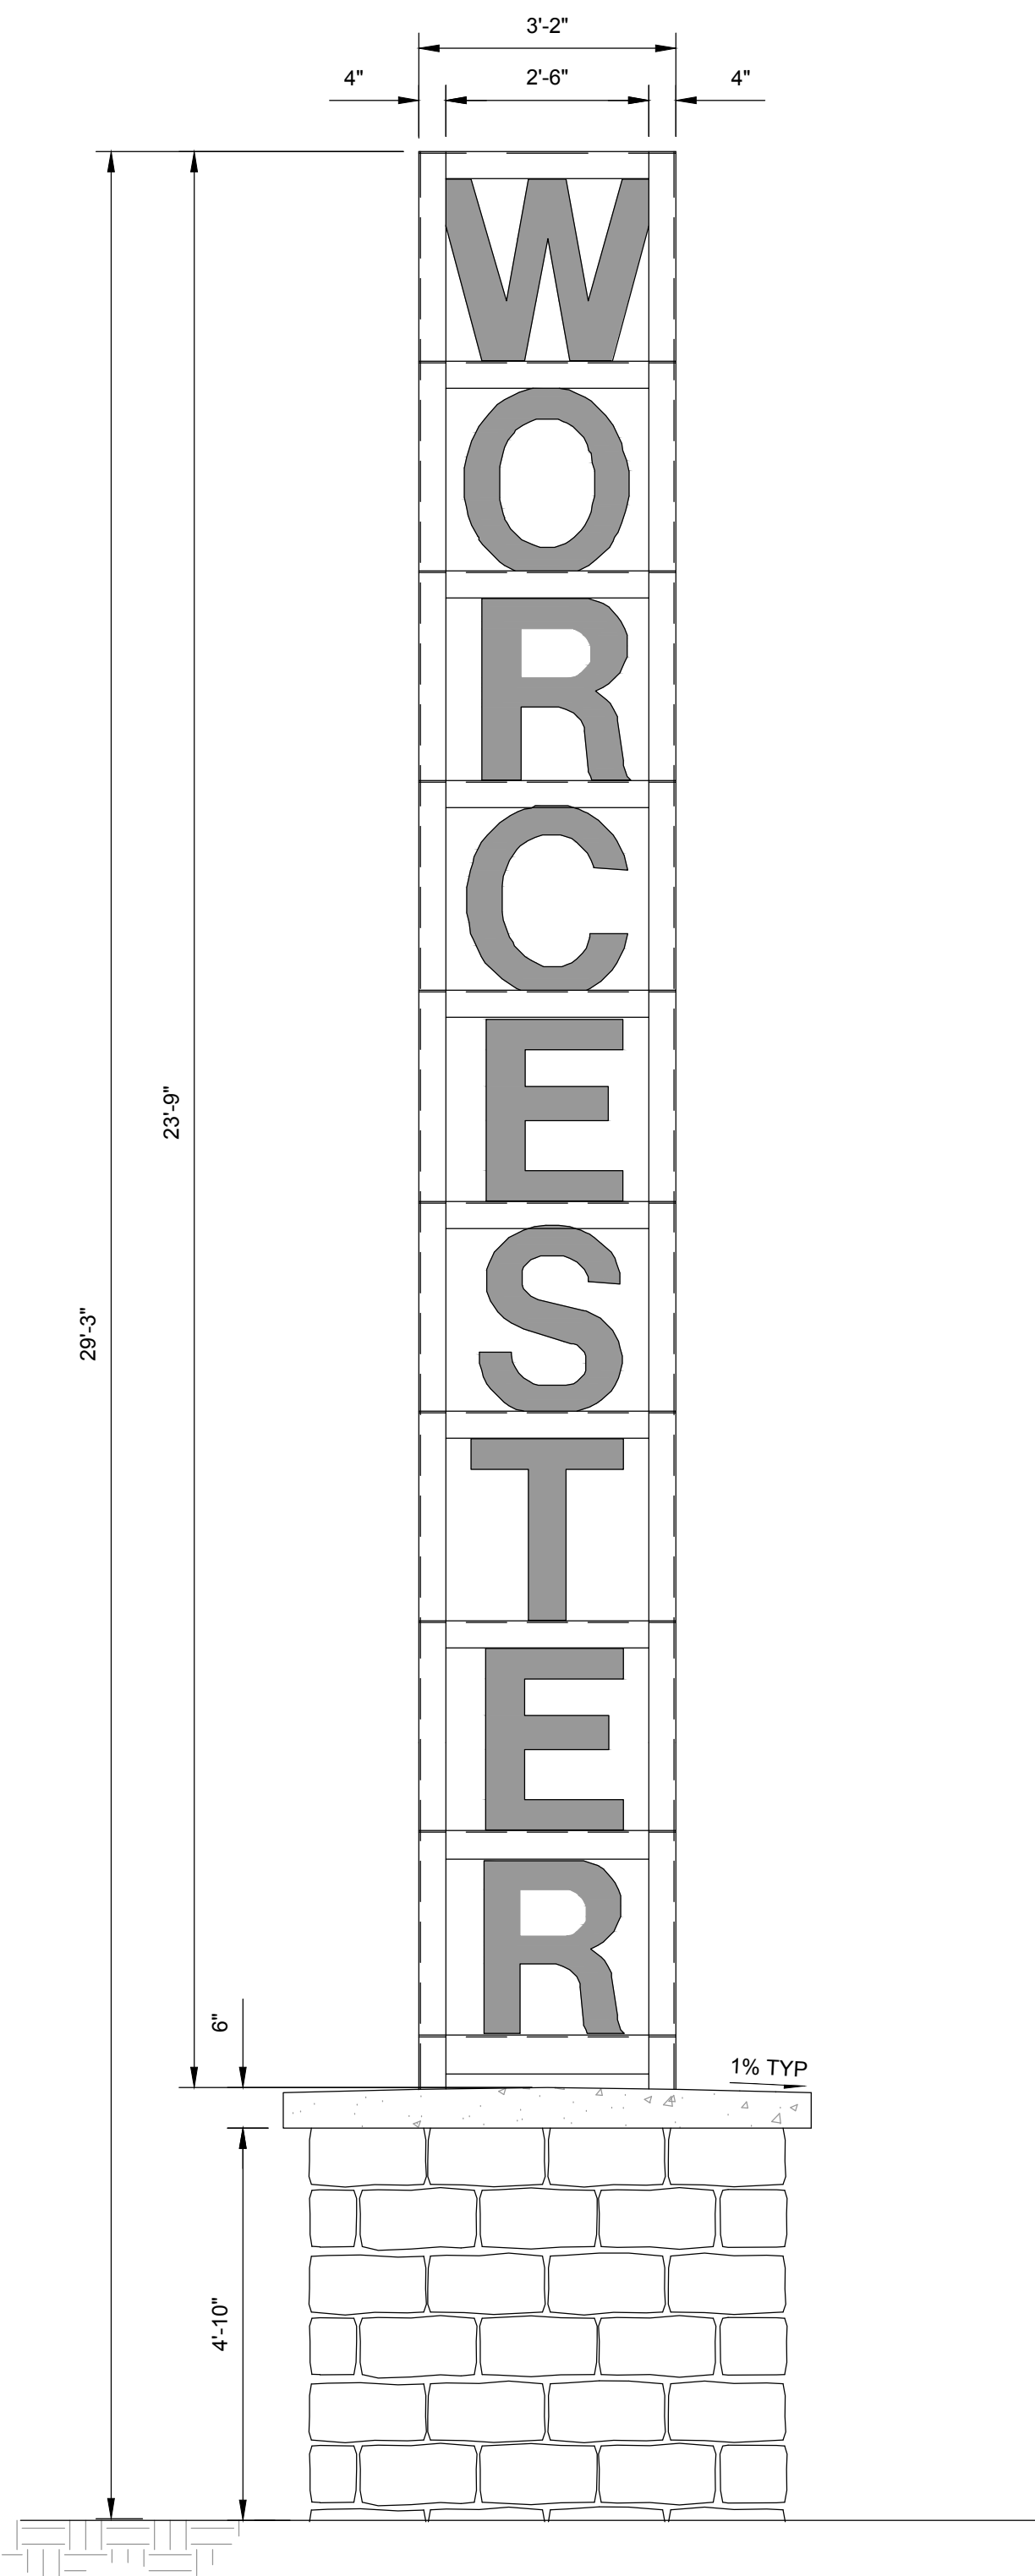
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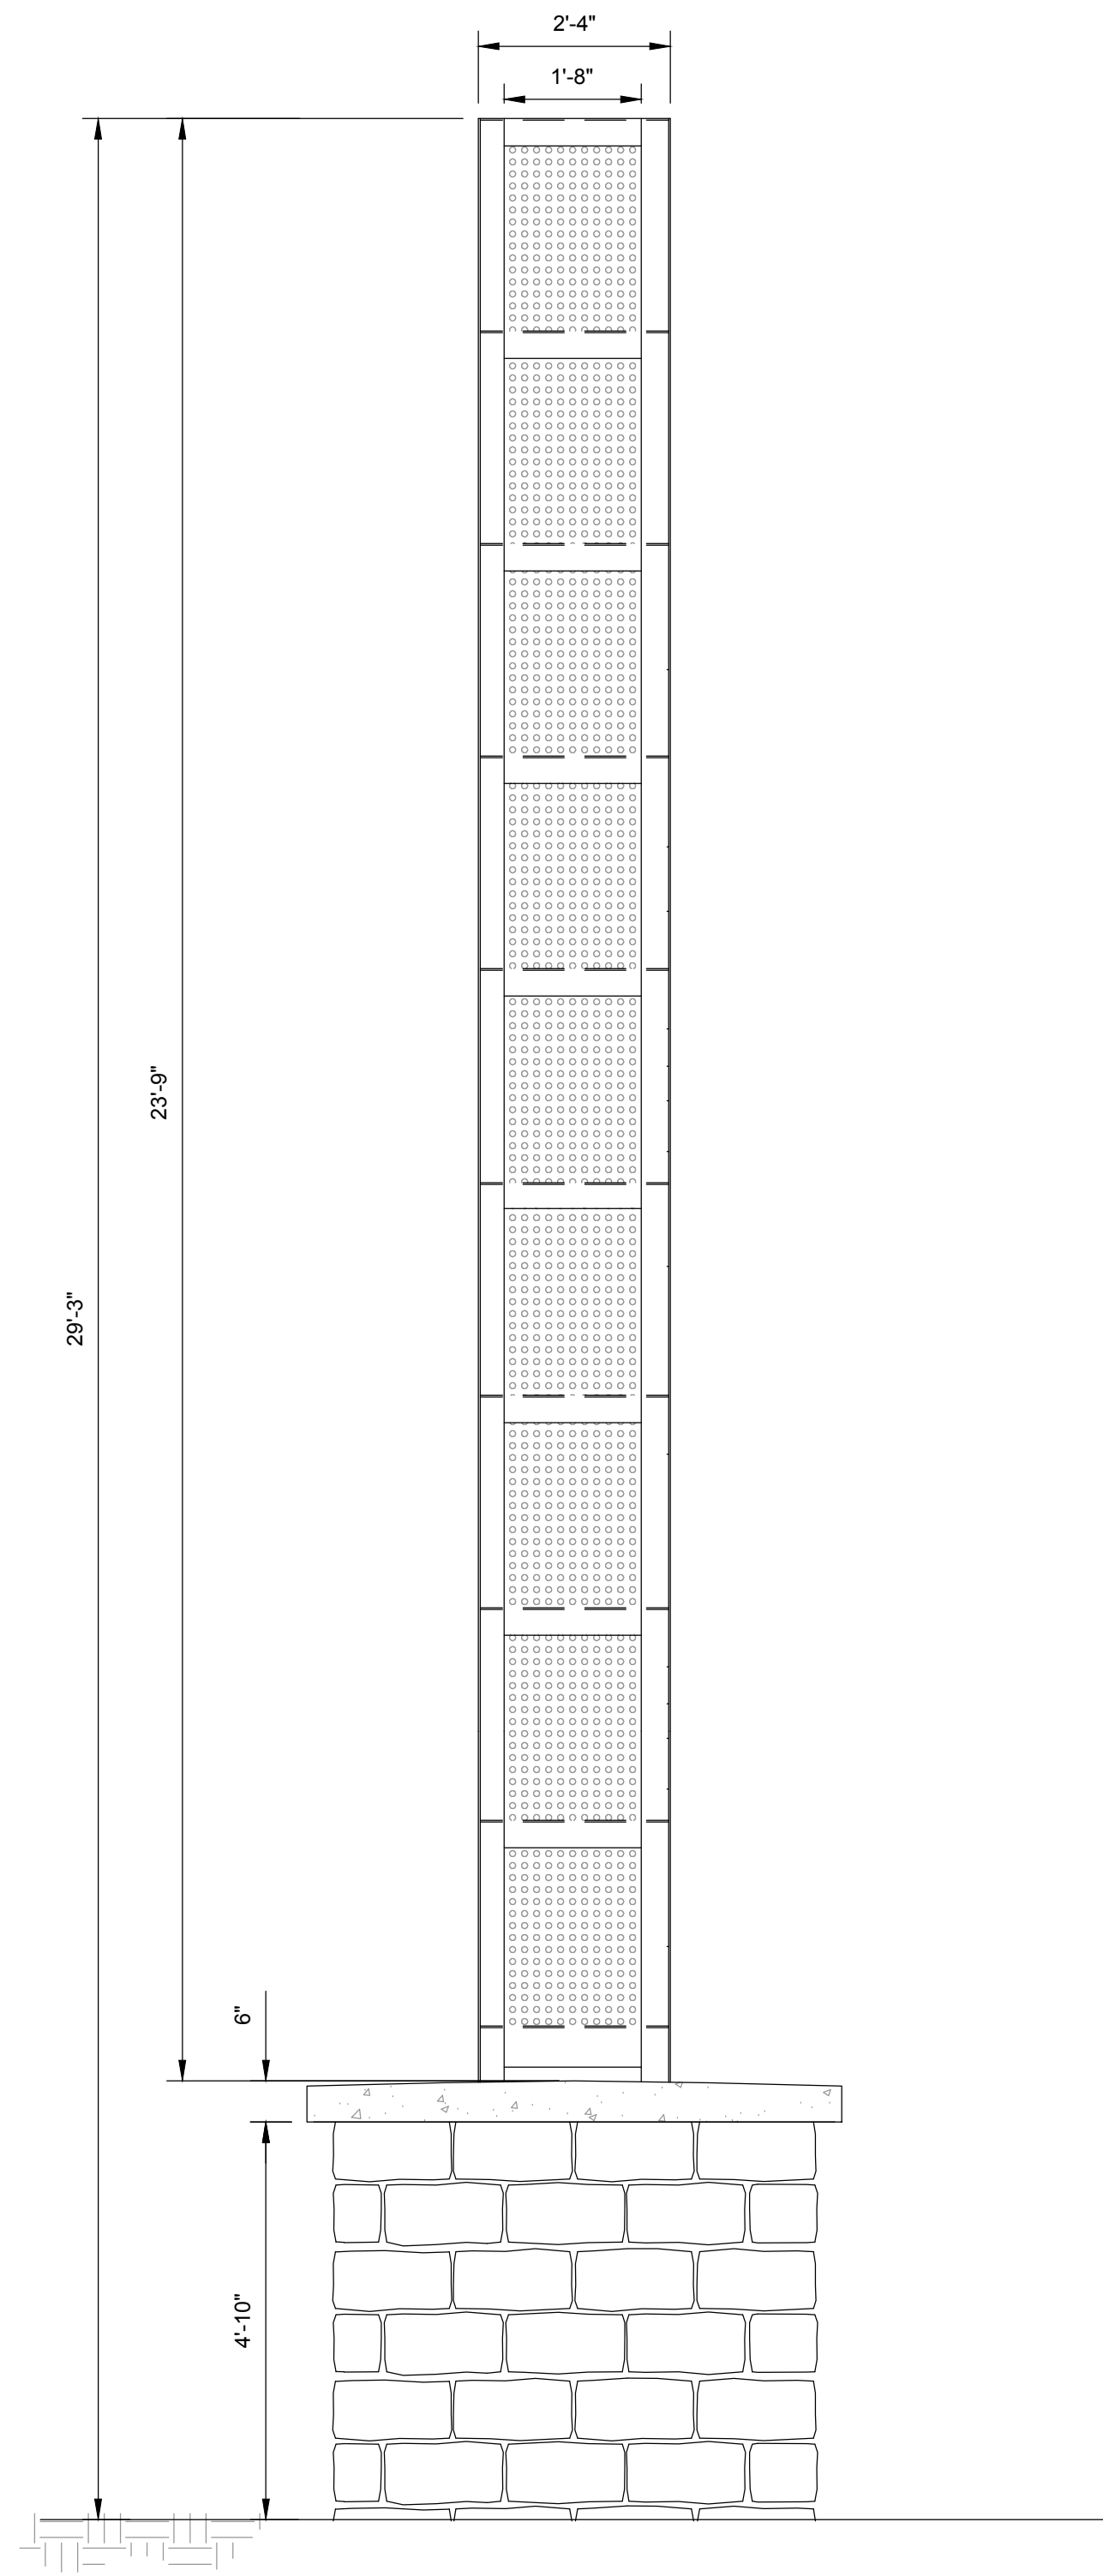
## TOWER AND FOUNDATION DETAILS

Sheet Number:


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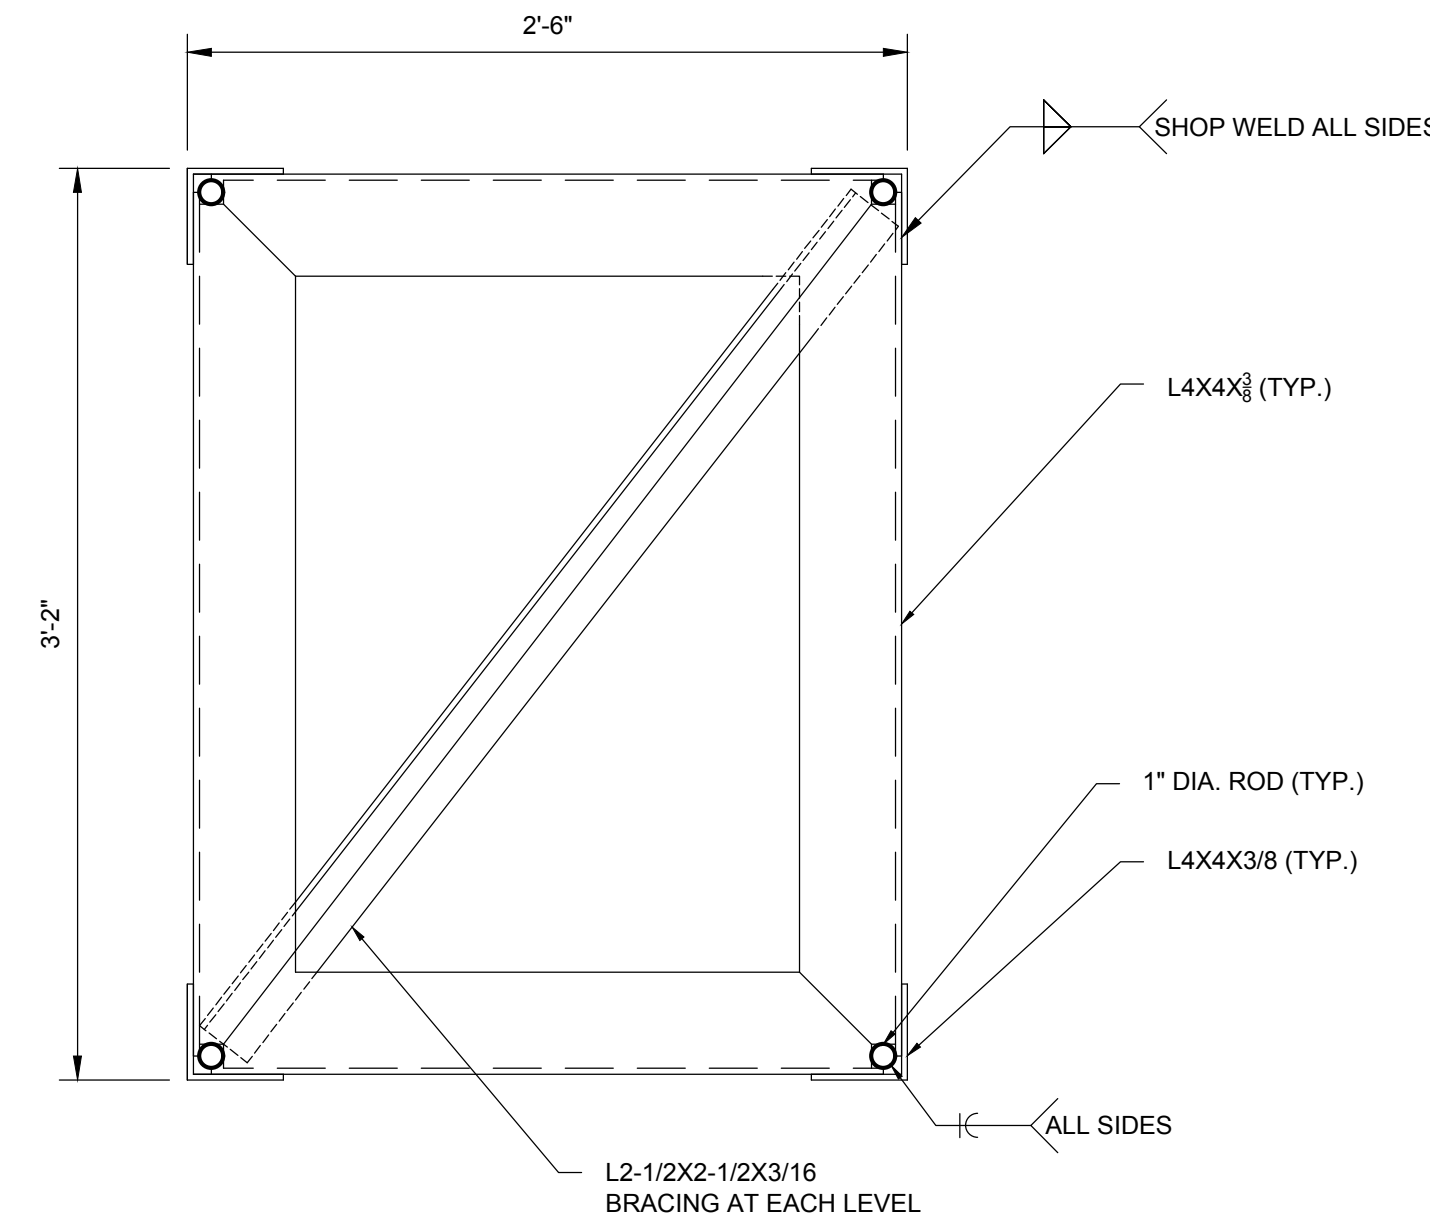
1 TOWER FRONT ELEVATION  
SCALE: 1/2"=1'-0"




2 TOWER SIDE ELEVATION  
SCALE: 1/2"=1'-0"



3 TOWER FRAMING ELEVATION  
SCALE: 1/2"=1'-0"

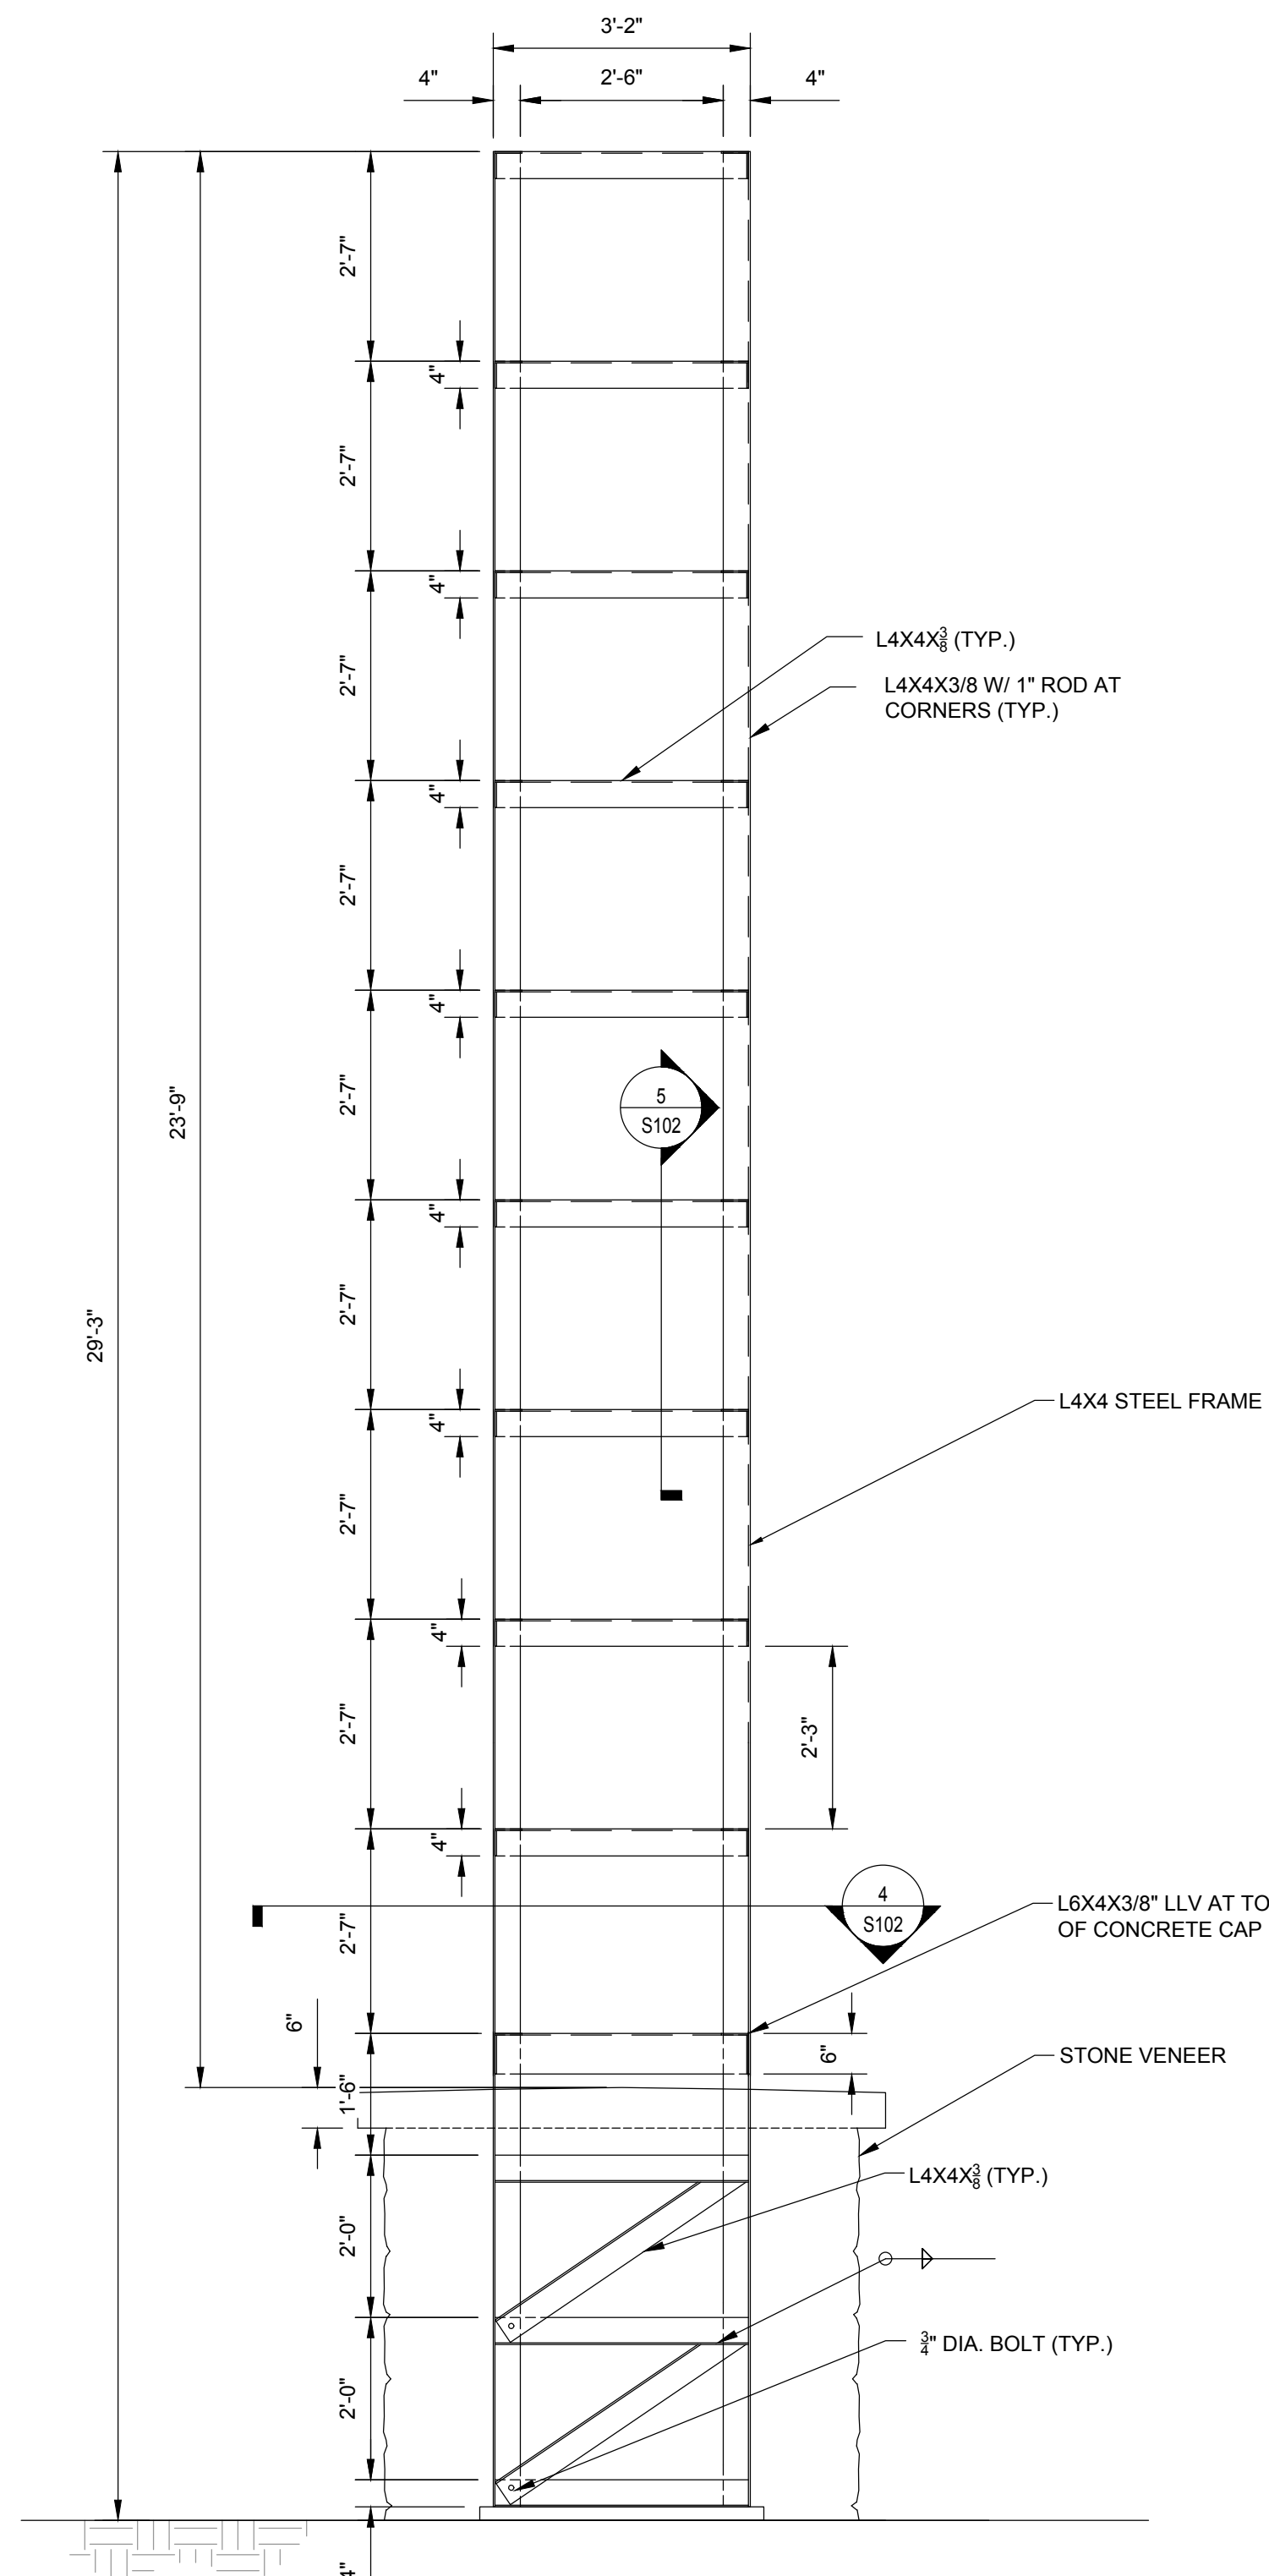

4 TOWER FRAME SECTION (SHOP WELD AND ASSEMBLED)  
SCALE: 1-1/2"=1'-0"

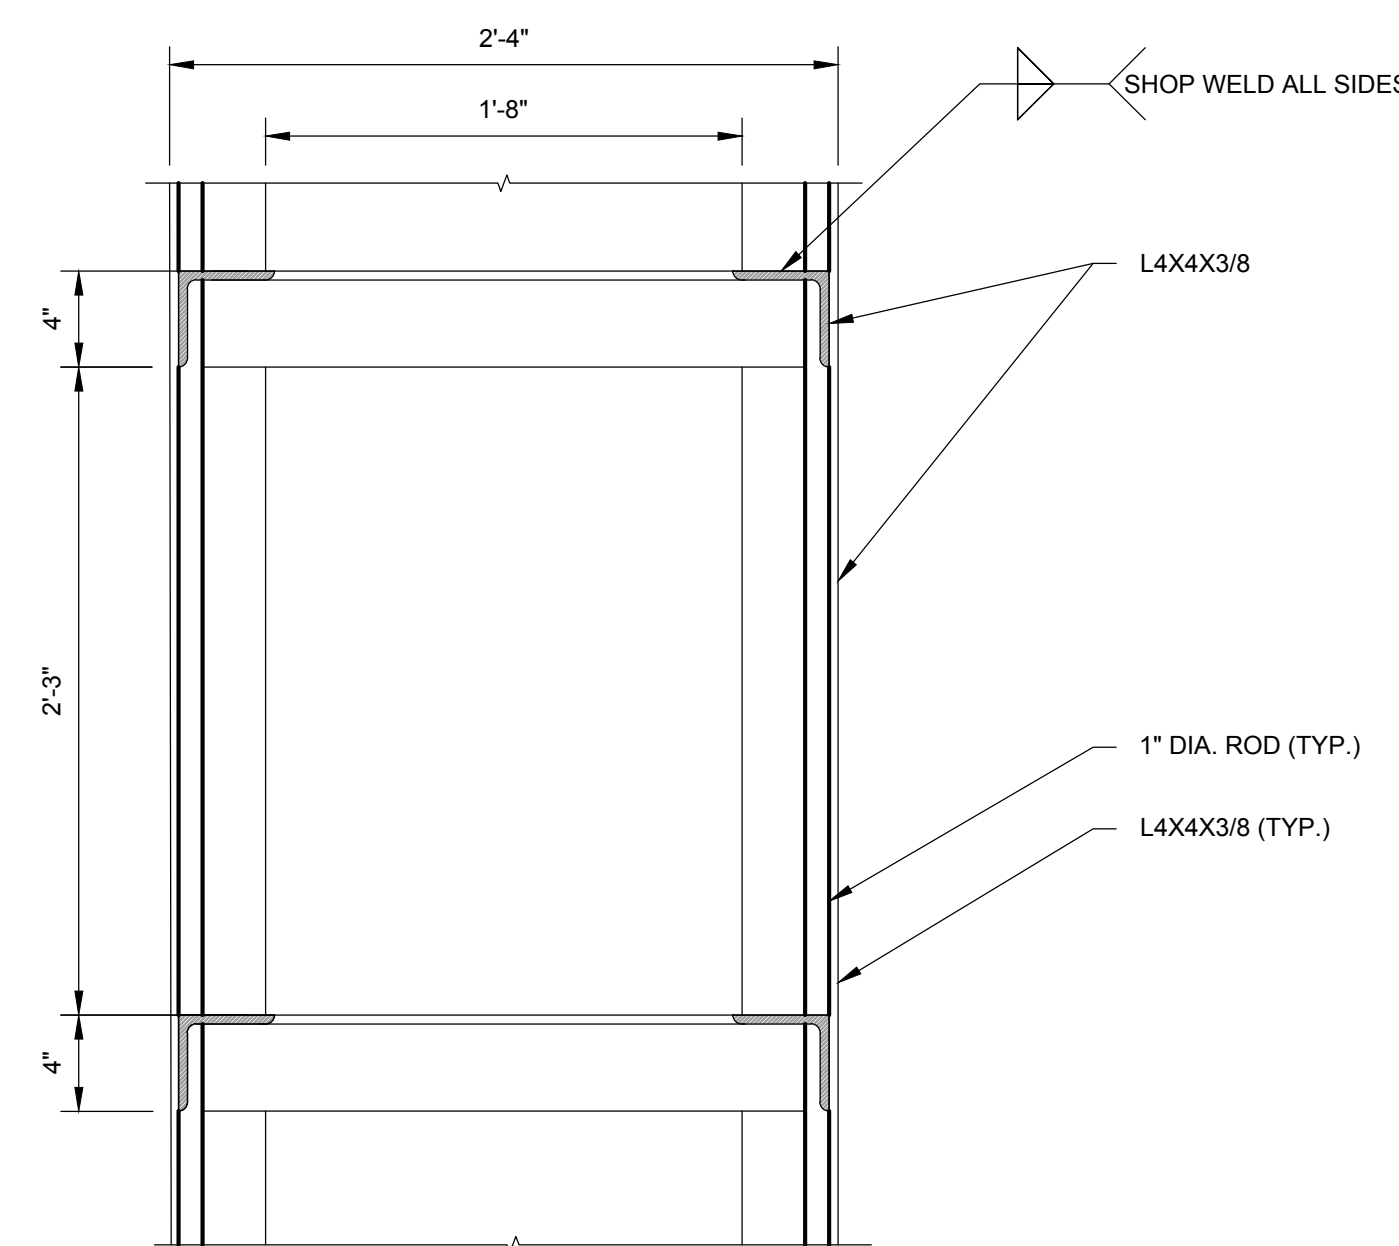

5 TOWER FRAME SECTION (SHOP WELD AND ASSEMBLED)  
SCALE: 1-1/2"=1'-0"

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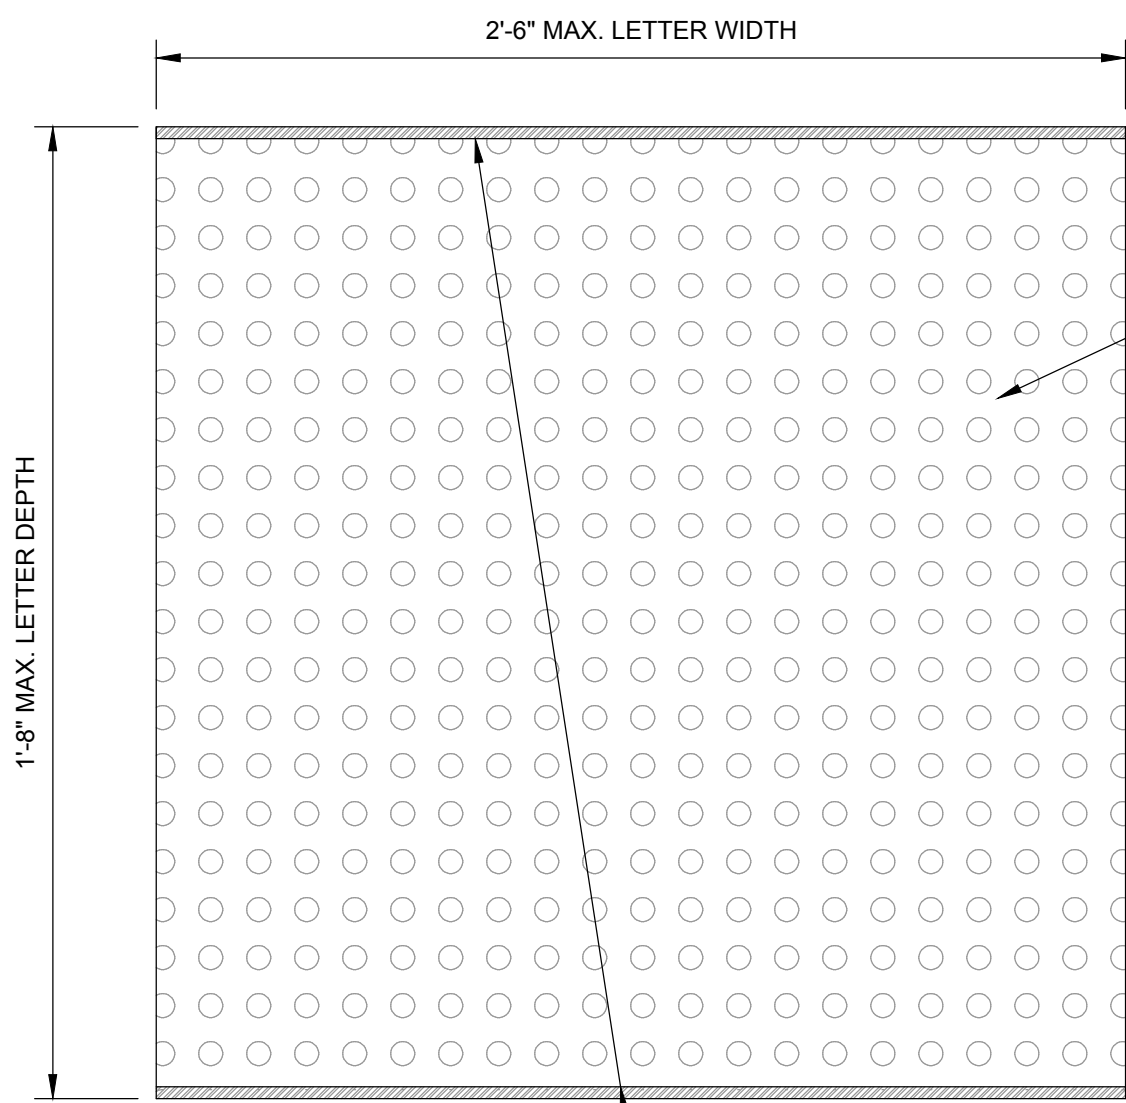
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W&S Project No.:
ENG21-1211
W&S File No.:

Drawing Title:
TOWER FRAME DETAILS I

Sheet Number:
S102






1 TOP VIEW  
SCALE: 3"=1'-0"

NOTES:


- ONE COMPLETE FULL SIZE LETTER WITH ILLUMINATION TO BE PRODUCED FOR APPROVAL BEFORE BEING RELEASED TO PRODUCE REMAINING LETTERS.
- ALL EXPOSED SCREWS SHALL BE STAINLESS STEEL, FLAT, AND MOUNTED FLUSH TO THE LETTERS AND FRAMING.
- BOTTOMS OF LETTER ARE NOT PERFORATED, AND NOT ILLUMINATED.
- FULL COLOR PROGRAMMABLE LED LIGHTS AND SEPARATE WARM WHITE LED LIGHTS, AS WELL AS CONTROL MODULES WITH 36 NON-ANIMATED PRESETS, SHALL BE PROVIDED BY THE SIGN FABRICATOR.
- ADDITIONAL INTERNAL SUPPORTS SHALL BE ADDED INSIDE FRAME AS NECESSARY. SUPPORTS SHALL BE PLACED AWAY FROM EDGE TO AVOID BLOCKING ILLUMINATION. THICKNESS AND MATERIAL DETERMINED BY SIGN FABRICATOR.
- THICKNESS OF INTERNAL SUPPORTS OUTLINING LETTER FACE SHALL BE DETERMINED BY THE SIGN FABRICATOR.
- THE ONLY HORIZONTAL CROSS MEMBERS TO BE AT THE OUTSIDE EDGE OF THE LETTERS SHOULD BE AT THE BOTTOM OF THE LETTER. THICKNESS AND MATERIAL SHALL BE DETERMINED BY SIGN FABRICATOR.




2 TOWER FRAME CONCEPT RENDERING

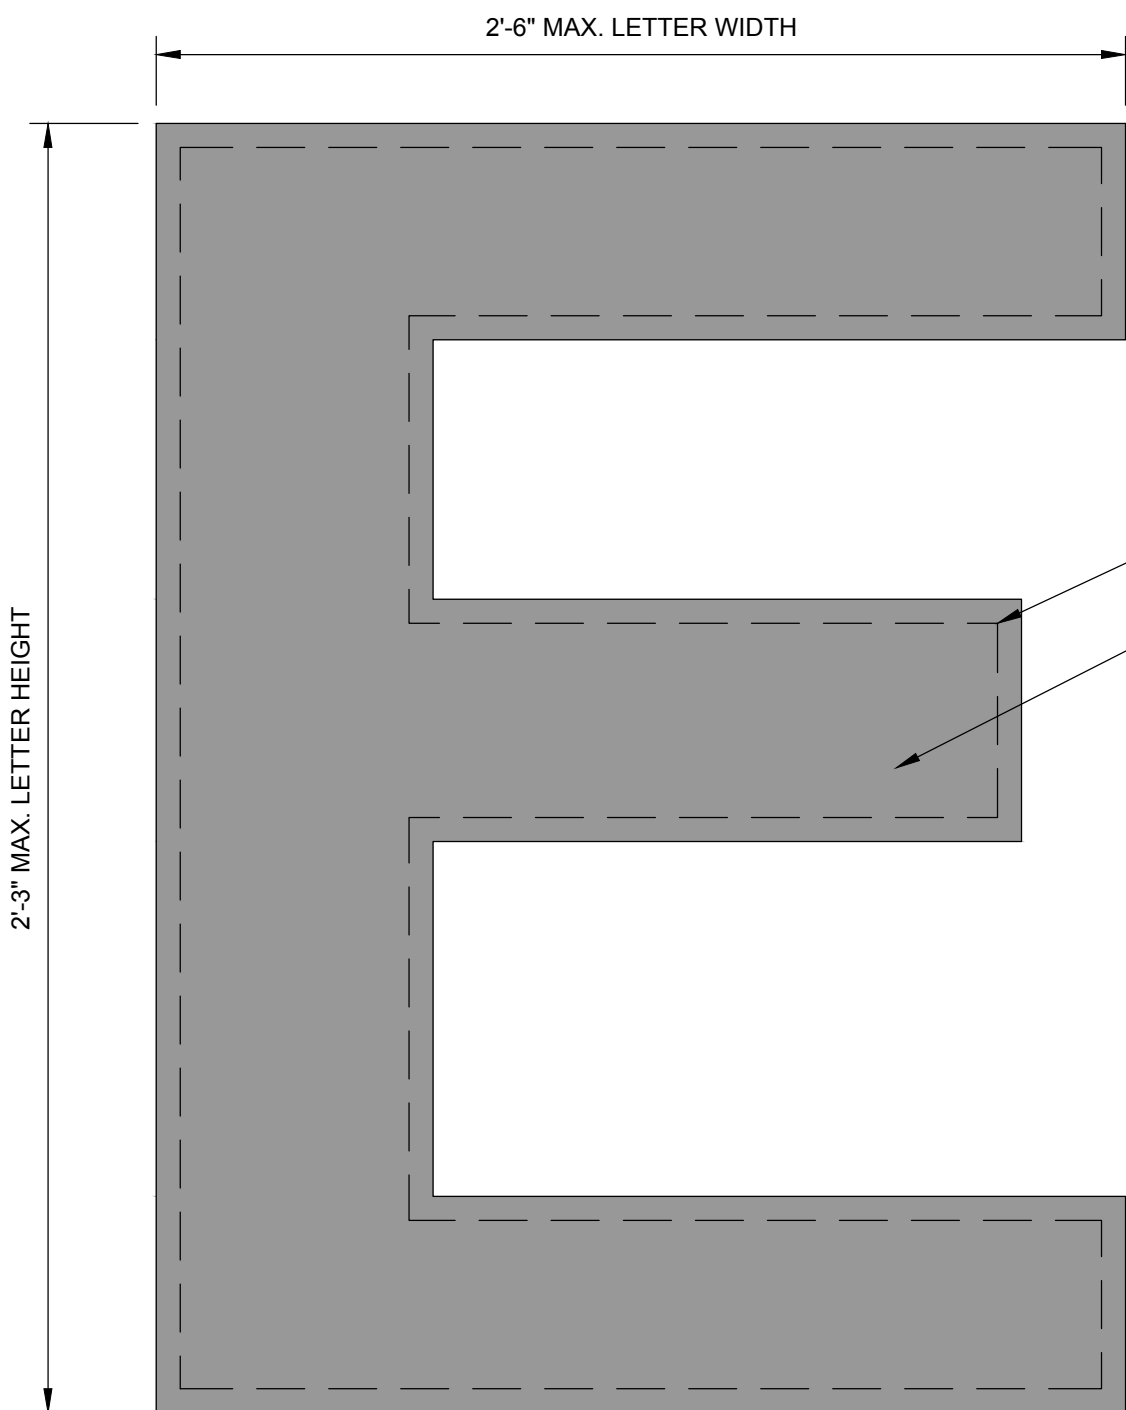

3 FRONT VIEW  
SCALE: 3"=1'-0"

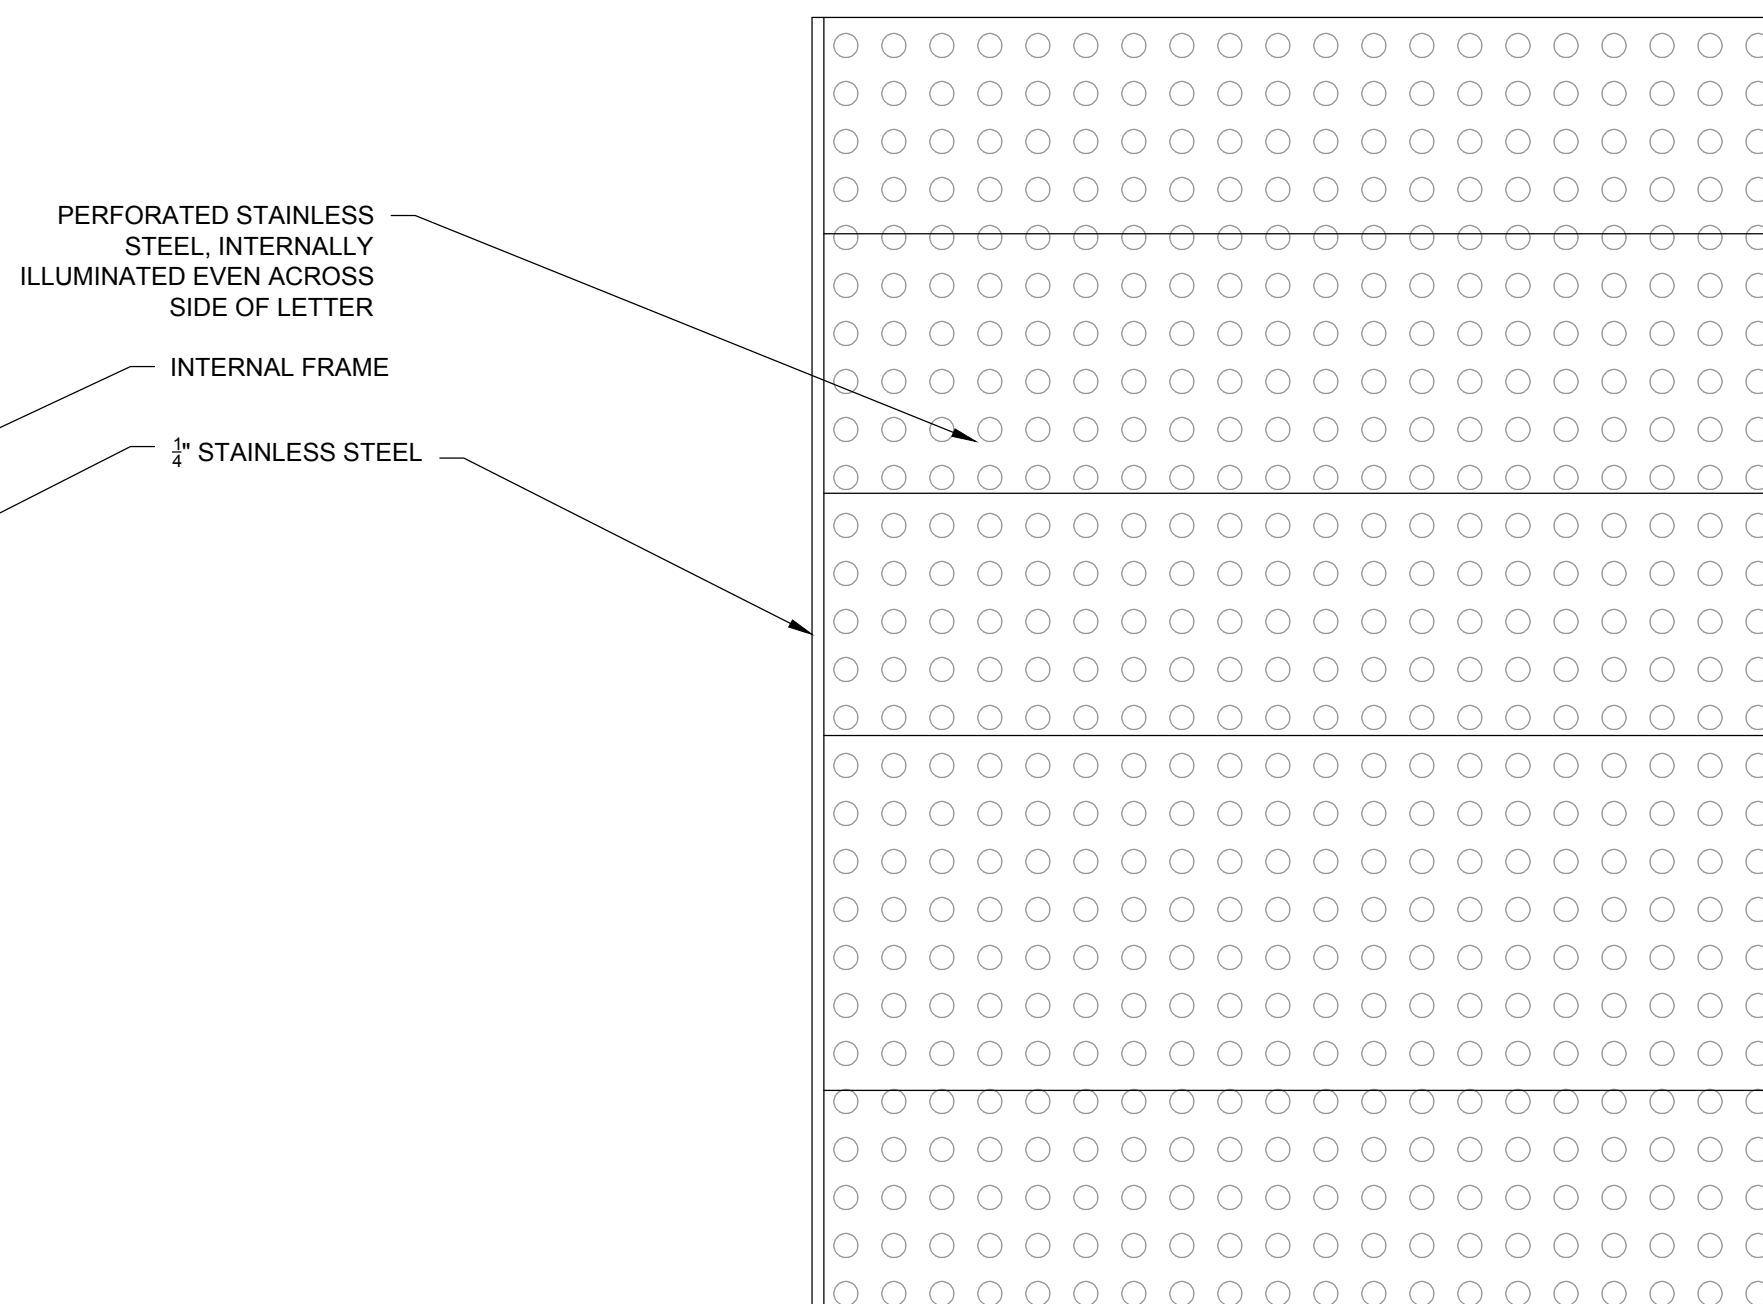

4 SIDE VIEW  
SCALE: 3"=1'-0"

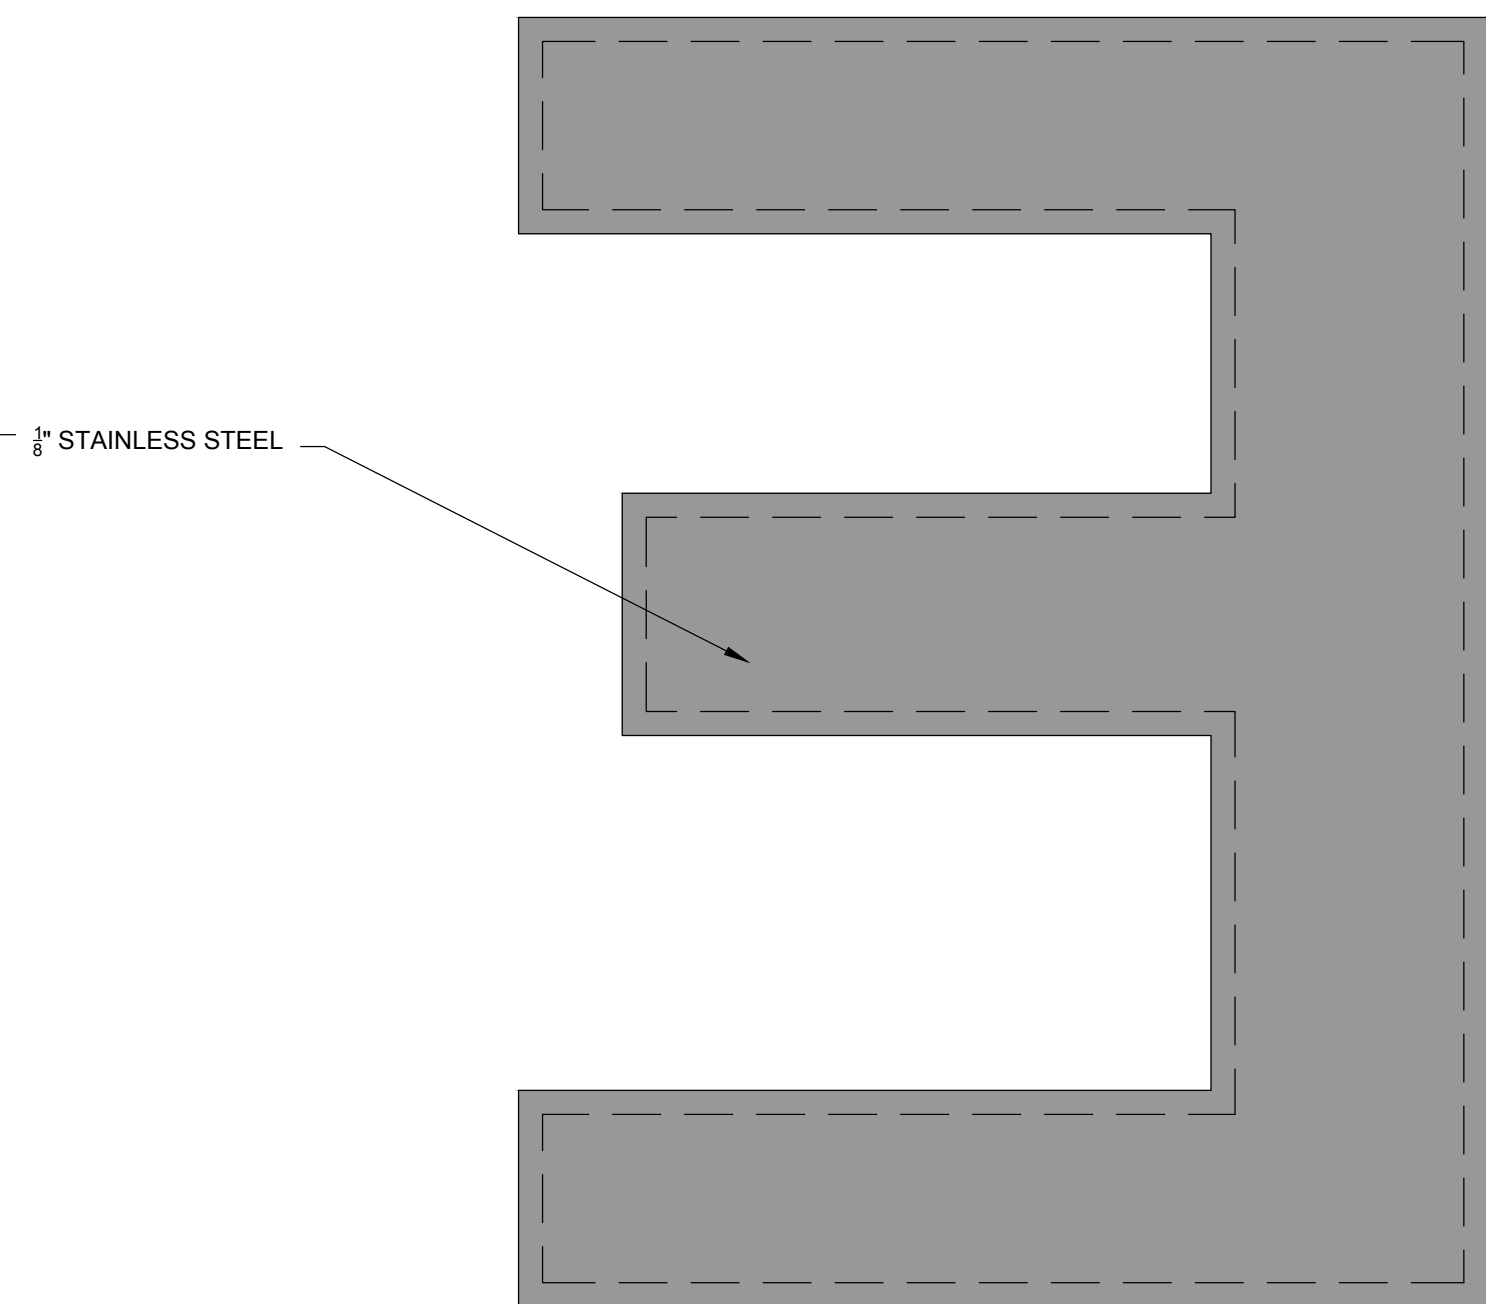

5 REAR VIEW  
SCALE: 3"=1'-0"

Project:  
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TOWER FRAME  
DETAILS II

Sheet Number:

S103




ELECTRICAL ABBREVIATIONS LIST

1P	1 POLE (2P, 3P, 4P, ETC.)	AS	AMP SWITCH	CMPR	COMPRESSOR	DS	SAFETY DISCONNECT SWITCH	FIXT	FIXTURE	HTG	HEATING	LTG	LIGHTING	MSP	MOTOR STARTER PANELBOARD	PA	PUBLIC ADDRESS	RM	ROOM	SYM	SYMMETRICAL	UV	UNIT VENTILATOR	<	ANGLE
A	AMPERE	AT	AMP TRIP	CONN	CONNECTION	DT	DOUBLE THROW	FLR	FLOOR	HTR	HEATER	LTNG	LIGHTNING	MSBD	MAIN SWITCHBOARD	PB	PULL BOX OR PUSHBUTTON	RSC	RIGID STEEL CONDUIT	SYS	SYSTEM	V	VOLT	@	AT
AC	ABOVE COUNTER OR AIR CONDITIONER	ATS	AUTOMATIC TRANSFER SWITCH	CONST	CONSTRUCTION	DWG	DRAWING	FLUOR	FLUORESCENT	HV	HIGH VOLTAGE	LV	LOW VOLTAGE	MT	MOUNT	PE	PNEUMATIC ELECTRIC	RTU	ROOF TOP UNIT	TEL	TELEPHONE	V	VOLT	Δ	DELTA
ACLG	ABOVE CEILING	AUX	AUXILIARY	CONTR	CONTRINUTION OR CONTINUOUS	EC	ELECTRIC, ELECTRICAL	FU	FUSE	HVAC	HEATING, VENTILATING AND AIR CONDITIONING	MAX	MAXIMUM	MT.C	EMPTY CONDUIT	PED	PEDESTAL	SC	SURFACE CONDUIT	TEL/DATA	TELEPHONE/DATA	VA	VOLT-AMPERES	'	FEET
ADD	AUTOMATIC DOOR OPENER	AV	AUDIO VISUAL	CONV	CONTRACTOR	ELEC	ELECTRIC, ELECTRICAL	FUDS	FUSED SAFETY DISCONNECT SWITCH	IC	INTERLOCKING	MAG.S	MAGNETIC STARTER	MTS	MANUAL TRANSFER SWITCH	PH	PHASE	SEC	SECONDARY	TERM	TERMINAL	VD	VIDEO DISPLAY TERMINAL	*	INCHES
AF	AMP FRAME	AWG	AMERICAN WIRE GAUGE	CP	CIRCULATING PUMP	EM	EMERGENCY	GAL	GALLON	HWP	HYDRONIC WATER PUMP	MC	MOMENTARY CONTACT	MTR	MOTOR	N.C.	NORMALLY CLOSED	SHT	SHEET	TL	TWIST LOCK	VERT	VERTICAL	#	NUMBER
AFB	ABOVE FINISHED FLOOR	BATT	BATTERY	CRT	CATHODE-RAY TUBE	EMS	ENERGY MANAGEMENT SYSTEM	GALV	GALVANIZED	IC	ISOLATED GROUND	MCB	MAIN CIRCUIT BREAKER	NEC	NATIONAL ELECTRICAL CODE	PNL	PANEL	SIM	SIMILAR	TR	TAMPER RESISTANT	VFD	VARIABLE FREQUENCY DRIVE	Ø	PHASE
AFG	ABOVE FINISHED GRADE	BD	BOARD	CT	CURRENT TRANSFORMER	EMT	ELECTRIC METALLIC TUBING	GC	GENERAL CONTRACTOR	IMC	INTERMEDIATE METAL CONDUIT	MCC	MOTOR CONTROL CENTER	NEMA	NATIONAL ELECTRICAL CODE	PP	POWER POLE	SIN	SOLID NEUTRAL	TSP	TWISTED SHIELDED PAIR	VOL	VOLUME	C	CENTER LINE
AFI	ARC FAULT CIRCUIT INTERRUPTER	BLDG	BUILDING	CTR	CENTER	EP	ELECTRIC PNEUMATIC	GEN	GENERATOR	INCAND	INCANDESCENT	MDC	MAIN DISTRIBUTION CENTER	NFDS	NON-FUSED SAFETY DISCONNECT SWITCH	PR	PAIR	SPK	SPEAKER	T-STAT	THERMOSTAT	W	WATT	P	PLATE
AHU	AIR HANDLING UNIT	BMS	BUILDING MANAGEMENT SYSTEM	CU	COPPER	EQUIP	EQUIPMENT	GFI	GROUND FAULT CIRCUIT INTERRUPTER	IR	INFRARED	MDP	MAIN DISTRIBUTION PANEL	PRJ	PROJECT	PRV	POWER ROOF VENTILATOR	SP	SPARE	TV	TELEVISION	WG	WIRE GUARD		
AL	ALUMINUM	C	CONDUIT	DCP	DOMESTIC WATER CIRCULATING PUMP	EWC	ELECTRIC WATER COOLER	GFP	GROUND FAULT PROTECTOR	IW	INTERLOCK WITH	MFR	MANUFACTURER	NOT IN CONTRACT	NIGHT LIGHT	N.O.	NORMALLY OPEN	NPF	NORMAL POWER FACTOR	QUAN	QUANTITY	STD	STANDARD	UH	UNIT HEATER
ALT	ALTERNATE	CAB	CABINET	DEPT	DEPARTMENT	EXH	EXHAUST	GRS	GALVANIZED RIGID STEEL (CONDUIT)	KV	KILOVOLT	MH	MANHOLE	NL	NORMALLY OPEN	PVC	POLYVINYL CHLORIDE (CONDUIT)	PWR	POWER	RPT	RECEPTACLE	SW	SWITCH		
AMP	AMPERE	CATV	CABLE TELEVISION	DET	DETAIL	EXP	EXPLOSION PROOF	GYP BD	GYPSONUM BOARD	KVA	KILOVOLT-AMPERE	MIC	MICROPHONE	N.O.	NORMALLY OPEN	NTS	NOT TO SCALE	OH	OVERHEAD	REOD	REQUIRED	RM	ROOM		
AMPL	AMPLIFIER	CB	CIRCUIT BREAKER	DIA	DIAMETER	FA	FIRE ALARM	HOA	HANDS-OFF-AUTOMATIC SWITCH	KVAR	KILOVOLT-AMPERE REACTIVE	MIN	MINIMUM	NPF	NORMAL POWER FACTOR	QUAN	QUANTITY	STD	STANDARD	SWD	SWITCHBOARD				
ANNUN	ANNUNCIATOR	CCTV	CLOSED CIRCUIT TELEVISION	DISC	DISCONNECT	FABP	FIRE ALARM BOOSTER POWER SUPPLY PANEL	HP	HORSEPOWER	KW	KILOWATT	MISC	MISCELLANEOUS	NTS	NOT TO SCALE	OH	OVERHEAD	RPT	RECEPTACLE	SW	SWITCH				
APPROX	APPROXIMATELY	CKT	CIRCUIT	DIST	DISTRIBUTION	FA	FIRE ALARM	HOA	HANDS-OFF-AUTOMATIC SWITCH	KVAR	KILOVOLT-AMPERE REACTIVE	MIN	MINIMUM	NPF	NORMAL POWER FACTOR	QUAN	QUANTITY	STD	STANDARD	SWD	SWITCHBOARD				
AQ-STAT	AQUASTAT	CLG	CEILING	DN	DOWN	FACP	FIRE ALARM CONTROL PANEL	HPF	HIGH POWER FACTOR	LOC	LOCATE OR LOCATION	MMS	MANUAL MOTOR STARTER	OHD	OVERHEAD DOOR	REOD	REQUIRED	RM	ROOM	SWD	SWITCHBOARD				
ARCH	ARCHITECT, ARCHITECTURAL	COMB	COMBINATION	DPR	DAMPER	FCU	FAN COIL UNIT	HT	HEIGHT	LT	LIGHT	MOA	MULTIOUTLET ASSEMBLY	OL	OVERLOADS										



RACEWAY LEGEND


----- RACEWAY RUN UNDERGROUND OR CONCEALED IN SLAB

LIGHTING LEGEND

YG1  IN-GROUND LIGHTING FIXTURE TYPE "YG1." REFER TO LIGHTING FIXTURE SCHEDULE ON DRAWING E601


ONE LINE DIAGRAM LEGEND

-  CABINET LIGHTING FIXTURE
-  GFI RECEPTACLE, MOUNTED 18" AFF, UNLESS OTHERWISE NOTED ADJACENT TO SYMBOL
- "WP" - WEATHERPROOF
- S TOGGLE TYPE LIGHT SWITCH

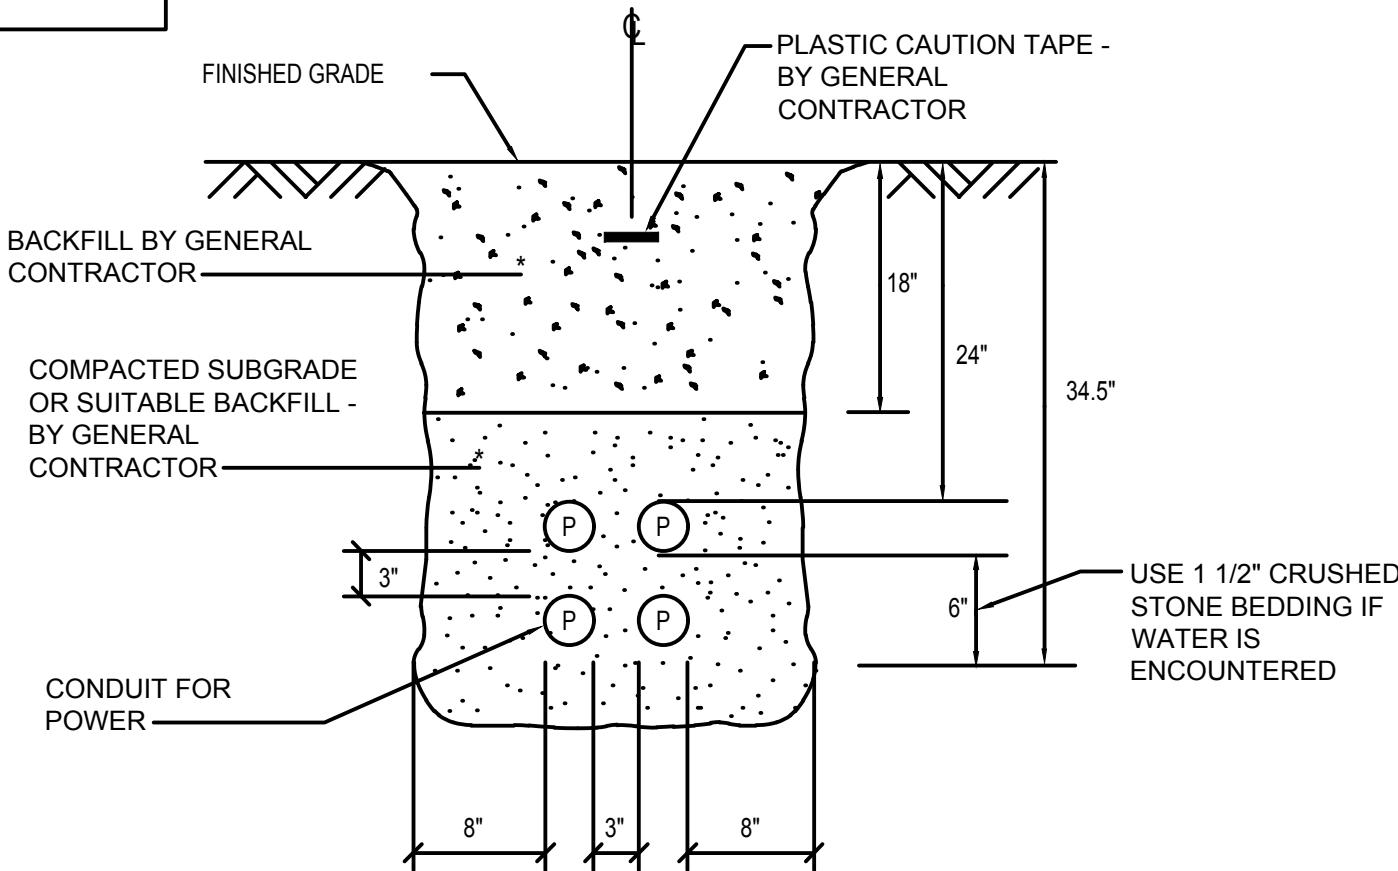

1 TYPICAL DIRECT BURIED MULTIPLE CONDUIT DETAIL

NOT TO SCALE

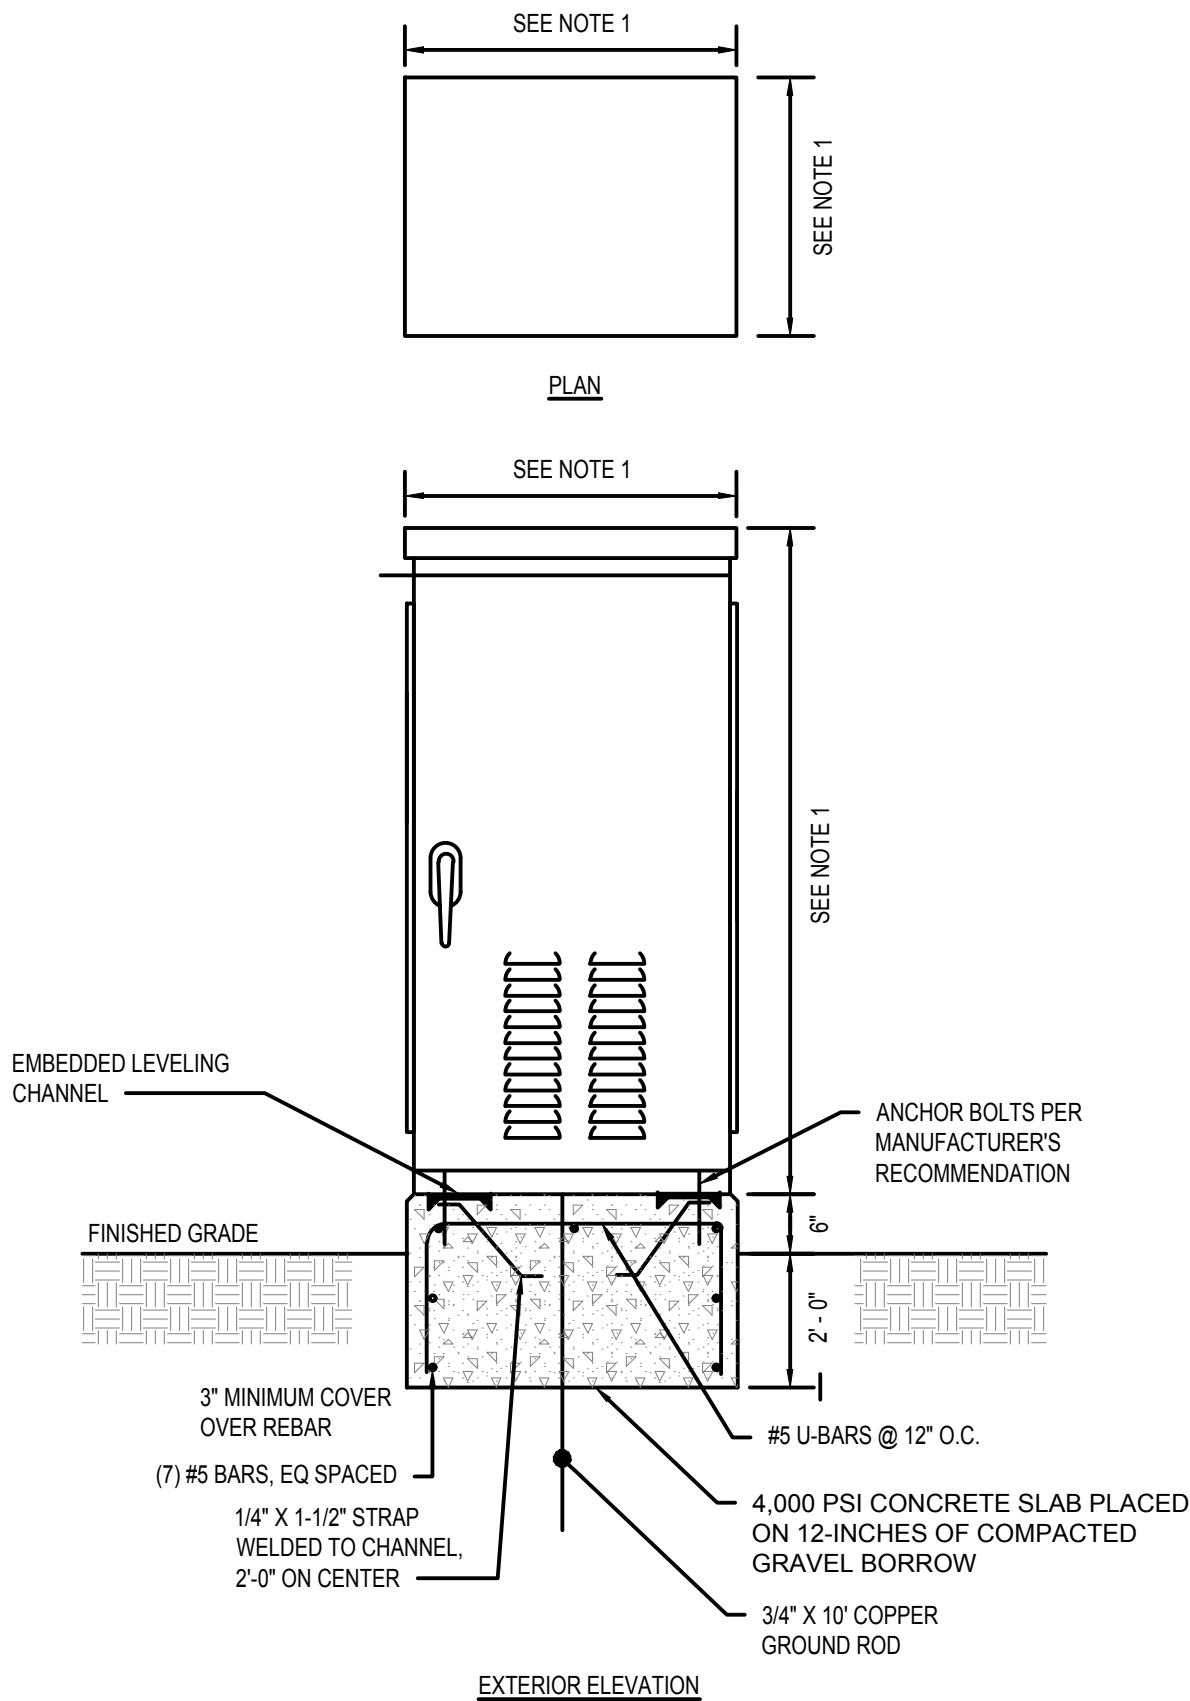

NOTES:

- CONTRACTOR SHALL COORDINATE WITH THE EXACT CABINET SIZE WITH ALL MANUFACTURER EQUIPMENT SIZES PRIOR TO SUBMITTING THE CABINET FOR APPROVAL. PROVIDE A SCALED DRAWING SHOWING ALL EQUIPMENT.

2 ELECTRICAL CABINET ENCLOSURE DETAIL

NOT TO SCALE

GENERAL ELECTRICAL NOTES

- DRAWINGS ARE DIAGRAMMATIC ONLY. THE EXACT LOCATION, MOUNTING HEIGHTS, SIZE OF EQUIPMENT AND ROUTING OF RACEWAYS SHALL BE COORDINATED AND DETERMINED IN THE FIELD.
- ALL STRAIGHT FEEDER, BRANCH CIRCUIT AND AUXILIARY SYSTEM CONDUIT RUNS SHALL BE PROVIDED WITH SUFFICIENT PULL BOXES TO LIMIT THE MAXIMUM LENGTH OF ANY SINGLE CABLE PULL TO 150 FEET. EXACT SIZES OF PULL BOXES AND LOCATIONS TO BE DETERMINED IN THE FIELD BY THE ELECTRICAL CONTRACTOR.
- THE ELECTRICAL CONTRACTOR SHALL COORDINATE WITH THE GENERAL CONTRACTOR AS APPLICABLE AS TO THE EXACT LOCATION OF THEIR RESPECTIVE EQUIPMENT; THE POWER WIRING, CONTROL WIRING AND ALL ELECTRICAL CONNECTIONS AND CONDUIT TURN-UPS SHALL BE COORDINATED WITH THE RESPECTIVE CONTRACTORS BEFORE THE START OF CONSTRUCTION IN THE FIELD.
- SLEEVES ARE TO BE UTILIZED FOR PASSAGE OF CONDUITS THROUGH FLOORS OR WALLS. CONDUITS AND BOXES ARE TO BE SUPPORTED BY THE USE OF PRESET FASTENERS INSTALLED IN FLOORS, WALLS OR COLUMNS. CONDUITS AND BOXES ARE TO BE INSTALLED CONCEALED IN MASONRY WALLS AND ABOVE HUNG CEILINGS. ALL SLEEVES ARE TO BE SEALED WITH APPROVED FIRE STOPPING SEALANT.
- COMBINED HOMERUNS OF TWO (2) OR THREE (3) CIRCUITS MAY BE UTILIZED. HOWEVER, THE NEUTRAL CONDUCTOR IS TO BE INCREASED TO #10AWG. COMBINED HOMERUNS ARE TO BE LIMITED TO 20A, LIGHTING AND POWER CIRCUITS.
- WORK SHALL CONFORM TO THE NATIONAL ELECTRICAL CODE WITH MASSACHUSETTS AMENDMENTS, MASSACHUSETTS BUILDING CODE, NFPA AND REQUIREMENTS OF LOCAL AUTHORITIES HAVING JURISDICTION.
- THE WORD "CONTRACTOR" AS USED IN THE "ELECTRICAL WORK" SHALL MEAN THE ELECTRICAL CONTRACTOR.
- CONTRACTOR SHALL PAY FOR ALL PERMITS, INSURANCE AND TESTS, AND SHALL PROVIDE LABOR AND MATERIAL TO COMPLETE THE ELECTRICAL WORK SHOWN.
- EXCEPT AS OTHERWISE NOTED, THE ELECTRICAL WORK SHALL INCLUDE PANELBOARDS, CIRCUIT BREAKERS, FEEDERS, WIRING, RACEWAYS AND CONNECTION NECESSARY TO OPERATE MOTORS AND OTHER EQUIPMENT.
- THE CONTRACTOR SHALL PROVIDE ALL TEMPORARY LIGHTING AND POWER AND THE GENERAL CONTRACTOR SHALL PAY ALL ENERGY CHARGES FOR TEMPORARY POWER AND LIGHTING.
- DURING CONSTRUCTION, THE ELECTRICAL CONTRACTOR SHALL KEEP HIS PORTION OF THE WORK NEAT, CLEAN AND ORDERLY.
- ALL SYSTEMS SHALL BE TESTED FOR SHORT CIRCUIT AND GROUNDS PRIOR TO ENERGIZING AND ANY DEFECTS SHALL BE CORRECTED.
- COMPLETE SHOP DRAWINGS SHALL BE SUBMITTED FOR ELECTRICAL EQUIPMENT. WHERE SPECIFIED ELECTRICAL EQUIPMENT IS SUBSTITUTED, THE ELECTRICAL CONTRACTOR SHALL SUBMIT COMPLETE SPECIFICATIONS ON THE SUBSTITUTE AS WELL AS THE ITEM ORIGINALLY SPECIFIED.
- MATERIALS SHALL BE SPECIFICATION GRADE AND UL LISTED.
- WHERE MATERIAL IS CALLED OUT IN THE LEGEND BY MANUFACTURER, TYPE OR CATALOG NUMBER, SUCH DESIGNATIONS ARE TO ESTABLISH STANDARDS OR DESIRED QUALITY. ACCEPTANCE OR REJECTIONS OF PROPOSED SUBSTITUTIONS SHALL BE SUBJECT TO THE APPROVAL OF THE OWNER.
- WORK SHALL BE COORDINATED WITH THAT OF OTHER TRADES TO ELIMINATE INTERFERENCES.
- ELECTRICAL WORK SHALL BE GUARANTEED FOR A PERIOD OF ONE YEAR FROM DATE OF FINAL COMPLETION.
- WORK SHALL BE GROUNDED IN ACCORDANCE WITH CODE REQUIREMENTS. COMPLETE EQUIPMENT (INSULATED GREEN WIRE) GROUNDING SYSTEM SHALL BE INSTALLED.
- WIRING METHODS:
  - A. EXTERIOR UNDERGROUND FEEDERS SHALL BE PVC SCHEDULE 80 FOR DIRECT BURIED AND PVC SCHEDULE 40 FOR CONCRETE ENCASED.
  - B. EXTERIOR ABOVE GRADE FEEDERS SHALL BE RGS CONDUIT.
  - C. INTERIOR FEEDERS EXPOSED SHALL BE RGS CONDUIT.
- CONDUIT AND TUBING SHALL BE SUPPORTED ON GALVANIZED WALL BRACKETS, TRAPEZE HANGERS OR PIPE STRAPS SECURED BY MEANS OF TOGGLE BOLTS OR INSERTS IN WOOD CONSTRUCTION.
- FEEDER TAPS WILL NOT BE ALLOWED IN PANELBOARD GUTTERS.
- CONTRACTOR SHALL CHECK EXISTING CONDITIONS TO DETERMINE EXACT EXTENT OF WORK TO BE PERFORMED PRIOR TO BIDDING. DIMENSIONS RELEVANT TO EXISTING WORK SHALL BE VERIFIED IN THE FIELD.
- IN AREAS NOT AFFECTED BY THIS RENOVATION, THIS SUBCONTRACTOR SHALL MAINTAIN CONTINUITY OF ELECTRIC SERVICE.
- WHERE CONNECTIONS ARE MADE IN EXISTING PANELS, THE PANEL INDEX SHALL BE REVISED TO INDICATE THE NEW LOADS SERVED. NEW CIRCUIT BREAKERS ADDED TO EXISTING PANELS SHALL BE THE SAME FRAME SIZE, VOLTAGE RATING AND INTERRUPTING CAPACITY AS EXISTING PANEL AND CIRCUIT BREAKERS.
- ELECTRICAL SHUTDOWN SHALL BE AT A TIME AND DATE APPROVED BY THE OWNER.
- PROVIDE AS-BUILT "CADD" DRAWINGS AT THE COMPLETION OF THE PROJECT.
- ELECTRICAL CONTRACTOR SHALL LABEL ALL ELECTRICAL DEVICES INCLUDING BUT NOT LIMITED TO RECEPTACLES, PANELBOARDS, CONTROL PANELS, JUNCTION BOXES, ETC.
  - A. RECEPTACLES - PANEL NAME AND CIRCUIT DESIGNATION
  - B. PANELBOARDS - PANEL NAME, VOLTAGE, AMPERAGE, PHASE AS WELL AS PANEL AND CIRCUIT IT IS FED FROM.
  - C. CONTROL PANEL - PANEL NAME AND CIRCUIT DESIGNATION
  - D. JUNCTION BOXES - PANEL NAME AND CIRCUIT DESIGNATION
- ADDRESS QUESTIONS TO THE ENGINEER IN WRITING BEFORE AWARD OF CONTRACT, OTHERWISE ENGINEER INTERPERTATION OF MEANING AND INTENT OF DRAWINGS SHALL BE FINAL.

Project:

CITY OF WORCESTER  
KELLEY SQUARE PYLON  
WORCESTER, MA 01604



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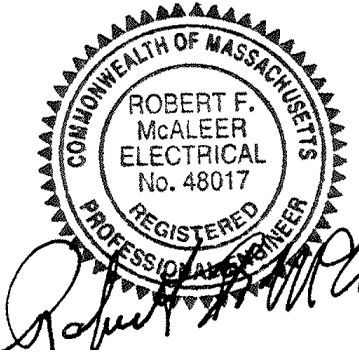
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Revisions:

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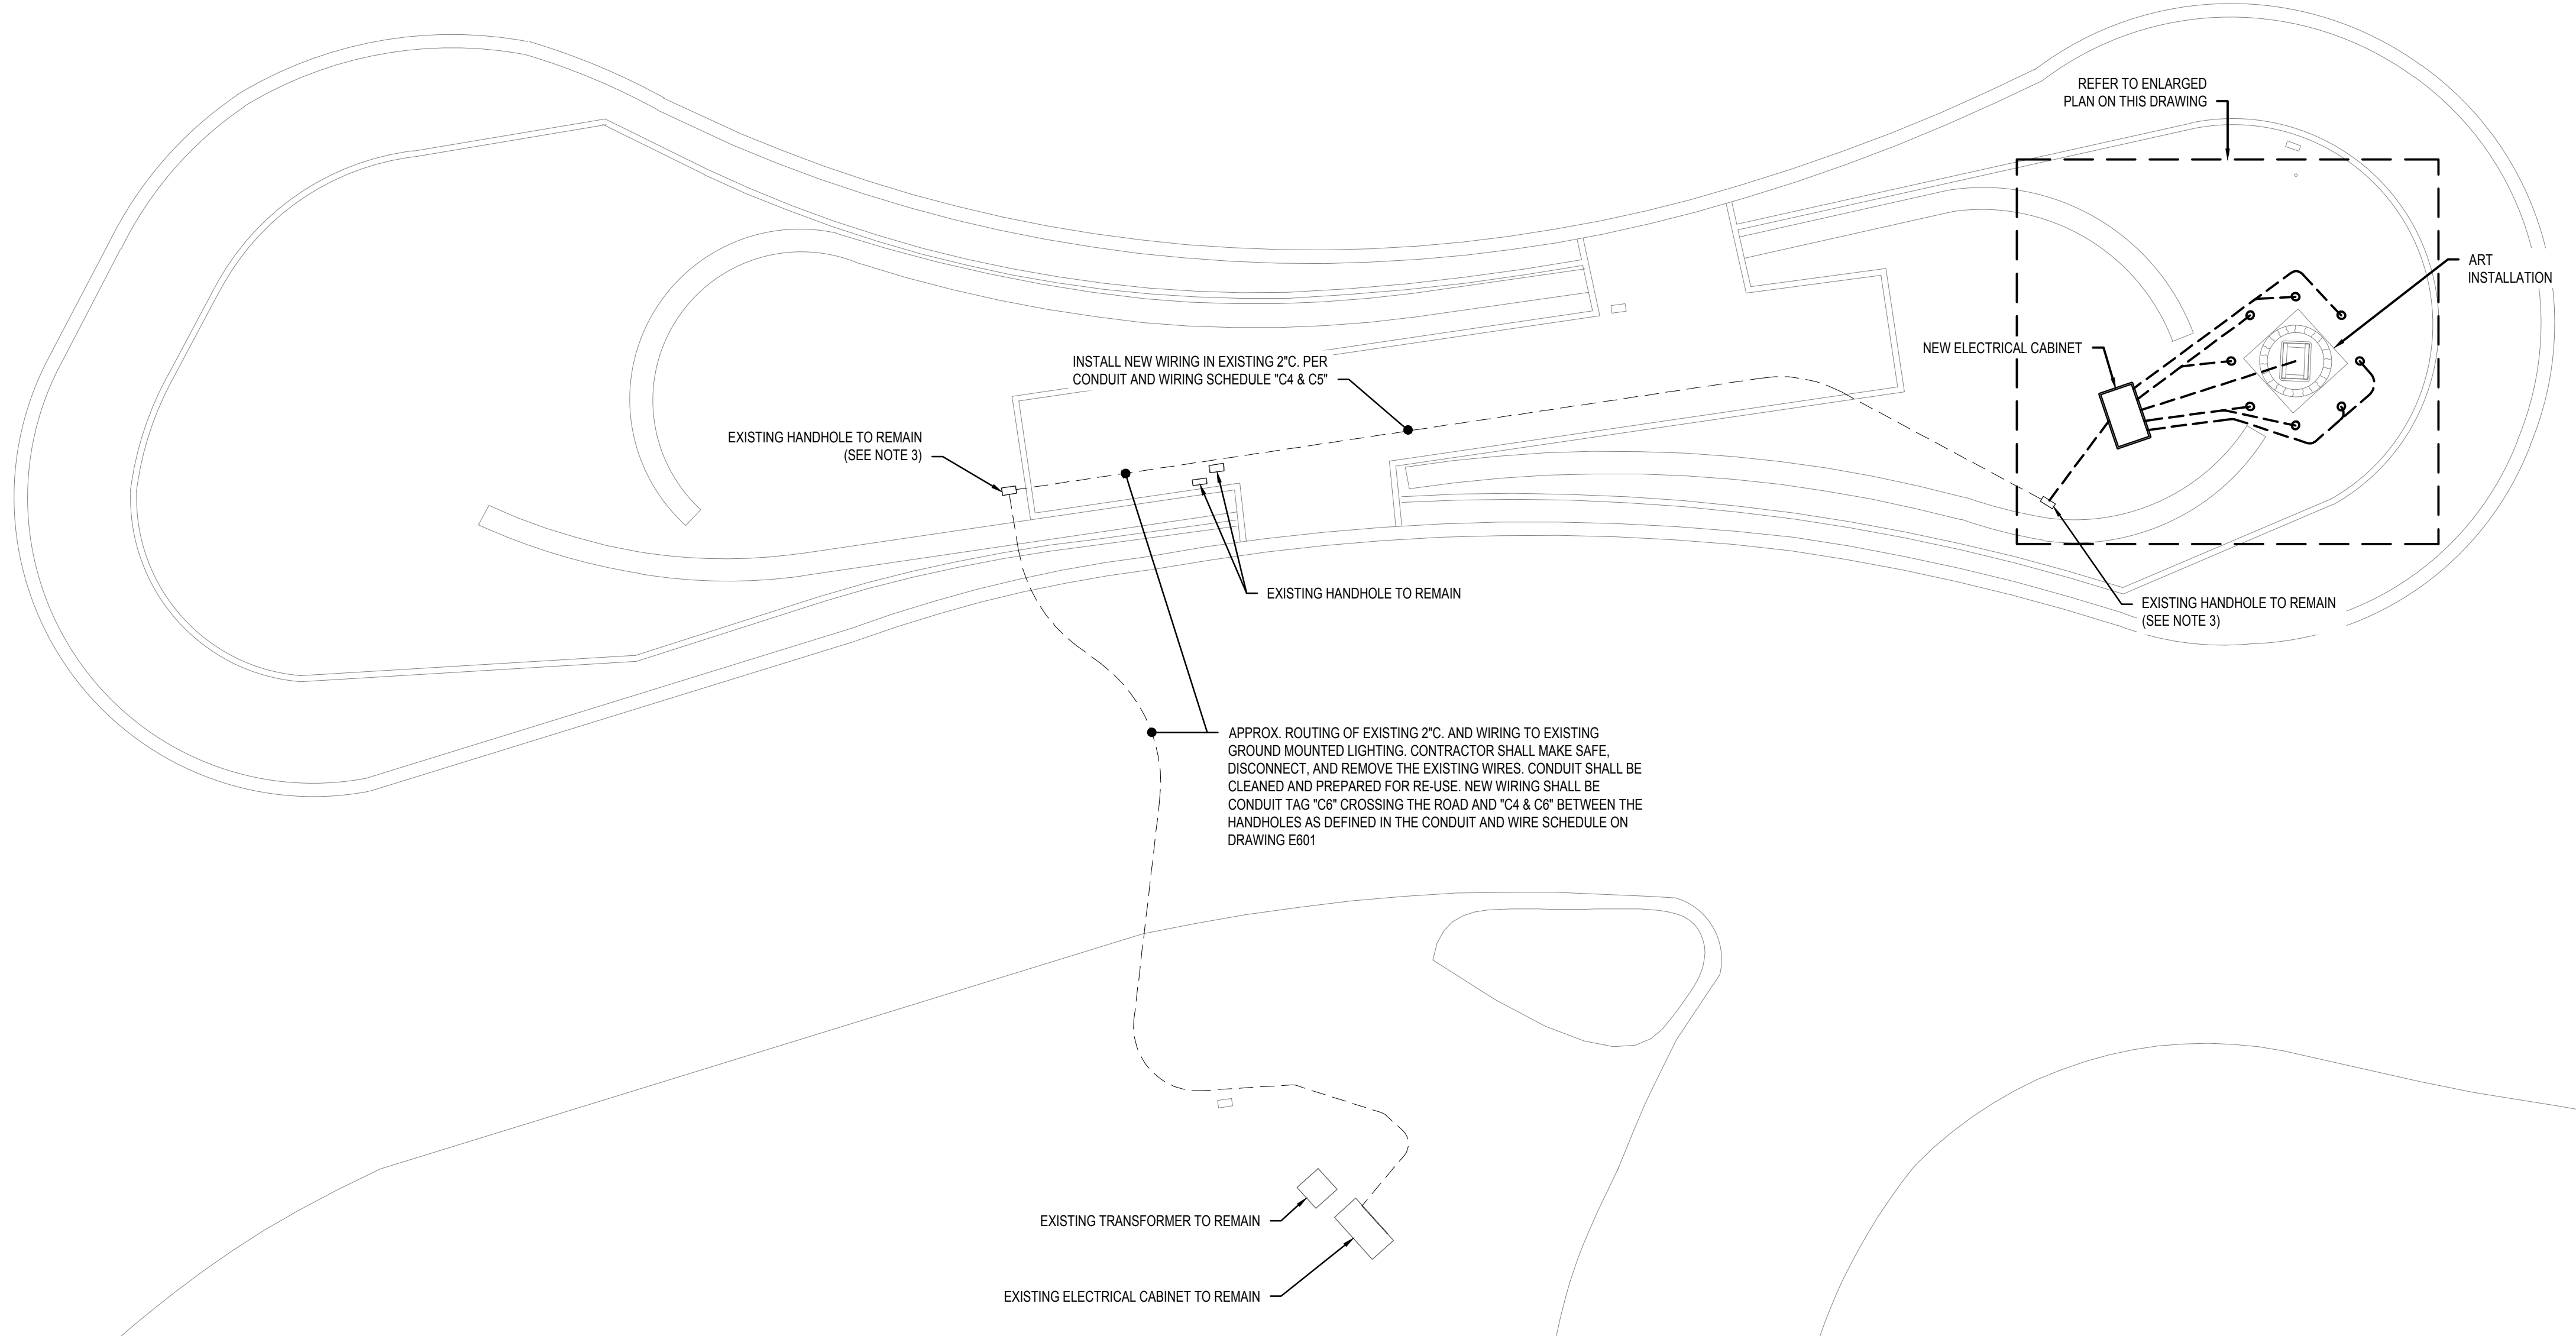
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ELECTRICAL LEGEND,  
ABBREVIATIONS, AND  
GENERAL NOTES



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E001





1 ELECTRICAL SITE PLAN  
SCALE: 1" = 10'

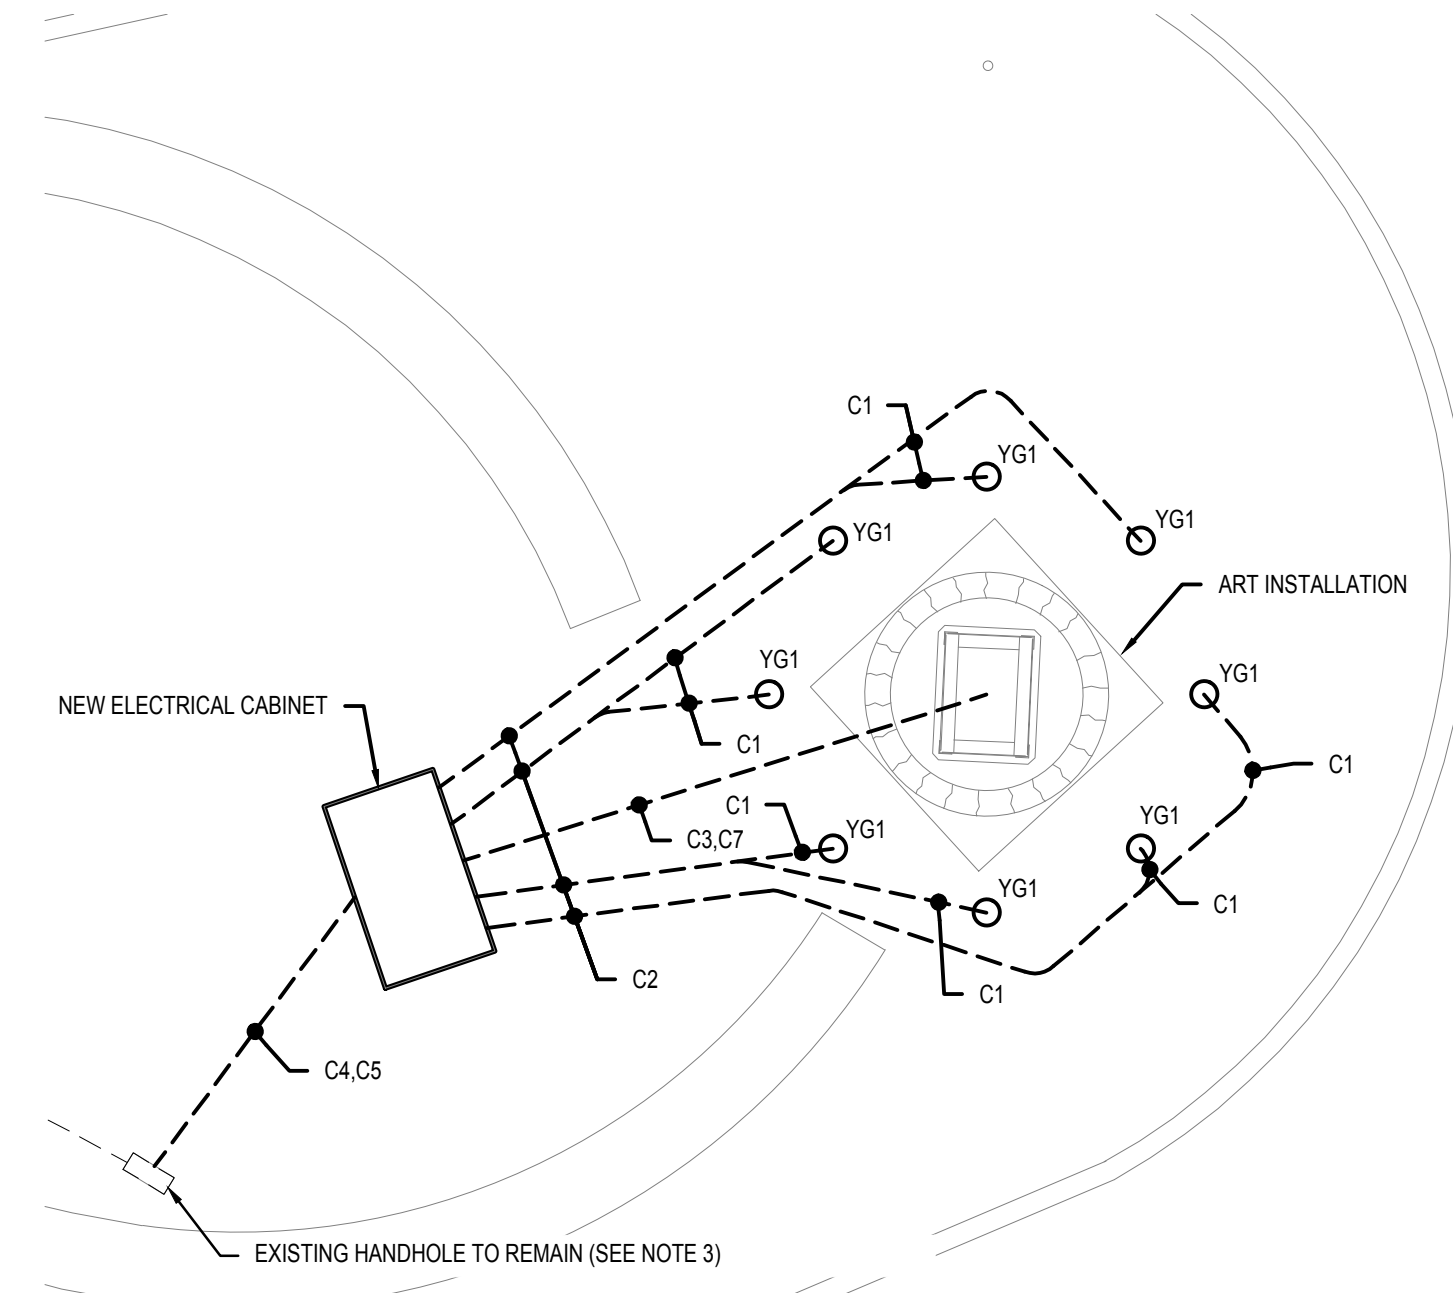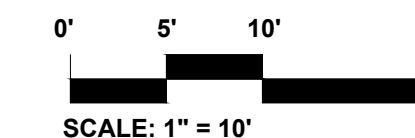

2 ENLARGED ART INSTALLATION LIGHTING PLAN  
SCALE: 1" = 5'



3 PHOTO 1: EXISTING ELECTRICAL CABINET AND TRANSFORMER  
NOT TO SCALE

- DRAWING NOTES:
1. REFER TO DRAWING E001 FOR LEGEND, ABBREVIATIONS, AND GENERAL NOTES.
  2. REFER TO DRAWING E601 FOR ONE LINE DIAGRAM, LIGHTING CONTROL RISER DIAGRAM, CONDUIT AND WIRE SCHEDULE, PANELBOARD SCHEDULES, AND LIGHTING FIXTURE SCHEDULE.
  3. CONTRACTOR SHALL MAINTAIN EXISTING WIRING FROM HANDHOLES TO EXISTING GROUND LIGHTS FOR BACK FEED FROM NEW PANEL P2G1 TO EXISTING GROUND LIGHTING CIRCUIT.

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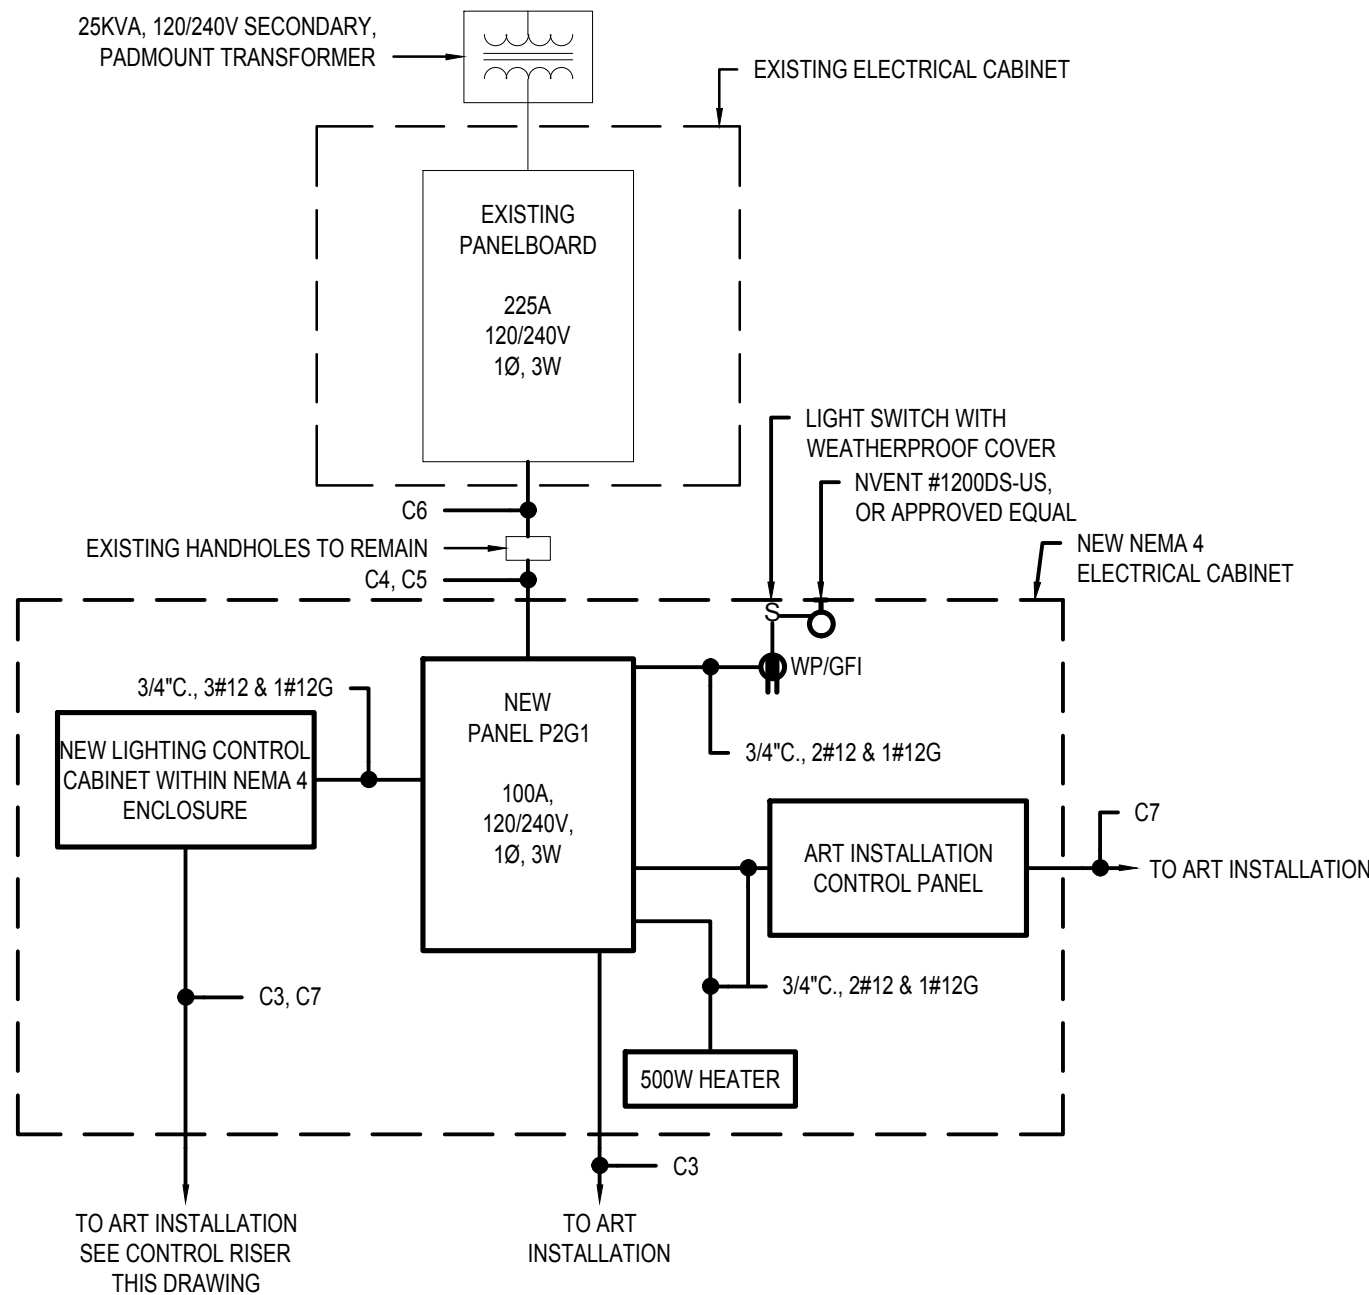
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Drawing Title:  
**ELECTRICAL SITE PLAN**

Sheet Number:  
**E101**






1 ONE LINE DIAGRAM

NOT TO SCALE

- P1 LINE VOLTAGE, 20A, 120V  
1" C., 2#12 & 1#12G
- P2 LINE VOLTAGE, 10A, 120V  
1" C., 2#12 & 1#12G  
(CONTROLLED VIA RELAY)
- P3 LOW VOLTAGE, 24V  
(INSTALLED IN 1" CONDUIT)
- P4E CAT 6 ETHERNET  
WITH P4E
- DMX DMX BELDEN  
#8729 OR EQUAL
- CONTROL 1 TYPE CONTROL 1  
TIME CLOCK
- CONTROL 2 TYPE CONTROL 2  
DMX GATEWAY
- CONTROL 8 TYPE CONTROL 8  
P4E NETWORK SWITCH
- CONTROL 9 TYPE CONTROL 9  
BUTTON STATION
- CONTROL 13 TYPE CONTROL 13  
DMX DRIVER FOR TYPE YG1
- CONTROL 14 TYPE CONTROL 14  
DMX-CONTROLLED RELAY

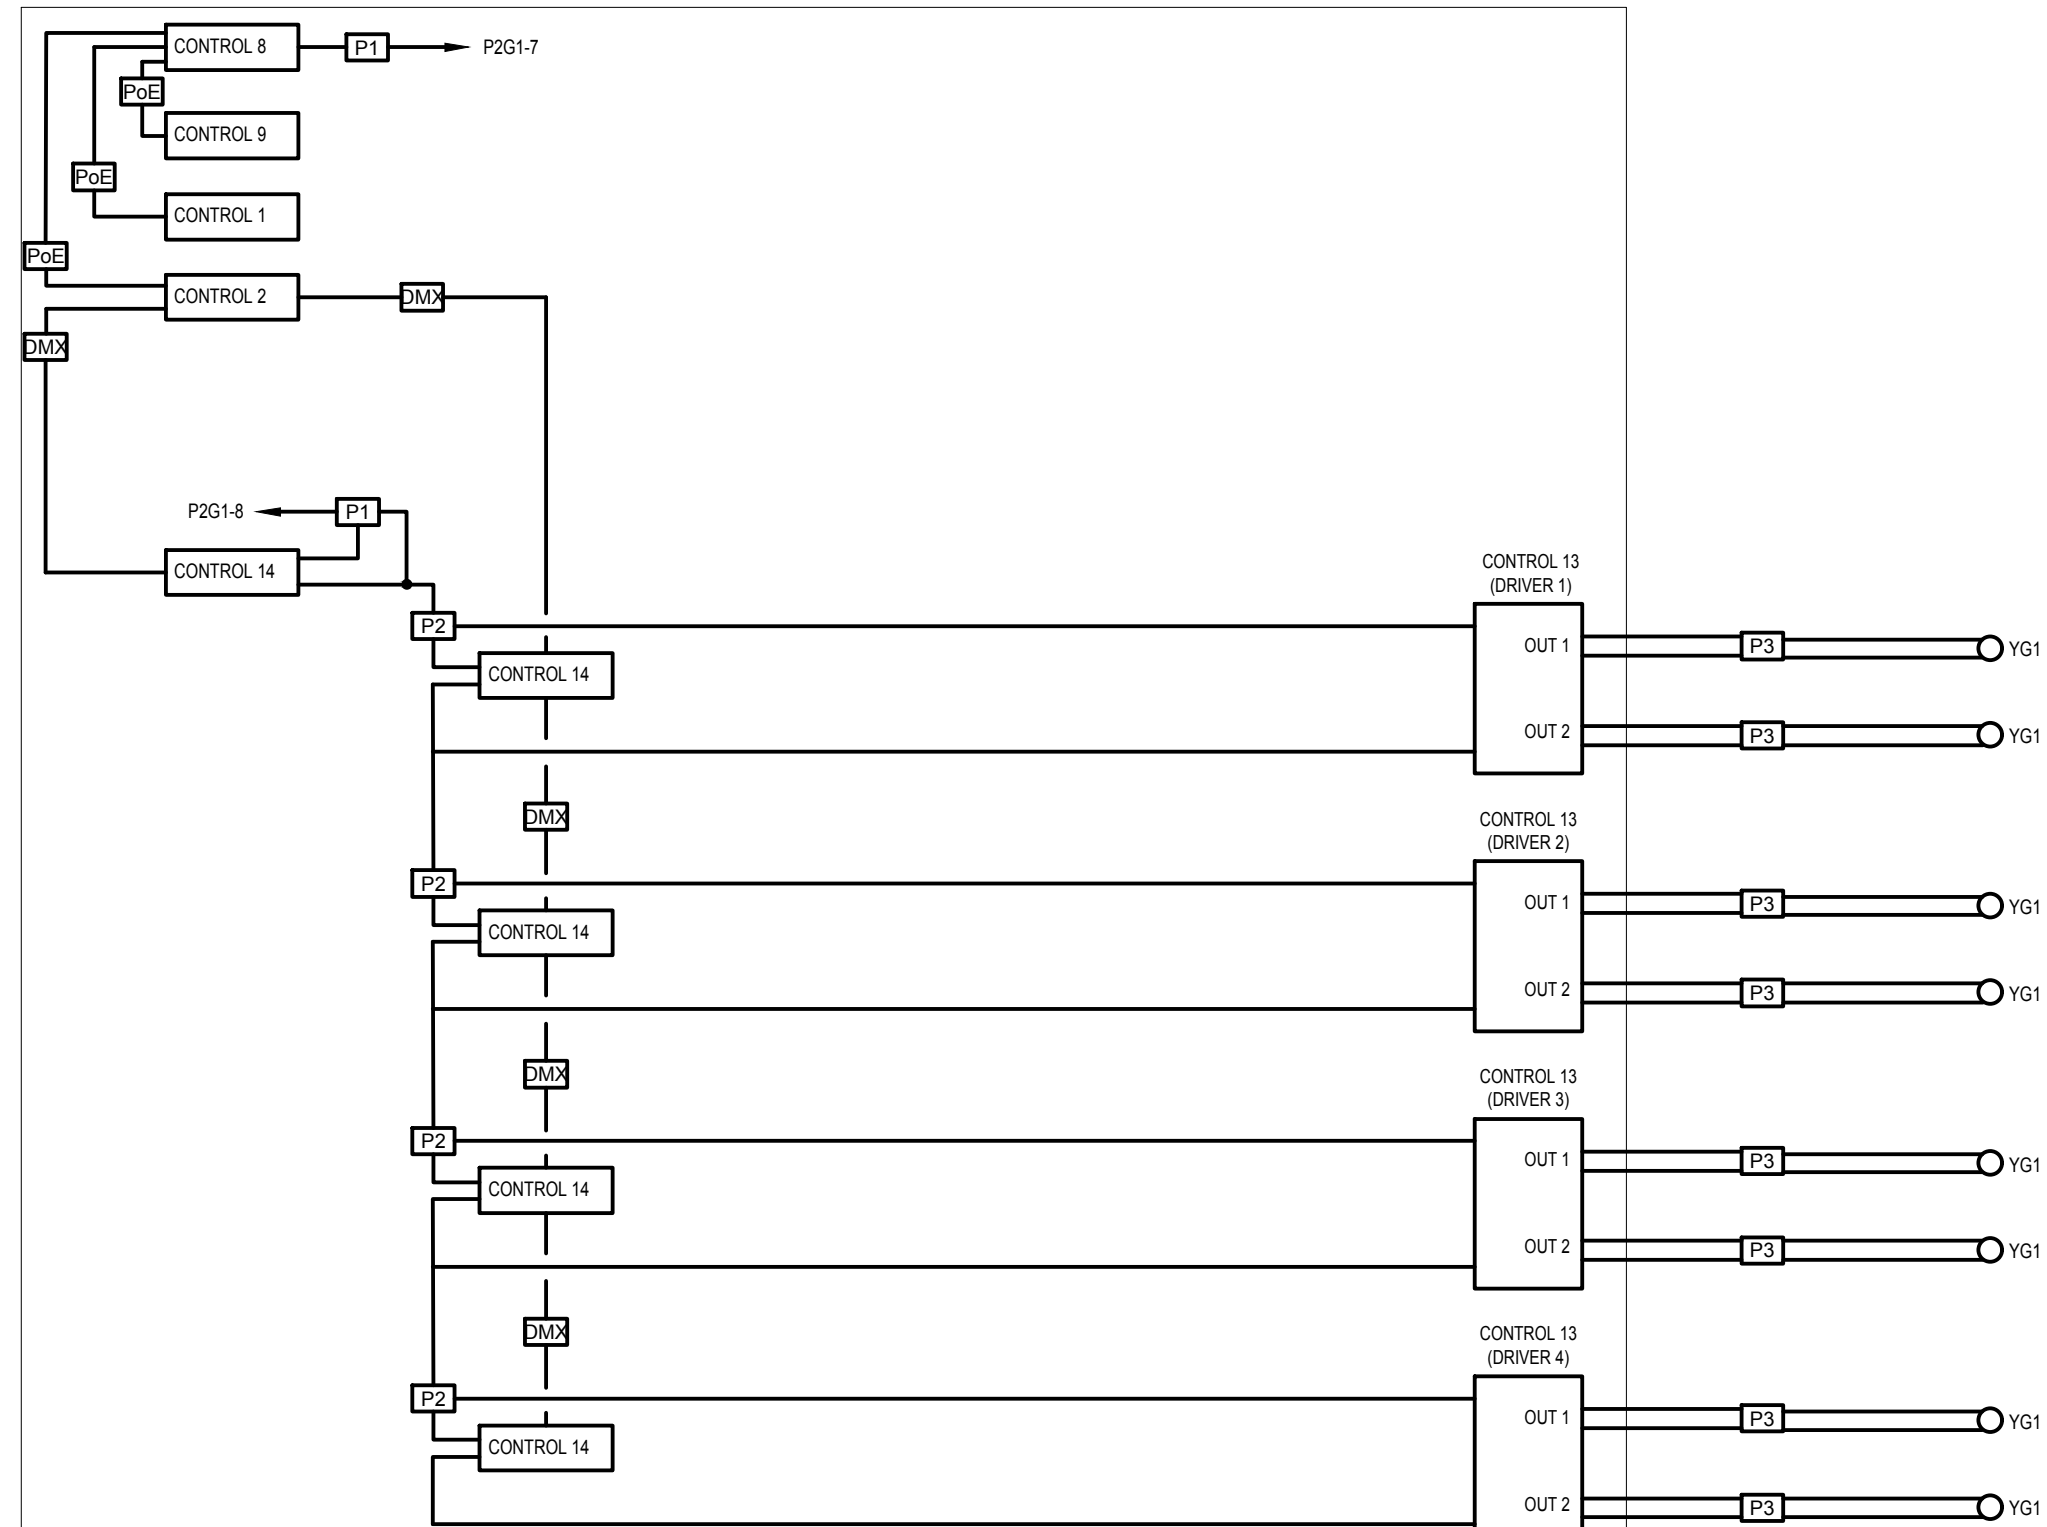

2 LIGHTING CONTROL RISER DIAGRAM

NOT TO SCALE

### PANELBOARD SCHEDULE

DESIGNATION: EXISTING PANELBOARD						
S.C. RATING: EXISTING						
REMARKS:						
LOCATION: EXISTING ELECTRICAL ENCLOSURE						
SERVICE: 120/240V, 1Ø, 3W						
RATING: 225 A						
MOUNTING: SURFACE						
MAIN: 100 A MCB						
CKT. NO.	LOAD DESIGNATION	CIRCUIT BREAKER	LOAD		CIRCUIT BREAKER	LOAD DESIGNATION
			A	B		
1	HARDING ST W OUTLETS	20			20	HARDING ST W LIGHTING
3	HARDING ST W OUTLETS	20				
5	HARDING ST E OUTLETS	20				
7	HARDING ST E OUTLETS	20			20	HARDING ST E LIGHTING
9	KELLEY SQ N OUTLETS	20				
11	KELLEY SQ N OUTLETS	20			20	KELLEY SQ N LIGHTING
13	KELLEY SQ S OUTLETS	20				
15	KELLEY SQ S OUTLETS	20			20	KELLEY SQ S LIGHTING
17	HARDING ST S OUTLETS	20				
19	SPARE	20			20	KELLEY SQ N LIGHTING
21	CABINET LIGHT AND GFI	20				
23	CONTACTOR CONTROLS	20			20	KELLEY SQ N LIGHTING
25	RRFB EAST	20				
27	RRFB MIDDLE	20			20	KELLEY SQ S LIGHTING
29	RRFB WEST	20				
31	PEANUT PEDESTAL	50				
33					20	HARDING ST S LIGHTING
35	NEW PANEL P2G1	30				
37	SPACE					SPACE
39	SPACE					SPACE
41	SPACE					SPACE
SUB-TOTAL						
TOTAL				KVA		
ESTIMATED DEMAD LOAD				KVA		
TOTAL DEMAND CURRENT				AMPS		

CONTRACTOR SHALL MAKE SAFE AND DISCONNECT EXISTING WIRES  
CONNECTED TO EXISTING 20A-1P CIRCUIT BREAKER LABELED "GROUND  
LIGHTING." EXISTING BREAKER SHALL BE RE-LABELED AS "SPARE"

### PANELBOARD SCHEDULE

DESIGNATION: NEW PANEL P2G1						
S.C. RATING: 10,000 AIC						
REMARKS:						
LOCATION: NEW ELECTRICAL ENCLOSURE						
SERVICE: 120/240V, 1Ø, 3W						
RATING: 100 A						
MOUNTING: SURFACE						
MAIN: 60 A MCB						
CKT. NO.	LOAD DESIGNATION	CIRCUIT BREAKER	LOAD		CIRCUIT BREAKER	LOAD DESIGNATION
			A	B		
1	ART INSTALLATION	20	0.80		20	SPARE
3	SPARE	20		1.92	20	CABINET LIGHT AND GFI
5	CABINET HEATER	20	0.50		20	SPARE
7	POE NETWORK SWITCH	20		1.00	20	DMX CONTROLLED RELAY
9	EXISTING GROUND LIGHTING	20			20	ART INSTALLATION CONTROL PANEL
11	SPACE	20			20	SPACE
13	SPACE	20			20	SPACE
15	SPACE	20			20	SPACE
17	SPACE	20			20	SPACE
SUB-TOTAL			1.30	2.92		
TOTAL			4.22	KVA		
ESTIMATED DEMAD LOAD			3.80	KVA		
TOTAL DEMAND CURRENT			15.8	AMPS		

### CONDUIT AND WIRE SCHEDULE

CONDUIT TAG	FEEDER	FROM	TO	REMARKS
C1	1" C., REFER TO LIGHTING CONTROL RISER DIAGRAM ON THIS DRAWING	DMX DRIVER	FIXTURE YG1	DIRECT BURIED
C2	(2) 1" C., REFER TO LIGHTING CONTROL RISER DIAGRAM ON THIS DRAWING	DMX DRIVER	FIXTURE YG1	DIRECT BURIED
C3	1" C., 2#12 & 1#12G	P2G1-1	ART INSTALLATION	DIRECT BURIED
C4	2" C., WIRING TO MATCH EXISTING GROUND LIGHTING WIRING IN SIZE AND TYPE	P2G1-9	EXISTING HANDHOLE	DIRECT BURIED
C5	1" C., 3#6 & 1#10G	EXISTING HANDHOLE	PANEL P2G1 MAIN	DIRECT BURIED
C6	3#6 & 1#10G INSTALLED IN EXISTING 2" C.	EXISTING ELECTRICAL CABINET PANEL CKT NO. 35.37	EXISTING HANDHOLE	NEW WIRES IN EXISTING CONDUIT
C7	1" C., EMPTY WITH NYLON PULLSTRING	ART INSTALLATION CONTROL PANEL	ART INSTALLATION	DIRECT BURIED

### LIGHTING FIXTURE SCHEDULE

FIXTURE TYPE	DESCRIPTION	MANUFACTURER	LAMP TYPE	VOLTAGE	LOAD	MOUNTING	NOTES
YG1	GROUND RECESSED ASYMMETRIC UPLIGHT, IP68, NOMINAL 2.25" DIAMETER, REMOTE DRIVER	ERCO #B2000328	LED 137 LUMENS 3000K	120	3W	IN-GRADE	

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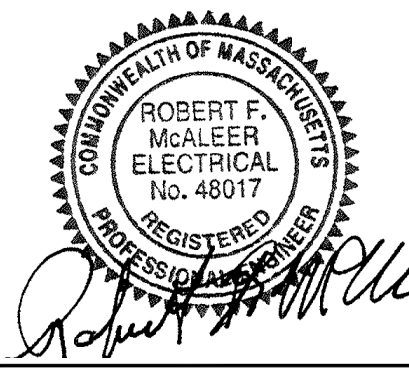
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### ELECTRICAL SCHEDULES AND DIAGRAMS

Sheet Number:

E601