

CITY OF WORCESTER, MASSACHUSETTS

MADISON STREET UNDERPASS LIGHTING

Madison Street, Worcester, MA

Focus Map

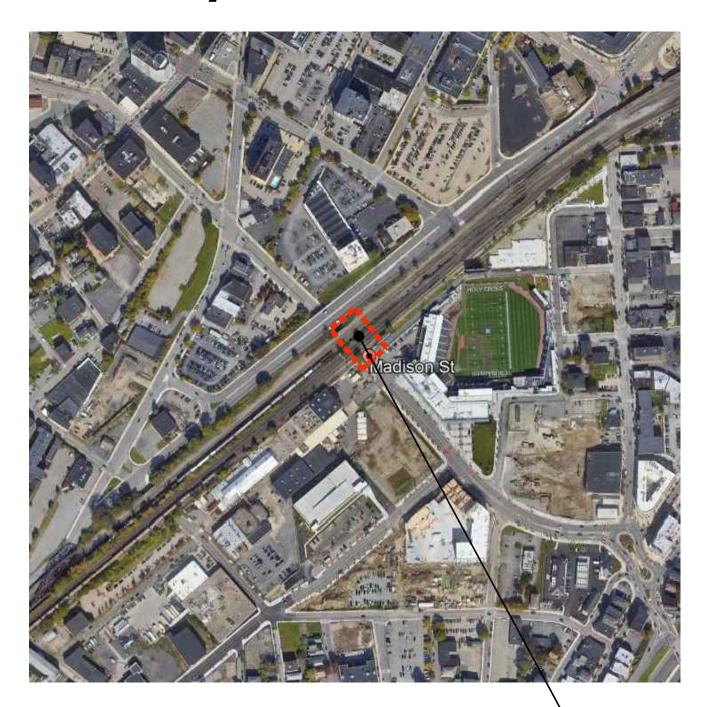

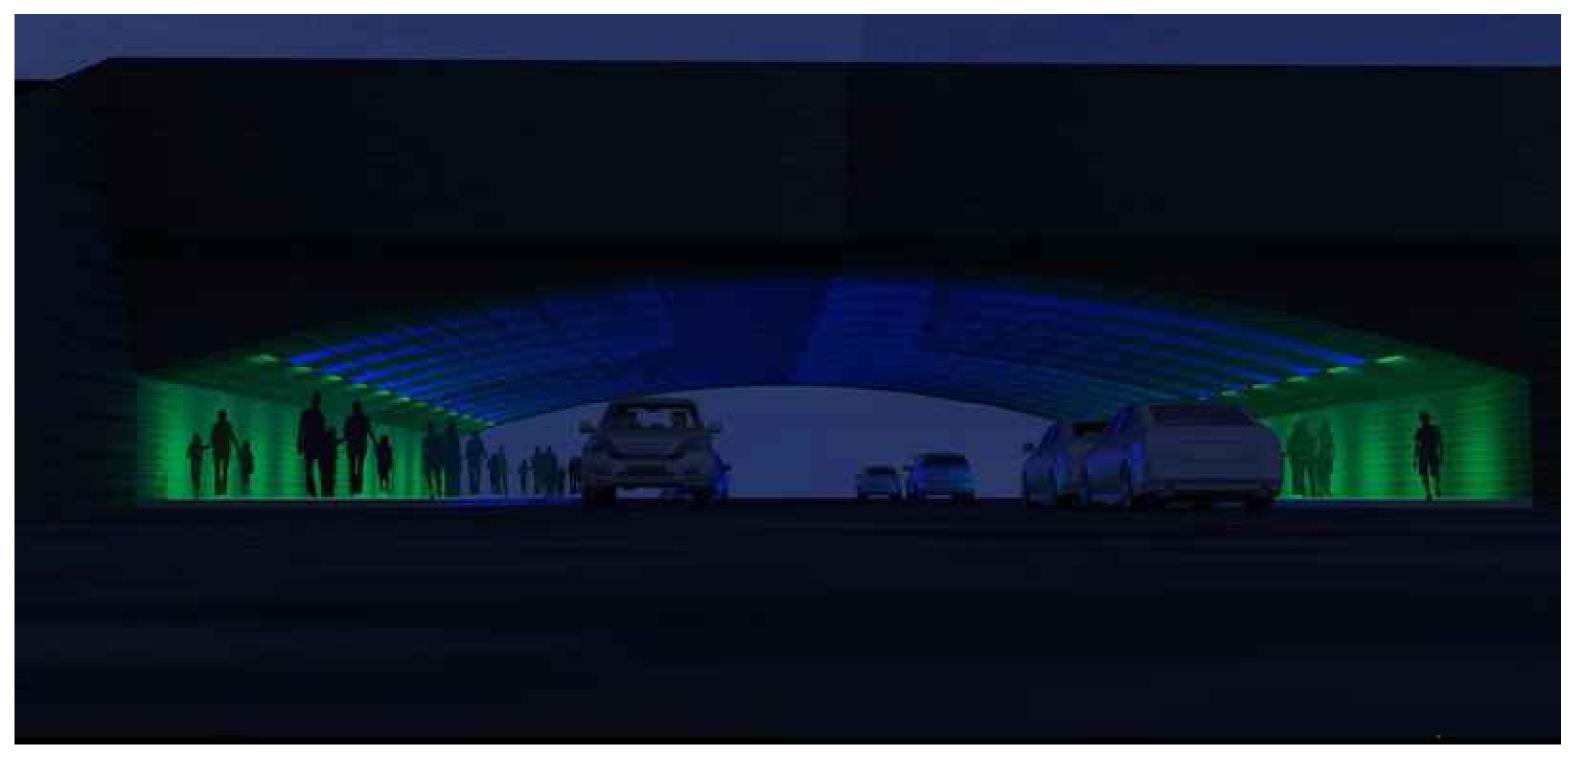

ILLUSTRATIVE REPRESENTATION

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ED001	ELECTRICAL DEMOLITION SITE PLAN
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E601	ELECTRICAL SCHEDULES

UNDERPASS ART LIGHT
PROJECT SITE



BID DOCUMENTS
September 26th, 2023







L000

GENERAL NOTES:

- 1. PROPERTY LINES COMPILED VIA MASSACHUSETTS GIS DATA.
- 2. ALL BIDDERS ARE EXPECTED TO INSPECT THE PROJECT SITE IN ITS ENTIRETY PRIOR TO 6. ALL AREAS DISTURBED BY THE CONTRACTOR'S OPERATIONS OUTSIDE THE PROJECT LIMITS, 12. CONTRACTOR SHALL COORDINATE ALL WORK WITH THE OWNER'S REPRESENTATIVE. SUBMITTING THEIR BID, AND BECOME FAMILIAR WITH ALL CONDITIONS AS THEY MAY AFFECT THEIR BID. CONTRACTOR AND SUB-CONTRACTOR SHALL BE FAMILIAR WITH ALL DRAWINGS AND SPECIFICATIONS PRIOR TO COMMENCING THE CONSTRUCTION.
- 3. LOCATIONS OF ANY UTILITIES SHOWN ON THESE PLANS ARE APPROXIMATE ONLY. CONTRACTOR SHALL BE RESPONSIBLE FOR VERIFYING THE LOCATION OF SUCH UTILITIES, PROTECTING ALL EXISTING UTILITIES AND REPAIRING ANY DAMAGE DONE DURING CONSTRUCTION. THE CONTRACTOR SHALL BE RESPONSIBLE FOR ALL ON-SITE COORDINATION WITH UTILITY COMPANIES AND PUBLIC AGENCIES AND FOR OBTAINING ALL 82, SECTION 40, INCLUDING AMENDMENTS, CONTRACTORS SHALL NOTIFY ALL UTILITY COMPANIES AND GOVERNMENT AGENCIES IN WRITING PRIOR TO EXCAVATION. CONTRACTOR SHALL ALSO CALL "DIG SAFE" AT (888) 344-7233 NO LESS THAN 72 HOURS, (EXCLUSIVE OF 9. FILLING OF EXCAVATED AREAS SHALL NOT TAKE PLACE WITHOUT THE PRESENCE OR WEEKENDS AND HOLIDAYS), PRIOR TO SUCH EXCAVATION. DOCUMENTATION OF REQUESTS SHALL BE PROVIDED TO OWNER'S REPRESENTATIVE PRIOR TO EXCAVATION WORK.
- 4. ANY DISCREPANCIES OR CONFLICTS BETWEEN THE DRAWINGS AND EXISTING CONDITIONS, EXISTING CONDITIONS TO REMAIN, TEMPORARY CONSTRUCTION, PERMANENT CONSTRUCTION AND WORK OF ADJACENT CONTRACTS SHALL BE BROUGHT TO THE ATTENTION OF THE OWNER'S REPRESENTATIVE BEFORE PROCEEDING. ITEMS ENCOUNTERED IN AREAS OF EXCAVATION THAT ARE NOT INDICATED ON THE DRAWINGS, BUT ARE VISIBLE ON SURFACE, SHALL BE THE CONTRACTOR'S RESPONSIBILITY AND SHALL BE REMOVED AT NO ADDITIONAL COST TO THE OWNER.

- 5. ANY ALTERATIONS TO THESE DRAWINGS MADE IN THE FIELD DURING CONSTRUCTION SHALL BE RECORDED BY THE GENERAL CONTRACTOR ON "AS-BUILT" DRAWINGS.
- SHALL BE RESTORED TO THE ORIGINAL CONDITION BY THE CONTRACTOR AT NO ADDITIONAL COST AND TO THE SATISFACTION OF THE OWNER.
- 7. THE CONTRACTOR SHALL TAKE ALL NECESSARY PRECAUTIONS TO PROTECT HIS EMPLOYEES, AS WELL AS PUBLIC USERS FROM INJURY DURING THE ENTIRE CONSTRUCTION PERIOD USING ALL NECESSARY SAFEGUARDS, INCLUDING BUT NOT LIMITED TO, THE ERECTION OF TEMPORARY FENCES, WALKS, STRUCTURES, PROTECTIVE BARRIERS, OR COVERING AS
- REQUIRED PERMITS AND PAYING ALL REQUIRED FEES. IN ACCORDANCE WITH M.G.L. CHAPTER 8. THE CONTRACTOR SHALL SUPPLY THE OWNER WITH THE NAME OF THE OSHA "COMPETENT PERSON" PRIOR TO CONSTRUCTION.
 - PERMISSION OF THE OWNER'S REPRESENTATIVE.
 - 10. ALL EXISTING DRAINAGE FACILITIES TO REMAIN SHALL BE MAINTAINED FREE OF DEBRIS, SOIL, SEDIMENT, AND FOREIGN MATERIAL AND OPERATIONAL THROUGHOUT THE LIFE OF THE CONTRACT. REMOVE ALL SOIL, SEDIMENT, DEBRIS AND FOREIGN MATERIAL FROM ALL DRAINAGE STRUCTURES, INCLUDING BUT NOT LIMITED TO, DRAINAGE INLETS, MANHOLES AND CATCH BASINS WITHIN THE LIMIT OF WORK AND DRAINAGE STRUCTURES OUTSIDE THE LIMIT OF WORK THAT ARE IMPACTED BY THE WORK FOR THE ENTIRE DURATION OF

- 11. THE CONTRACTOR SHALL KEEP ALL STREETS, PARKING LOTS AND WALKS THAT ARE NOT RESTRICTED FROM PUBLIC USE DURING CONSTRUCTION BROOM CLEAN AT ALL TIMES. THE CONTRACTOR SHALL USE ACCEPTABLE METHODS AND MATERIALS TO MAINTAIN ADEQUATE DUST CONTROL THROUGHOUT CONSTRUCTION.

WORCESTER UNDERPASS LIGHTING MADISON STREET WORCESTER, MA

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Revisions:						
No.	Date	Description				




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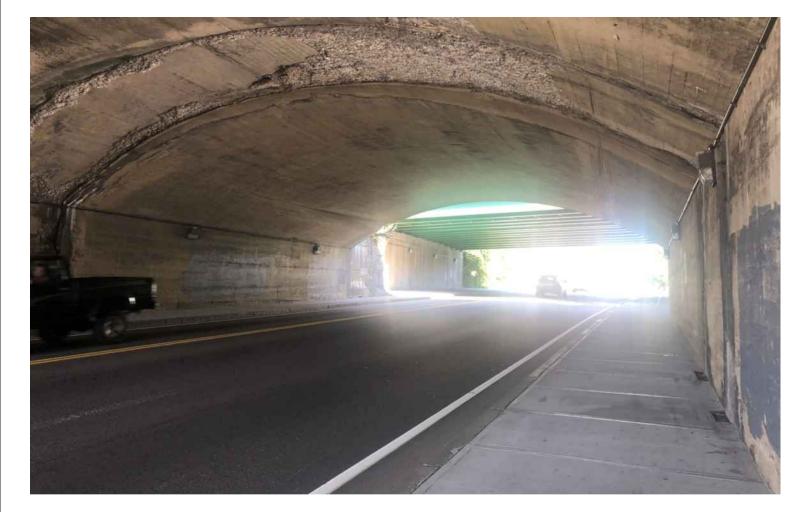
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Approved By: BK

W&S Project No.: ENG23-0722

GENERAL NOTES



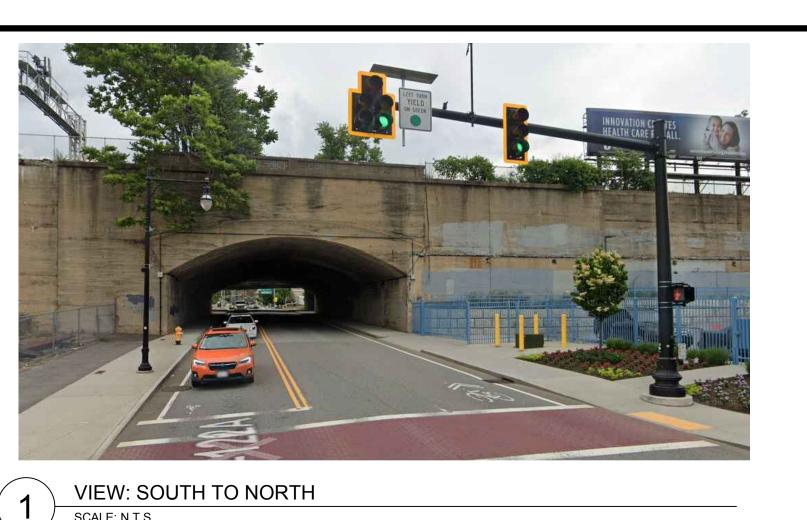

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VIEW: SOUTH TO NORTH SCALE: N.T.S.




VIEW: SOUTH TO NORTH SCALE: N.T.S.



EXISTING HANDHOLE SCALE: N.T.S.



6 VIEW: NORTH TO SOUTH SCALE: N.T.S.

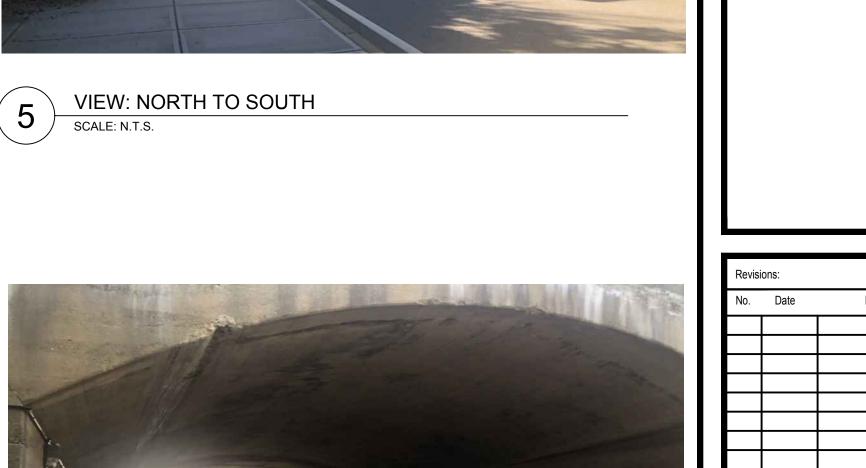

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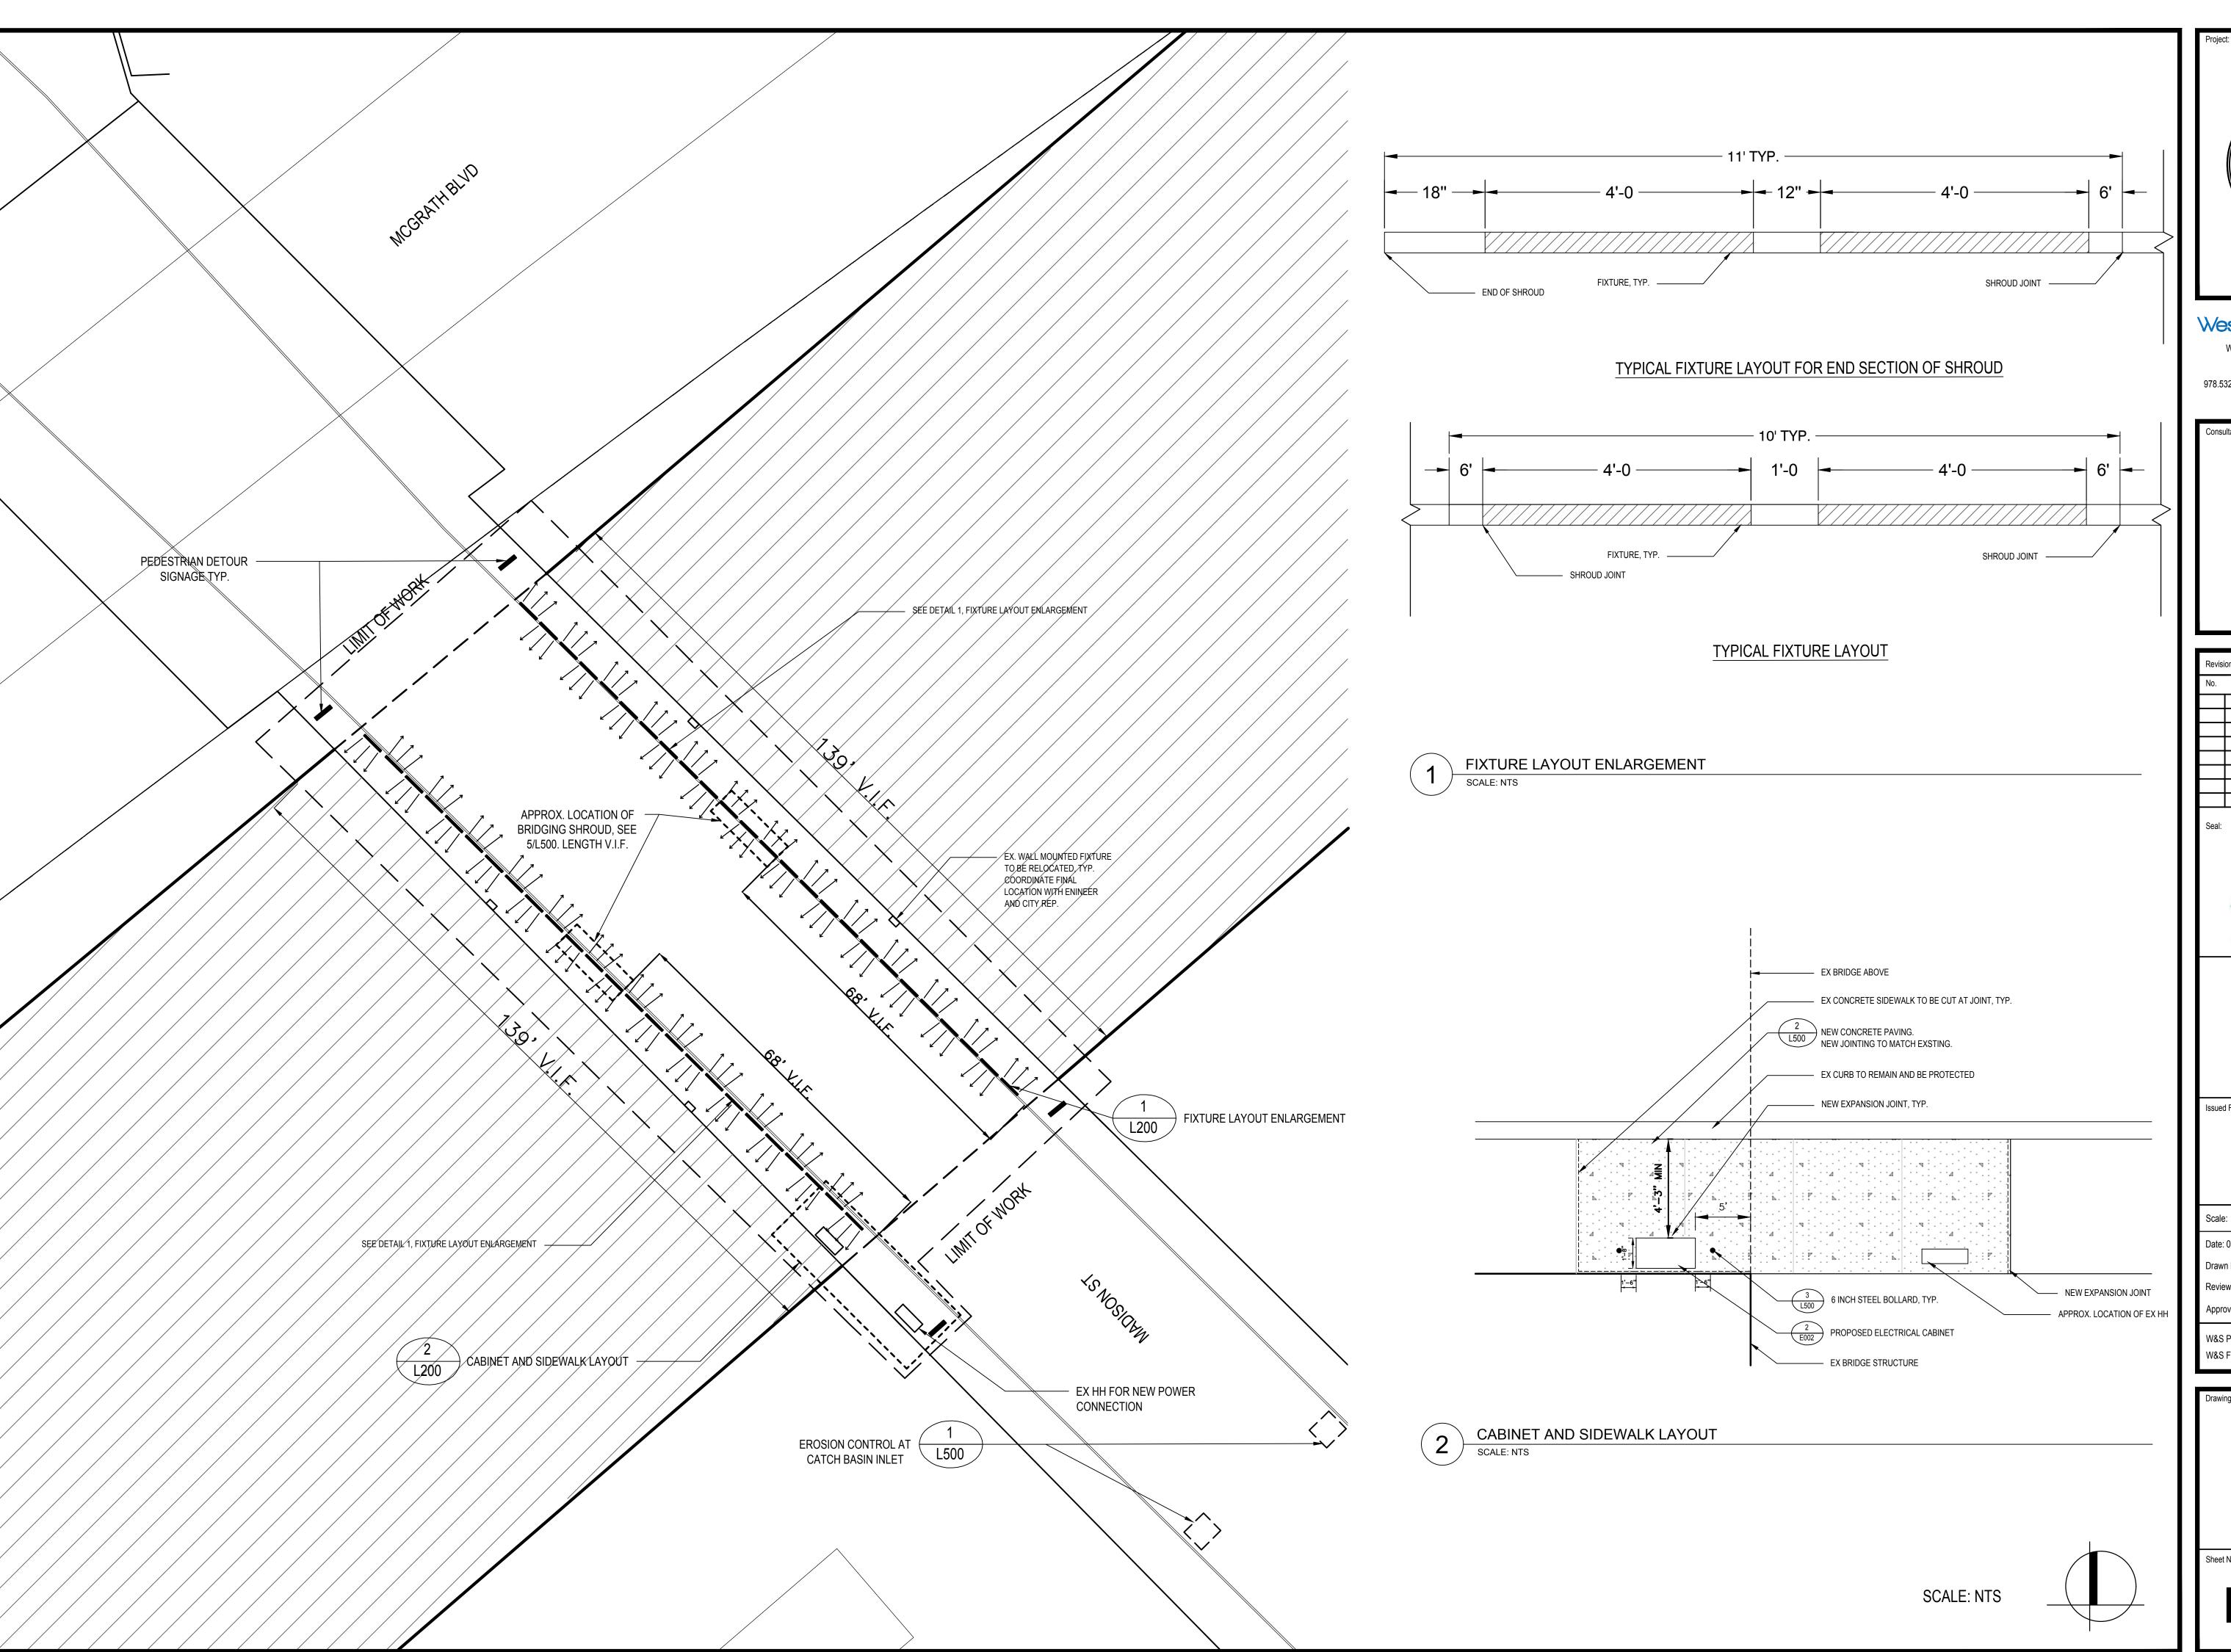
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EXISTING CONDITIONS

SCALE: NTS



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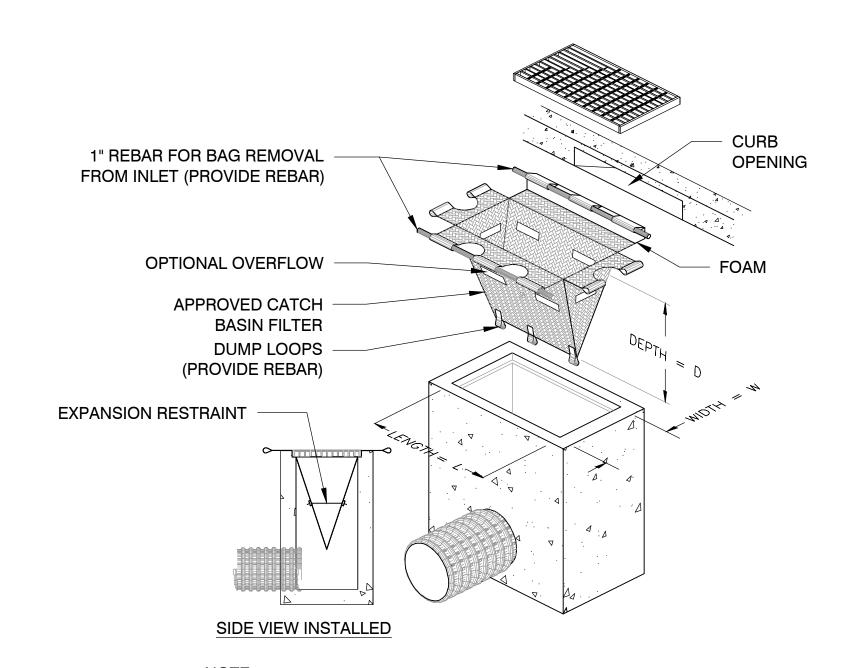
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Drawing Title:

SITE PLAN



AFFECTED BY CONSTRUCTION.

CATCH BASIN FILTER FOR PAVED AREAS SHALL BE PROVIDED FOR

ALL DRAINAGE STRUCTURES WITHIN THE LIMIT OF WORK AND ANY


STRUCTURES OUTSIDE THE PROJECT TERMINII THAT ARE

EROSION CONTROLS- SEDIMENT SACK SCALE: NTS

#6 SMOOTH DOWEL, 1'-0" MEDIUM BROOM FINISH, CONTROL JOINTS TO PERPENDICULAR TO LONG, 18" O.C. 4 X 4 WWM ON CHAIRS — MATCH EXISTING IN DIRECTION OF TRAVEL TYPE AND PATTERN. - SPECIFIED SEALANT TO MIN. - FINISHED GRADE, MATERIAL ½" DEPTH VARIES, SEE PLANS 4" DEPTH. - ½" WIDE FULL DEPTH CEMENT CONCRETE SEE NOTE 2 EXPANSION JOINT WITH PAVEMENT, SEE WATERPROOF SEALANT, SPECIFICATIONS SEE SPECS. COMPACTED DENSE 8" DEPTH. SEE GRADED CRUSHED 6" EXPANSION SLEEVE, WAXED TO NOTE NO. 3 STONE PREVENT BONDING- EXISTING AND - COMPACTED OR **NEW PAVEMENT** UNDISTURBED SUBGRADE

EXPANSION JOINT SPACING SHALL BE 30'-0" MAX.

- 2. 4" CONCRETE DEPTH SHALL BE USED FOR ALL PEDESTRIAN SIDEWALK APPLICATIONS UNLESS
- 3. USE 8" GRAVEL BORROW UNDER 4" CEM. CONC. WALK PVMT. USE 12" GRAVEL BORROW UNDER 6" CEM. CONC. PADS/SLABS.
- 4. DOWELS SHALL BE USED AT EXPANSION JOINTS AND WHERE NEW CONCRETE PAVEMENT ABUTS EXISTING CONCRETE PAVING TO REMAIN AND ANY PROPOSED CONCRETE RAMPS AND STAIRS.
- 5. FOR SIDEWALK PAVEMENT, USE BROOM FINISH PERPENDICULAR TO ROUTE OF TRAVEL.
- 6. ALL EXISTING AND PROPOSED STRUCTURES IN CONCRETE SHALL HAVE FULL ISOLATION JOINTS

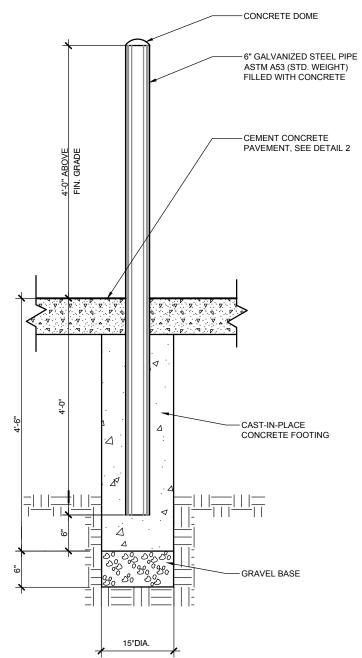

CEMENT CONCRETE PAVEMENT

SCALE: NTS

SLOTTED HOLE FOR — ANCHORS, TYP. MINIMUM COVERAGE — FOR FIXTURE FROM $-\frac{3}{4}$ " (1" MAX) CONDUIT FOR SHROUD COMMUNICATIONS INSTALLED DIRECTLY ADJACENT TO SHROUD — 6" CONCRETE ANCHOR, 24" O.C., TYP. PROPOSED 4" DEPTH ¹/₄" THICK STAINLESS STEEL C CHANNEL SHROUD (2" X 4" X 3.75") INTERIOR PAINTED BLACK. BOTTOM FACE SANDED OF ALL PROCESSING MARKS. — THROUGH BOLTS, TYP. 24" O.C. 3" WEEP HOLE AT INTERIOR BASE THROUGH BOTH C CHANNELS. AS CLOSE TO BOTTOM AS POSSIBLE. 2' O.C.

> NOTE: CHANNELS SHALL BE PROVIDED IN 10' SECTIONS, EXCEPT END SECTIONS WHICH SHALL BE 11' ADJACENT SECTIONS SHALL BE ATTACHED WITH 4" X 6" X $\frac{1}{8}$ " 316 SS PLATES AND SS HARDWARE. SECTIONS SHALL ALIGN VERTICALLY AND HORIZONTALLY.

SLOTTED HOLE FOR — - 1 THICK 2"×4" STAINLESS STEEL ANCHORS, TYP. MINIMUM COVERAGE -FOR FIXTURE FROM SHROUD $\frac{3}{4}$ " (1" MAX) CONDUIT FOR COMMUNICATIONS INSTALLED DIRECTLY ADJACENT TO SHROUD - 12" CONCRETE ANCHOR, TYP. PROPOSED 4" DEPTH ¹/₄" THICK STAINLESS STEEL C CHANNEL SHROUD (2" X 4" X 3.75") INTERIOR PAINTED BLACK. BOTTOM FACE SANDED OF ALL PROCESSING MARKS. — THROUGH BOLTS, TYP. 24" O.C. $-\frac{3}{16}$ WEEP HOLE AT INTERIOR BASE THROUGH BOTH C CHANNELS. AS CLOSE TO BOTTOM AS POSSIBLE. 2' O.C.

> ADJACENT SECTIONS SHALL BE ATTACHED WITH 4" X 6" X 1/8" 316 SS PLATES AND SS HARDWARE. SECTIONS SHALL ALIGN VERTICALLY AND HORIZONTALLY.


LED FIXTURE BRIDGING MOUNTING SHROUD

SCALE: NTS

LED FIXTURE MOUNTING SHROUD

SCALE: NTS

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Description
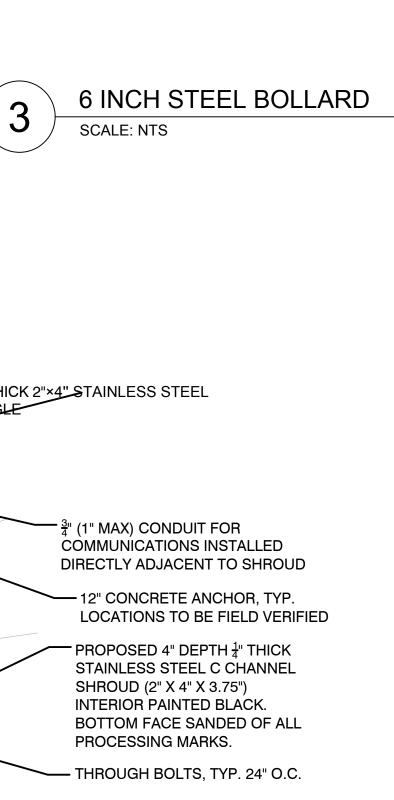
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W&S Project No.: ENG23-0722 W&S File No.:

Drawing Title:

CONSTRUCTION **DETAILS**

RACEWAY AND WIRING

CIRCUIT

CEILING

CLOSED CIRCUIT TELEVISION

DISCONNECT

DOWN

DAMPER

DISTRIBUTION

FIRE ALARM BOOSTER POWER

FIRE ALARM CONTROL PANEL

SUPPLY PANEL

FCU FAN COIL UNIT

HORIZ HORIZONTAL

HEIGHT

HPF

HORSEPOWER

HIGH POWER FACTOR

KW

LT

KII OWATT

LIGHT

KILOWATT HOUR

LOCATE OR LOCATION

DISC

DPR

HOMERUN TO PANELBOARD WITH 3/4"C., 2 #12 & 1#12GND UNLESS NOTED 1,3 LP1B OTHERWISE, NUMERALS 1 AND 3 INDICATE CIRCUITS IN PANELBOARD. RACEWAYS LARGER THAN 3/4" AND CONDUCTORS LARGER THAN #12 AWG SHALL BE INDICATED ON THE DRAWINGS. PROVIDE AN INSULATED GREEN GROUND WIRE IN ALL RACEWAYS MINIMUM SIZE TO BE #12AWG.

RACEWAY RUN UNDERGROUND OR CONCEALED IN SLAB

CCTV

CKT

CLG

ARCH ARCHITECT, ARCHITECTURAL COMB COMBINATION

RACEWAY RUN EXPOSED

LIGHTING LEGEND

BRIDGE LIGHTING FIXTURE

(MOUNT 4'-0" AFF UNLESS NOTED OTHERWISE

SINGLE POLE SWITCH

POWER LEGEND

HANDHOLE

ANNUN ANNUNCIATOR

AQ-STAT AQUASTAT

APPROX APPROXIMATELY

JUNCTION BOX WITH BLANK COVERPLATE, SIZE AS REQUIRED BY N.E.C.

RECEPTACLE LEGEND

DUPLEX GROUND FAULT CIRCUIT INTERRUPTER CONVENIENCE OUTLET - 20A, 125V, U-SLOT GROUNDED TYPE MOUNTED 18" ABOVE FINISHED FLOOR TO CENTER LINE. ALL OTHER MOUNTING HEIGHTS SHALL BE AS NOTED ADJACENT TO THE SYMBOL.

ONE LINE DIAGRAM LEGEND

CIRCUIT BREAKER; TEXT DENOTES CIRCUIT BREAKER AMPACITY RATING AND POLE NUMBER - 40 AMPS, 2 POLE

DEMOLITION NOTES

MISCELLANEOUS

MAIN LUGS ONLY

MOA MULTIOUTLET ASSEMBLY

MANUAL MOTOR STARTER

MMS

NTS

OHD

OL

NOT TO SCALE

OVERHEAD DOOR

OVERHEAD

OVERLOADS

- SYSTEMS WHICH PASS THROUGH THE AREA BEING DEMOLISHED BUT CONTINUE TO AREAS NOT WITHIN THE DEMOLITION SCOPE ARE TO REMAIN. THE ELECTRICAL CONTRACTOR IS TO IDENTIFY (SPRAY PAINT OR EQUIVALENT) AND PROTECT THOSE SYSTEMS WHICH ARE ACTIVE
- ALL CONDUIT AND WIRE WHICH IS NO LONGER IN USE IS TO BE REMOVED. CONDUIT AND WIRE IS TO BE REMOVED BACK TO ITS SOURCE OR NEAREST DEVICE WHICH IS SCHEDULED TO REMAIN. UNDER NO CIRCUMSTANCES ARE ABANDONED CONDUIT AND WIRE OR SYSTEM COMPONENTS TO REMAIN.
- MAKE ANY NECESSARY RE-CIRCUITING, EXTENSIONS OF EXISTING CIRCUITS AND RELOCATIONS REQUIRED TO PROPERLY RE-ENERGIZE REMAINING EXISTING SERVICES OR EQUIPMENT THAT MAY BE INTERFERED WITH BY NEW CONSTRUCTION, REMOVALS OR RELOCATIONS. ALL SHUTDOWNS TO RELOCATE ACTIVE FEEDERS OR BRANCH CIRCUITS WILL BE PERFORMED ON OFF HOURS AS MUTUALLY AGREED TO WITH THE OWNER.
- PRIOR TO REMOVAL OF EQUIPMENT, CONFIRM THAT FEEDER AND BRANCH CIRCUITS ARE NO LONGER ACTIVE. SHOULD IT BE DISCOVERED THE FEEDER OR BRANCH CIRCUITS ARE ACTIVE, NOTIFY THE ARCHITECT IMMEDIATELY FOR DIRECTION.
- ELECTRICAL CONTRACTOR IS TO REMOVE ALL LAMPS, BALLASTS AND OTHER ELECTRICAL COMPONENTS CLASSIFIED AS HAZARDOUS MATERIALS. ELECTRICAL CONTRACTOR IS TO OBTAIN THE SERVICES OF A LICENSED HAZARDOUS MATERIALS CONTRACTOR TO DISPOSE OF THE MATERIALS. PROVIDE WRITTEN DOCUMENTATION TO THE OWNER'S REPRESENTATIVE FROM THE HAZARDOUS MATERIALS CONTRACTOR.
- 6. ELECTRICAL DEMOLITION ABBREVIATIONS:

"XM" DENOTES EXISTING EQUIPMENT TO REMAIN

"RL" DENOTES EXISTING EQUIPMENT TO BE DISCONNECTED AND RELOCATED. ALL EXISTING CONDUIT AND WIRE SHALL BE REMOVED BACK TO ITS SOURCE AND ALL DEVICES ASSOCIATED WITH THE EQUIPMNET SHALL BE REMOVED OR ALL CONDUIT AND WIRE SHALL BE INTERCEPTED AND EXTENDED AS REQUIRED. ALL NEW CONDUIT AND WIRE SHALL MATCH EXISTING IN STYLE AND SIZE. ALL EXISTING ELECTRICAL DEVICES ASSOCIATED WITH THE EXISTIGN EQUIPMENT SHALL BE REMOVED AND NEW DEVICES AS SHOWN SHALL BE PROVIDED.

"NL" DENOTES NEW LOCATION OF RELOCATED EXISTING EQUIPMENT.

"RE" DENOTES EXISTING EQUIPMENT TO BE DISCONNECTED AND REMOVED ALL EXISTING CONDUIT AND WIRE SHALL BE REMOVED BACK TO ITS SOURCE AND ALL DEVICES ASSOCIATED WITH THE EQUIPMENT SHALL BE REMOVED.

GENERAL ELECTRICAL NOTES

UTIL

UNIT HEATER

UTILITY

UNDERGROUND TELEPHONE

DRAWINGS ARE DIAGRAMMATIC ONLY. THE EXACT LOCATION, MOUNTING HEIGHTS, SIZE OF EQUIPMENT AND ROUTING OF RACEWAYS SHALL BE COORDINATED AND DETERMINED IN THE FIELD.

STD

STANDARD

SWBD SWITCHBOARD

SW SWITCH

SURFACE MOUNTED

QUAN QUANTITY

RCPT RECEPTACLE

REQD REQUIRED

RM ROOM

- 2. ALL STRAIGHT FEEDER, BRANCH CIRCUIT AND AUXILIARY SYSTEM CONDUIT RUNS SHALL BE PROVIDED WITH SUFFICIENT PULL BOXES TO LIMIT THE MAXIMUM LENGTH OF ANY SINGLE CABLE PULL TO 150 FEET. EXACT SIZES OF PULL BOXES AND LOCATIONS TO BE DETERMINED IN THE FIELD BY THE ELECTRICAL CONTRACTOR.
- THE ELECTRICAL CONTRACTOR SHALL COORDINATE WITH THE GENERAL CONTRACTOR AS APPLICABLE AS TO THE EXACT LOCATION OF THEIR RESPECTIVE EQUIPMENT; THE POWER WIRING, CONTROL WIRING AND ALL ELECTRICAL CONNECTIONS AND CONDUIT TURN-UPS SHALL BE COORDINATED WITH THE RESPECTIVE CONTRACTORS BEFORE THE START OF CONSTRUCTION IN THE FIELD.
- SLEEVES ARE TO BE UTILIZED FOR PASSAGE OF CONDUITS THROUGH FLOORS OR WALLS. CONDUITS AND BOXES ARE TO BE SUPPORTED BY THE USE OF PRESET FASTENERS INSTALLED IN FLOORS, WALLS OR COLUMNS. CONDUITS AND BOXES ARE TO BE INSTALLED CONCEALED IN MASONRY WALLS AND ABOVE HUNG CEILINGS. ALL SLEEVES ARE TO BE SEALED WITH APPROVED FIRE STOPPING SEALANT.
- 5. COMBINED HOMERUNS OF TWO (2) OR THREE (3) CIRCUITS MAY BE UTILIZED. HOWEVER, THE NEUTRAL CONDUCTOR IS TO BE INCREASED TO #10AWG. COMBINED HOMERUNS ARE TO BE LIMITED TO 20A, LIGHTING AND POWER CIRCUITS.
- WORK SHALL CONFORM TO THE NATIONAL ELECTRICAL CODE WITH MASSACHUSETTS ELECTRICAL AMENDMENTS, MASSACHUSETTS BUILDING CODE, NFPA AND REQUIREMENTS OF LOCAL AUTHORITIES HAVING JURISDICTION.
- 7. THE WORD "CONTRACTOR" AS USED IN THE "ELECTRICAL WORK" SHALL MEAN THE ELECTRICAL SUBCONTRACTOR.
- 8. CONTRACTOR SHALL PAY FOR ALL PERMITS, INSURANCE AND TESTS, AND SHALL
- PROVIDE LABOR AND MATERIAL TO COMPLETE THE ELECTRICAL WORK SHOWN.
- 9. OWNER SHALL PAY ELECTRIC UTILITY COMPANY BACKCHARGES.
- 10. CONTRACTOR SHALL PROVIDE ALL REQUIRED COORDINATION WITH ELECTRIC, UTILITY.
- 11. ELECTRIC UTILITY WORK ORDER NUMBER FOR THIS PROJECT IS #XXXXXXXXXX.
- 12. EXCEPT AS OTHERWISE NOTED, THE ELECTRICAL WORK SHALL INCLUDE DEMOLITION, PANELBOARDS, CIRCUIT BREAKERS, FEEDERS, WIRING, RACEWAYS, LIGHTING FIXTURES, AND DEVICES.
- 13. THE CONTRACTOR SHALL PROVIDE ALL TEMPORARY LIGHTING AND POWER AND THE GENERAL CONTRACTOR SHALL PAY ALL ENERGY CHARGES FOR TEMPORARY POWER AND LIGHTING.
- 14. DURING CONSTRUCTION, THE ELECTRICAL CONTRACTOR SHALL KEEP HIS PORTION OF THE WORK NEAT, CLEAN AND ORDERLY.
- 15. ALL SYSTEMS SHALL BE TESTED FOR SHORT CIRCUIT AND GROUNDS PRIOR TO ENERGIZING AND ANY DEFECTS SHALL BE CORRECTED.
- 16. ALL CUTTING AND PATCHING REQUIRED FOR ELECTRICAL WORK SHALL BE INCLUDED AS PART OF THIS SECTION.
- 17. COMPLETE SHOP DRAWINGS SHALL BE SUBMITTED FOR ELECTRICAL EQUIPMENT. WHERE SPECIFIED ELECTRICAL EQUIPMENT IS SUBSTITUTED, THE ELECTRICAL CONTRACTOR SHALL SUBMIT COMPLETE SPECIFICATIONS ON THE SUBSTITUTE AS WELL AS THE ITEM ORIGINALLY SPECIFIED.
- 18. MATERIALS SHALL BE SPECIFICATION GRADE AND UL LISTED.

- CATALOG NUMBER, SUCH DESIGNATIONS ARE TO ESTABLISH STANDARDS OR DESIRED QUALITY. ACCEPTANCE OR REJECTIONS OF PROPOSED SUBSTITUTIONS SHALL BE SUBJECT TO THE APPROVAL OF THE OWNER.
- 20. WORK SHALL BE COORDINATED WITH THAT OF OTHER TRADES TO ELIMINATE
- 21. ELECTRICAL WORK SHALL BE GUARANTEED FOR A PERIOD OF ONE YEAR FROM DATE OF FINAL COMPLETION.
- 22. WORK SHALL BE GROUNDED IN ACCORDANCE WITH CODE REQUIREMENTS. COMPLETE EQUIPMENT (INSULATED GREEN WIRE) GROUNDING SYSTEM SHALL BE INSTALLED.
- 23. WIRING METHODS:
- B. EXTERIOR ABOVE GRADE FEEDERS SHALL BE RGS CONDUIT.
- E. EMERGENCY, CRITICAL AND LIFE/SAFETY BRANCH LIGHTING CIRCUITRY SHALL BE
- 24. NO CONDUIT OR WIRE SHALL BE RUN IN OR BELOW SLAB WITHOUT ENGINEER

- 28. IN AREAS NOT AFFECTED BY THIS RENOVATION, THIS SUBCONTRACTOR SHALL
- 29. ELECTRICAL SHUTDOWN SHALL BE AT A TIME AND DATE APPROVED BY THE OWNER.
- 30. PROVIDE AS-BUILT "CADD" DRAWINGS AT THE COMPLETION OF THE PROJECT.
- 31. ELECTRICAL CONTRACTOR SHALL LABEL ALL ELECTRICAL DEVICES INCLUDING BUT NOT LIMITED TO RECEPTACLES, PANELBOARDS, DISCONNECTS, ENCLOSED CIRCUIT
- A. RECEPTACLES PANEL NAME AND CIRCUIT DESIGNATION B. PANELBOARDS - PANEL NAME, VOLTAGE, AMPERAGE, PHASE AS WELL AS PANEL
- C. DISCONNECTS PANEL NAME, CIRCUIT DESIGNATION AND EQUIPMENT SERVING. D. ENCLOSED CIRCUIT BREAKERS - PANEL NAME, CIRCUIT DESIGNATION AND
- E. CONTROL PANEL PANEL NAME AND CIRCUIT DESIGNATION
- F. JUNCTION BOXES PANEL NAME AND CIRCUIT DESIGNATION
- 32. ADDRESS QUESTIONS TO THE ENGINEER IN WRITING BEFORE AWARD OF CONTRACT, OTHERWISE ENGINEER INTERPERTATION OF MEANING AND INTENT OF DRAWINGS SHALL BE FINAL.

- 19. WHERE MATERIAL IS CALLED OUT IN THE LEGEND BY MANUFACTURER, TYPE OR

- A. EXTERIOR UNDERGROUND FEEDERS SHALL BE PVC SCHEDULE 80 FOR DIRECT
- BURIED AND PVC SCHEDULE 40 FOR CONCRETE ENCASED.
- C. INTERIOR FEEDERS EXPOSED SHALL BE RGS CONDUIT. D. LIGHTING FIXTURE CONNECTIONS SHALL BE MC CABLE.
- APPROVAL OR NOTED OTHERWISE ON THE PLANS.
- 25. CONDUIT AND TUBING SHALL BE SUPPORTED ON GALVANIZED WALL BRACKETS. TRAPEZE HANGERS OR PIPE STRAPS SECURED BY MEANS OF TOGGLE BOLTS OR INSERTS IN WOOD CONSTRUCTION.
- 26. FEEDER TAPS WILL NOT BE ALLOWED IN PANELBOARD GUTTERS.
- 27. CONTRACTOR SHALL CHECK EXISTING CONDITIONS TO DETERMINE EXACT EXTENT OF WORK TO BE PERFORMED PRIOR TO BIDDING. DIMENSIONS RELEVANT TO EXISTING WORK SHALL BE VERIFIED IN THE FIELD.
- MAINTAIN CONTINUITY OF ELECTRIC SERVICE.

- BREAKERS, CONTROL PANELS, JUNCTION BOXES, ETC.
- AND CIRCUIT IT IS FED FROM.
- EQUIPMENT SERVING.

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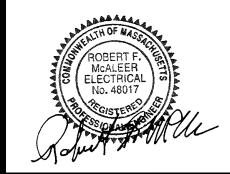
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Consultants:

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W&S File No .:

ELECTRICAL LEGEND, ABBREVIATIONS, DETAILS, AND **GENERAL NOTES**

Sheet Number:

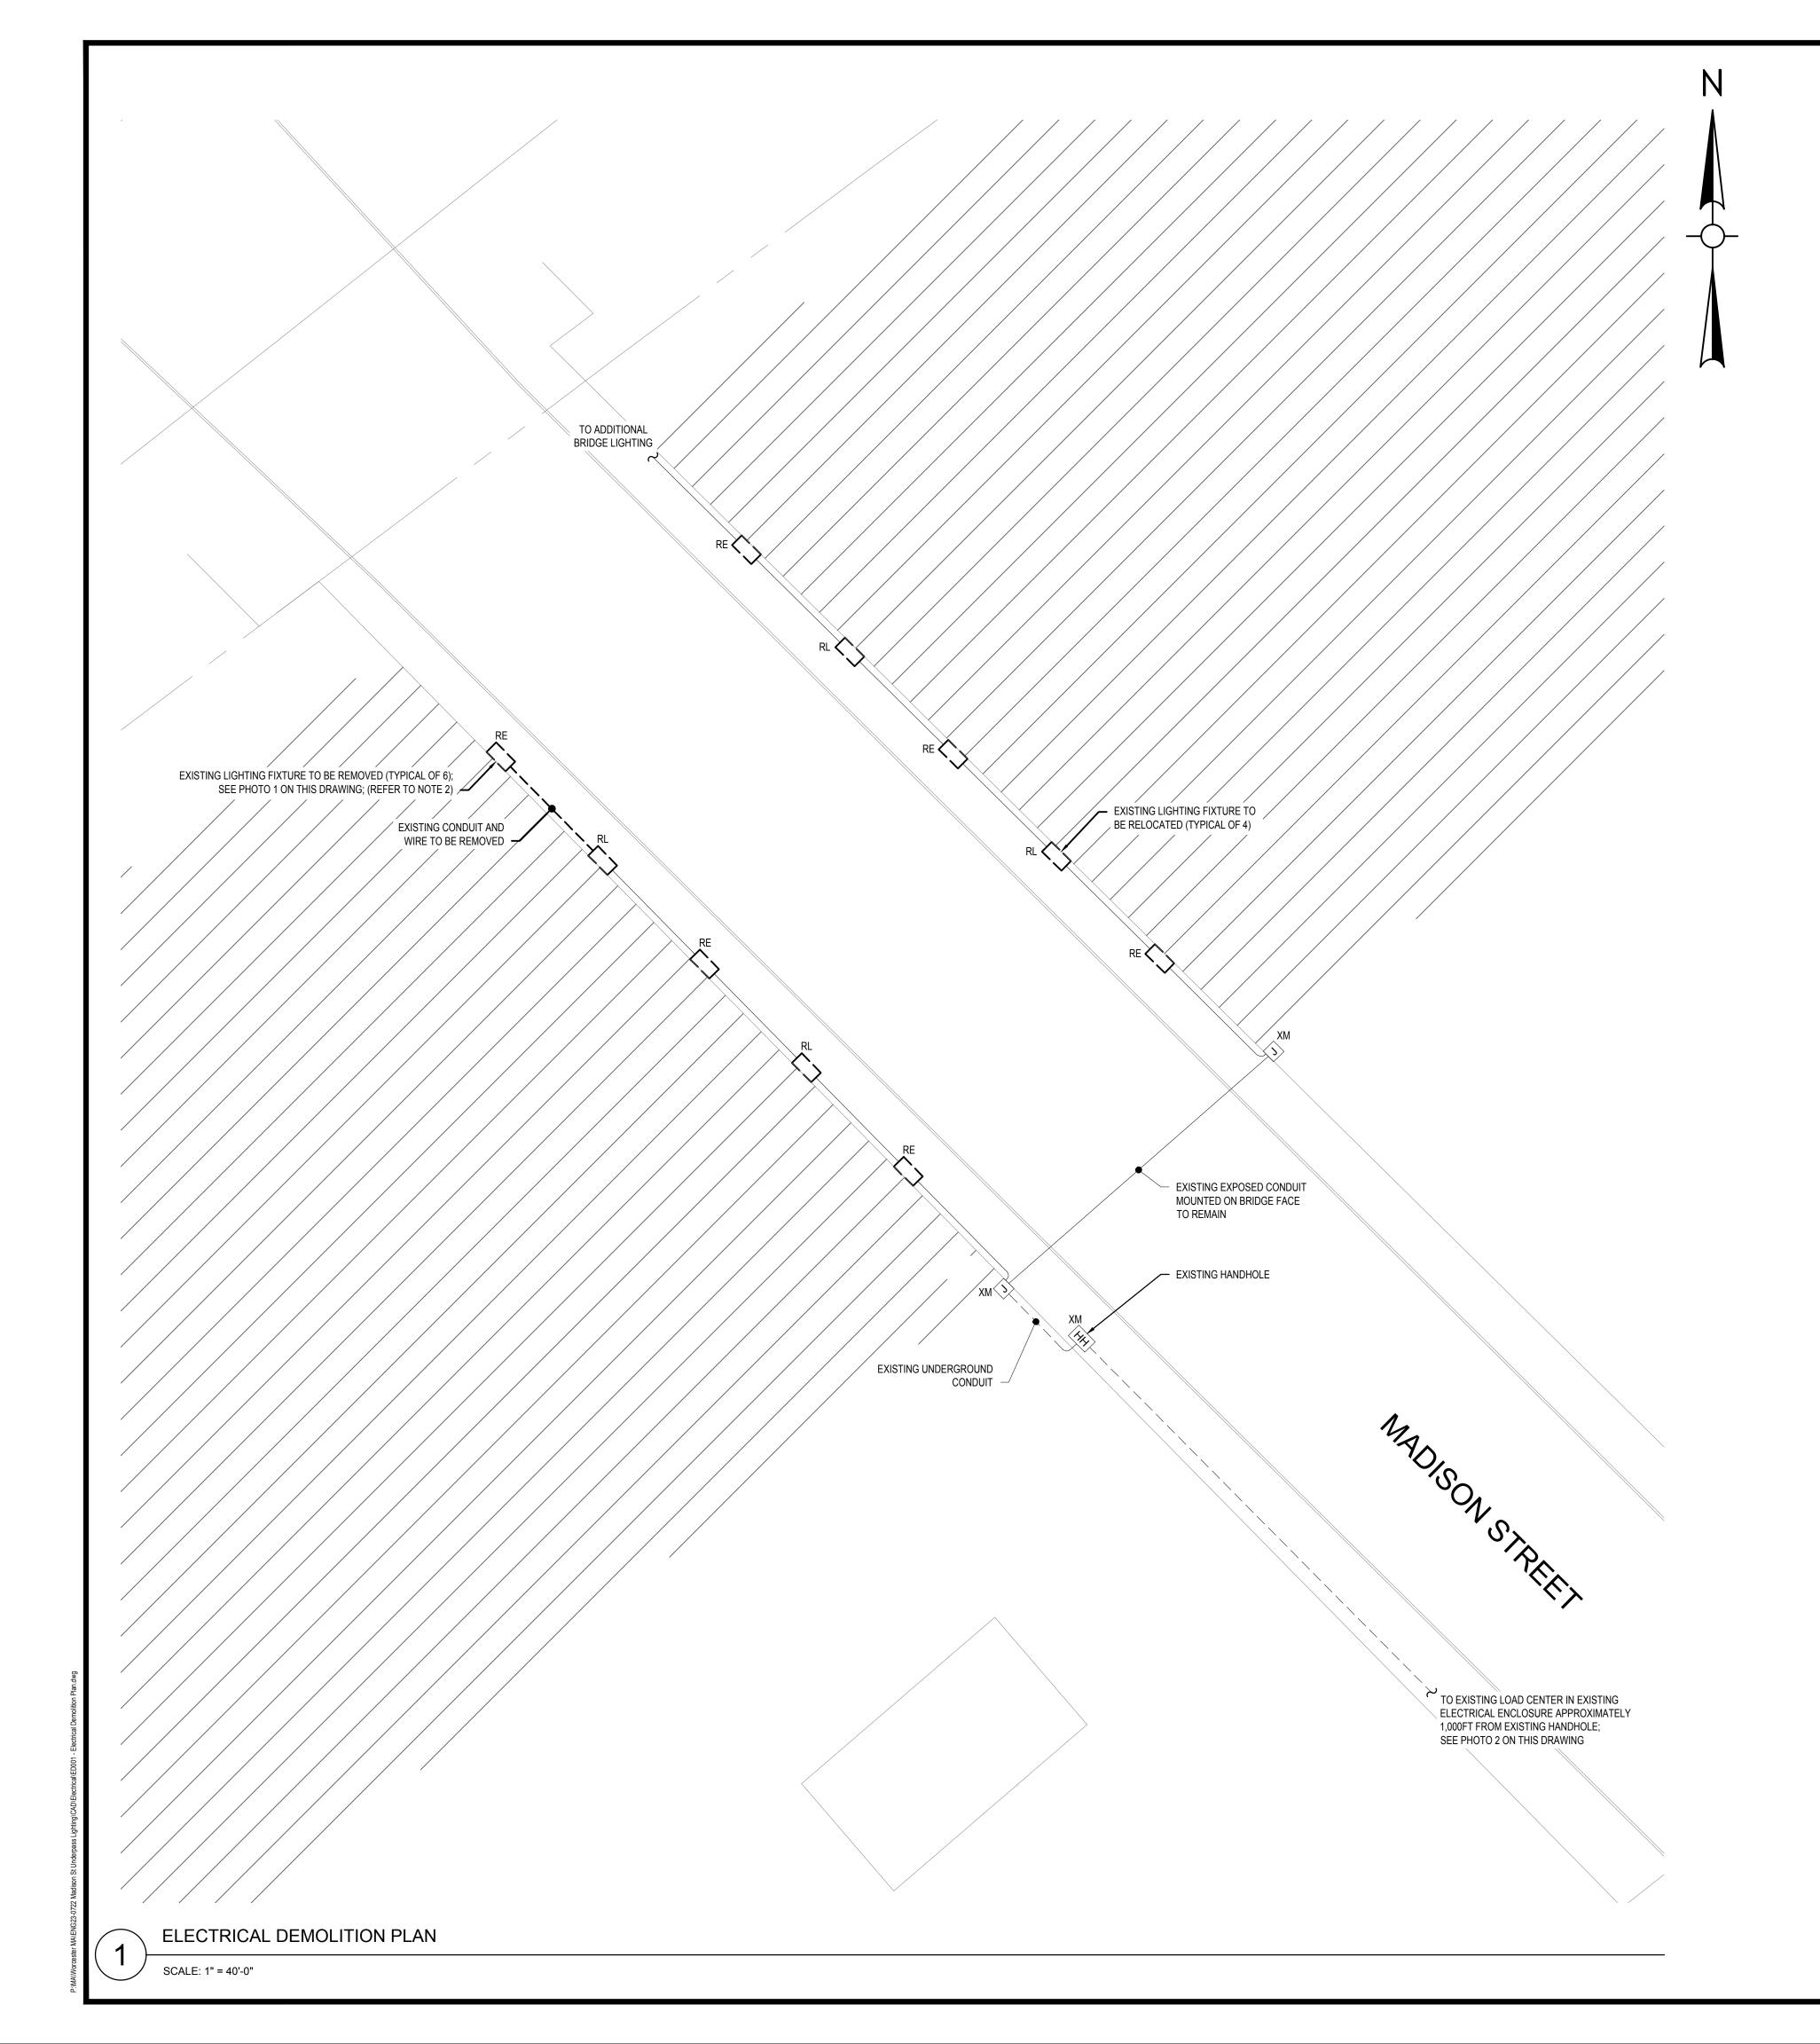




PHOTO 1: EXISTING UNDERPASS LIGHTING FIXTURE

NOT TO SCALE

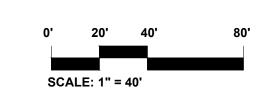



PHOTO 2: EXISTING LOAD CENTER IN EXISTING ELECTRICAL ENCLOSURE

NOT TO SCALE

<u>DRAWING NOTES:</u> 1. REFER TO DRAWING E001 FOR LEGEND, ABBREVIATIONS, AND GENERAL NOTES.

- 2. ALL EXISTING CONDUIT AND WIRE TO REMAIN UNLESS NOTED OTHERWISE.
- 3. NO DEMOLITION OF EXISTING LIGHTING FIXTURES IS TO TAKE PLACE UNTIL ALL NEW LED LIGHTING FIXTURES ARE INSTALLED AND OPERATIONAL. FOLLOWING INSTALLATION OF THE NEW LIGHTING, EXISTING LIGHTING FIXTURES AND CIMCOM UNITS AS INDICATED SHALL BE DISCONNECTED, PROTECTED, AND DELIVERED TO THE OWNER AT THE DPW FACILITY ON MILLBURY STREET.



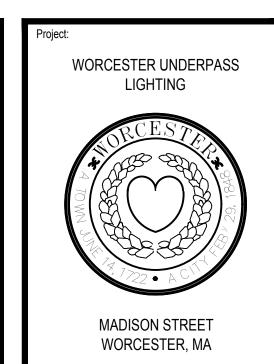

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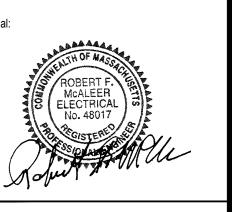
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Date: 09/ 26/ 23

Drawn By: DCH

Reviewed By: DNM

Approved By: RFM


W&S Project No.: ENG23-0722 W&S File No.:

Drawing Title:


ELECTRICAL DEMOLITION SITE PLAN

Sheet Number:

ED001

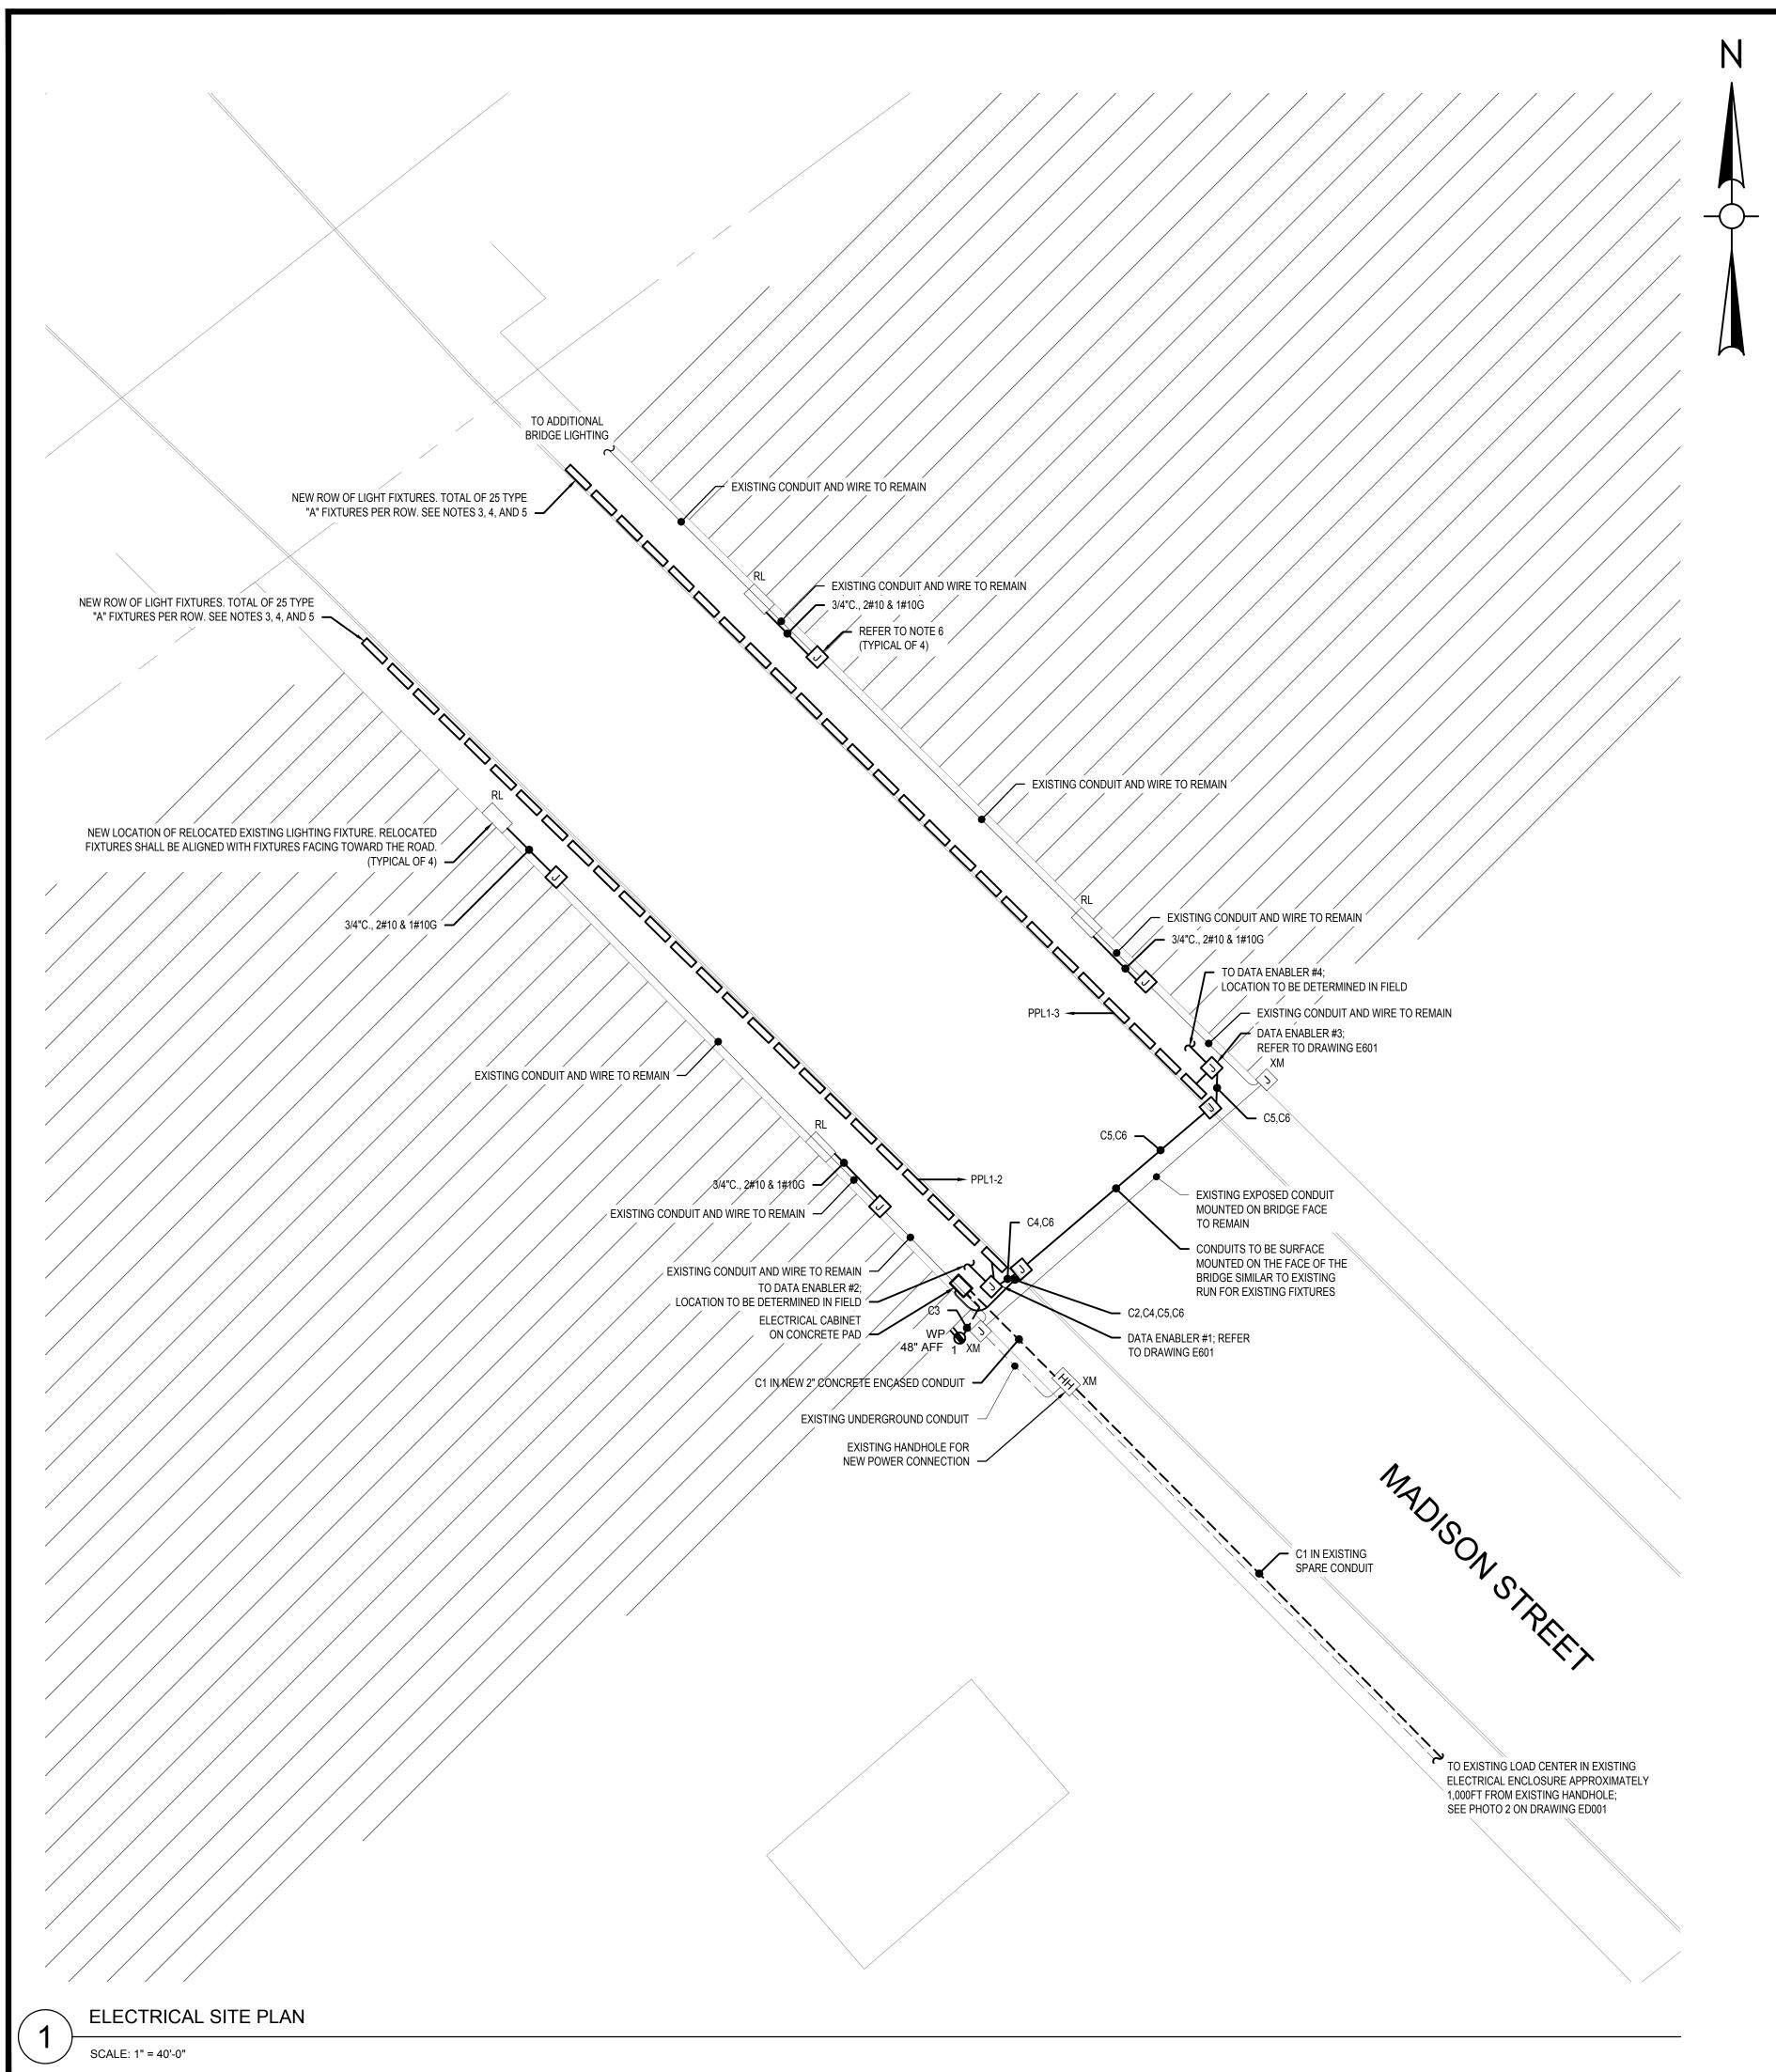

	CONDUIT AND WIRE SCHEDULE											
CONDUIT TAG	FEEDER	FROM	ТО	CONTACT	NO. OF FIXTURES	LOAD	CONTACT SIZE	REMARKS				
C1	2"C., 3#4 & 1#8GND	EXISTING LOAD CENTER VIA EXISTING HANDHOLE	PPL1	-	-	1	1	CONCRETE ENCASED				
C2	3/4"C., EMPTY CONDUIT WITH PULL STRINGS	ELECTRICAL CABINET	BRIDGE FACE	-	-	1	1	CONCRETE ENCASED				
С3	3/4"C., 2#10 & #10GND	PPL1-1	BRIDGE RECEPTACLE	-	1	1.5 A	1	SURFACE MOUNTED				
C4	3/4"C., 2#10 & #10GND	PPL1-2	UNDERPASS LIGHTS	-	25	7.1 A	1	SURFACE MOUNTED				
C5	3/4"C., 2#10 & #10GND	PPL1-3	UNDERPASS LIGHTS	-	25	7.1 A	-	SURFACE MOUNTED				
C6	3/4"C., WITH CAT6 CABLE	ELECTRICAL CABINET	CONTROLLER AT FIXTURE	-	-	-	-	SURFACE MOUNTED				

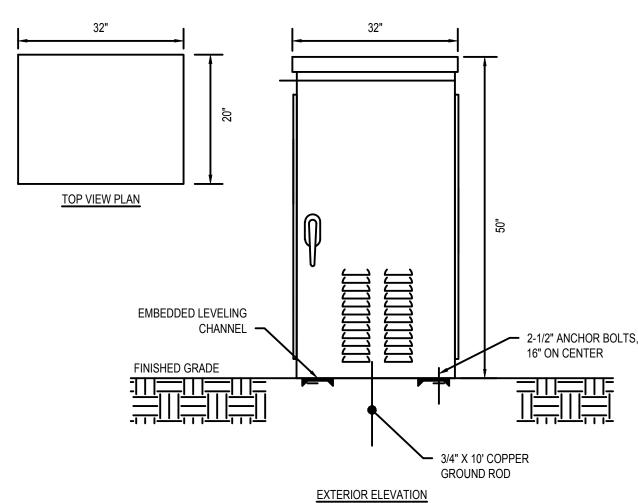


- 1. CONTRACTOR SHALL COORDINATE WITH THE EXACT CABINET SIZE WITH ALL MANUFACTURER EQUIPMENT SIZES PRIOR TO SUBMITTING THE CABINET FOR APPROVAL. PROVIDE A SCALED DRAWING SHOWING ALL EQUIPMENT.
- 2. ALL ELECTRICAL EQUIPMENT WITHIN THE CABINET SHALL BE MOUONTED TOWARDS THE FRONT OF THE CABINET.



ELECTRICAL ENCLOSURE DETAIL


NOT TO SCALE

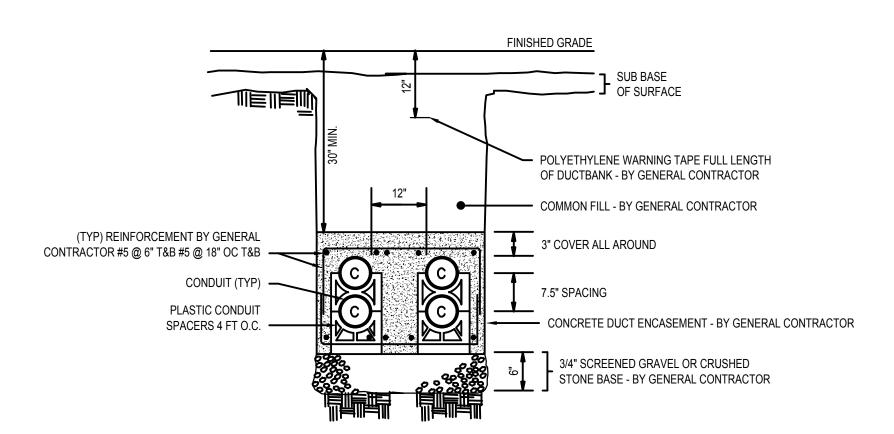


TYPICAL 1x1 WITH COMMUNICATIONS CONCRETE ENCASED DUCTBANK DETAIL NOT TO SCALE

- <u>DRAWING NOTES:</u>

 1. REFER TO DRAWING E001 FOR LEGEND, ABBREVIATIONS, AND GENERAL NOTES.
- 2. REFER TO DRAWING E601 FOR PANELBOARD SCHEDULE.
- 3. CONTRACTOR TO COORDINATE QUANTITIES, OVERALL RUN LENGTHS, ORIENTATION, MOUNTING LOCATIONS, AND MOUNTING DETAILS PER ARCHITECTURAL DRAWINGS.
- 4. FINAL LIGHT FIXTURE AND DATA ENABLER PRO LOCATIONS TO BE CONFIRMED WITH ARCHITECTS BASED ON SITE CONDITIONS.
- 5. CONTRACTOR TO COORDINATE AND PROVIDE ALL JUMPER CABLES AND LEADER CABLES AS REQUIRED FOR A COMPLETE AND OPERATIONAL SYSTEM INSTALLATION.
- 6. CONTRACTOR SHALL INTERCEPT EXISTING CONDUIT AND WIRE AT JUNCTION BOX AND EXTEND TO NEW LOCATION OF RELOCATED LIGHTING FIXTURE.
 - SCALE: 1" = 40'

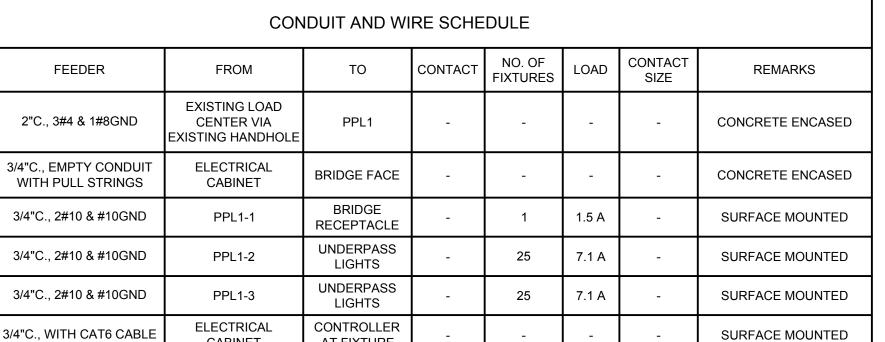

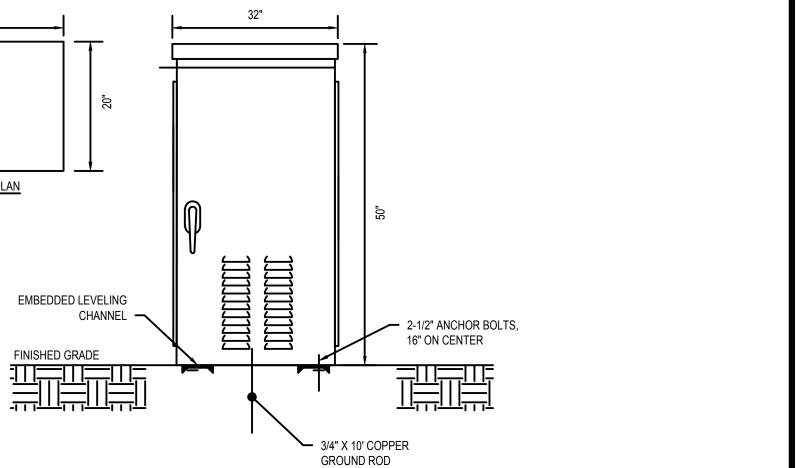

Description

WORCESTER UNDERPASS LIGHTING

> MADISON STREET WORCESTER, MA

Weston & Sampson Engineers, Inc. 427 Main Street, Suite 400

Worcester, MA 01608

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800.SAMPSON

978.532.1900

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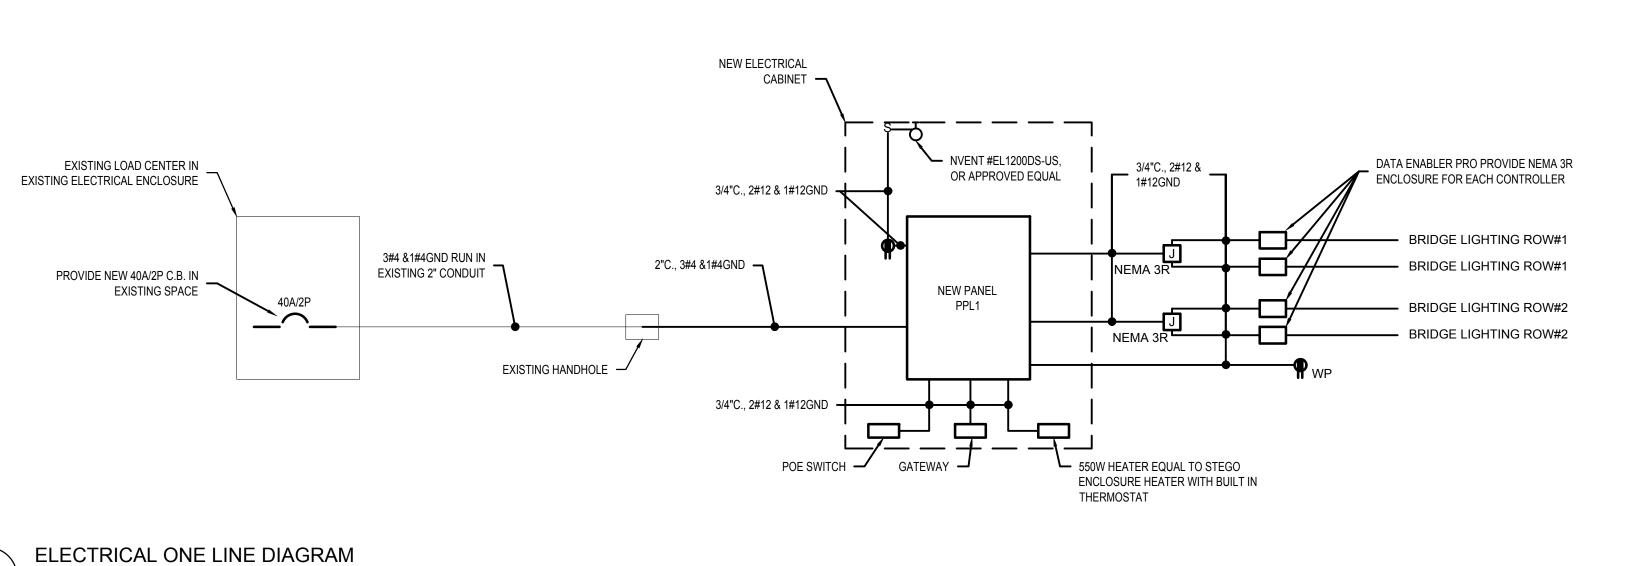
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W&S Project No.: ENG23-0722 W&S File No.:

Drawing Title: ELECTRICAL SITE

Sheet Number:



NOT TO SCALE

PANELBOARD SCHEDULE S.C. RATING: 14,000A RMS SYSTEM DESIGNATION: PPL1 REMARKS: LOCATION: ELECTRICAL CABINET SERVICE: 120/240V, 1Ø, 3W RATING: 100 AMPS MOUNTING: SURFACE MAIN: 40A MCB LOAD DESIGNATION CIRCUIT LOAD CIRCUIT DESIGNATION BREAKER A B BREAKER 1 BRIDGE RECEPTACLE 20 BRIDGE LIGHTS 20 GATEWAY 3 BRIDGE LIGHTS 20 CABINET HEATER 5 CABINET LIGHT AND RECEPTACLE 20 20 7 SPARE 20 POE SWITCH 0.06 20 9 SPARE 20 SPARE 20 SUB-TOTAL 1.77 1.09 2.86 KVA TOTAL 2.58 KVA ESTIMATED DEMAD LOAD 10.75 AMPS TOTAL DEMAND CURRENT

DRAWING NOTES:

AND MOUNTING DETAILS PER ARCH. DWGS.

CARNEVALE, DCARNEVALE@APEXLTG.COM

A COMPLETE AND OPERATIONAL SYSTEM INSTALLATION.

1. REFER TO DRAWING E001 FOR LEGEND, ABBREVIATIONS, GENERAL NOTES AND DEMO NOTES.

2. CONTRACTOR TO COORDINATE QUANTITIES, OVERALL RUN LENGTHS, ORIENTATION, MOUNTING LOCATIONS,

3. FINAL LIGHT FIXTURE AND DATA ENABLER PRO LOCATIONS TO BE CONFIRMED WITH ARCHITECTS BASED ON

4. CONTRACTOR TO COORDINATE AND PROVIDE ALL JUMPER CABLES AND LEADER CABLES AS REQUIRED FOR

5. FOR ANY ADDITIONAL QUESTIONS REGARDING THE COLOR KINETICS PRODUCTS, PLEASE CONTACT DAN

MADISON STREET WORCESTER, MA

WORCESTER UNDERPASS

Weston & Sampson

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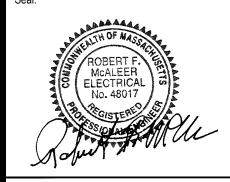
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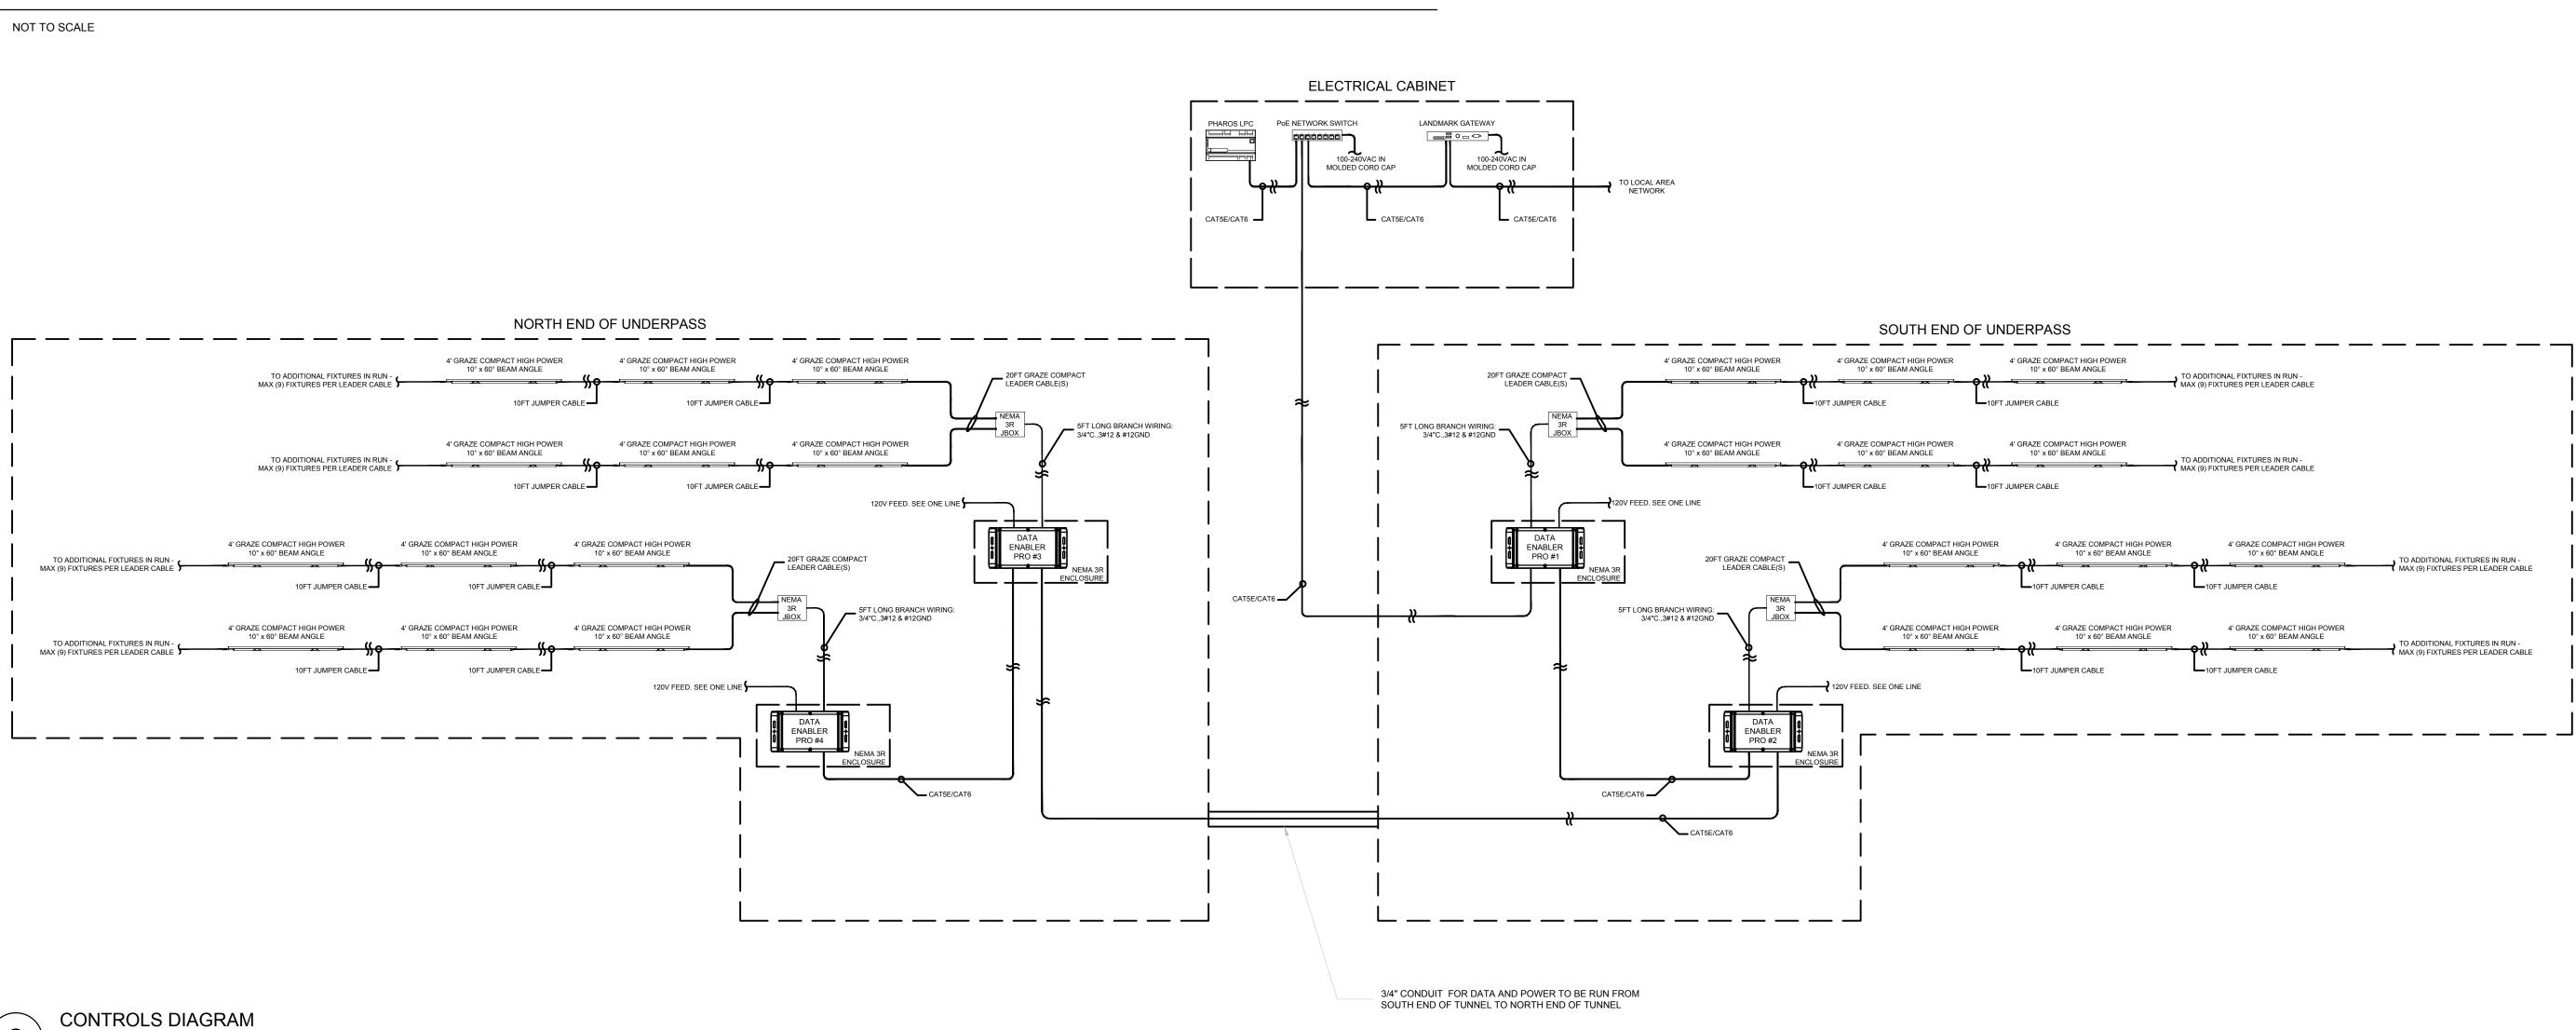
W&S Project No.: ENG23-0722 W&S File No.:

Drawing Title:

ELECTRICAL SCHEDULES AND DIAGRAMS

Sheet Number:

E601



CONTROL DEVICES SCHEDULE

EQUIPMENT

20 FT GRAZE COMPACT LEADER CABLE

DATA ENABLER PRO

10FT JUMPER CABLE

POE NETWORK SWITCH

PLC

GATEWAY

MANUFACTURER

COLOR KINETICS

COLOR KINETICS

COLOR KINETICS

COLOR KINETICS

INTERACT LANDMARK

PHAROS

CATALOG NUMBER

106-000004-00

108-000074-02

108-000073-04

PHAROS PLC

120-000084-01

LANDMARK GATEWAY