

June 1, 2023

To All Bidders:

Subject: Bid No. 8022-W3, Temporary Chiller Installation – WPD HQ / DPF

ADDENDUM NO. 2

To Whom It May Concern:

With reference to our bid request relative to the above subject, please refer to the changes/modifications/clarifications to the original proposal request.

- PLEASE FIND ATTACHED UPDATED DRAWINGS
- THE BID SET SPECIFICATIONS POSTED ON THE BIDS PAGE HAVE BEEN DELETED.
 - O ALL OTHER BID DOCUMENTS ARE IN ORDER

Bidders are requested to acknowledge and/or include this addendum with submission. All other terms, conditions and specifications remain unchanged.


Very truly yours,

Christopher J. Gagliastro Purchasing Director

WORCESTER POLICE HEADQUARTERS

TEMP. CHILLER REPLACEMENT

9-11 LINCOLN SQUARE WORCESTER, MA 01608

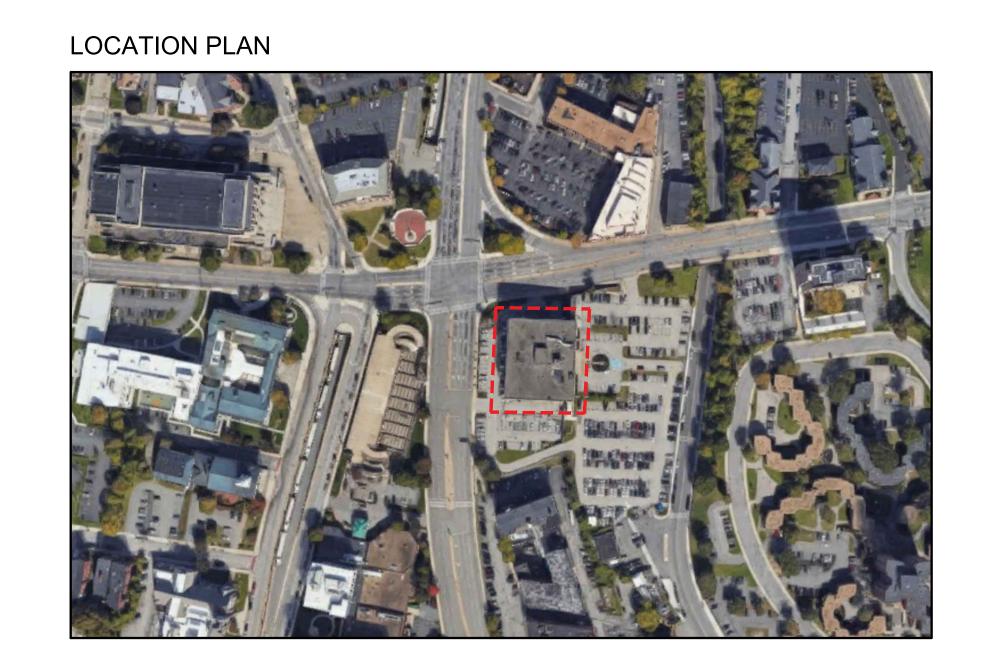

OWNER

CITY OF WORCESTER

WORCESTER, MA

455 Main Street, Worcester, MA 01608

ARCHITECT



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1 Cranberry Hill, Suite 301
Lexington, MA 02421
(617) 926-6100

ELECTRICAL ENGINEER
SHEPHERD ENGINEERING, INC.
1308 Grafton Street
Worcester, MA 01604
(508) 757-7793

MECHANICAL, PLUBMING & FIRE PROTECTION
SEAMAN ENGINEERING CORP.
22 West Street, Unit C
Millbury, MA 01527
(508) 865-1400

SYMBOLS:

	ACOUSTICAL TILE		FACE BRICK		ROUGH LUMBER
	ALUMINUM	/1/	GLASS (ELEVATION INDICATION)		SHEET METAL (ELEVATION INDICATION)
	BRASS / BRONZE		GLAZED BRICK		SHINGLE / SIDING (ELEVATION INDICATION)
	BRICK (ELEVATION INDICATION)		GYPSUM BOARD GYPSUM LATH, MASONITE &		STEEL /OTHER METALS
<i>\\\\\\\\\\\\\\\\\\\\\\\\\\\\\\\\\\\\\</i>	CARPET & PAD		INSULATION (BATT / LOOSE FILL)		STRUCTURAL GLAZED TILE
	CERAMIC TILE		MASONRY BLOCK	M	WOOD STUD PARTITION
	CERAMIC TILE (ELEVATION INDICATION)		METAL LATH & PLASTER		HARDWOOD
· · · · · · · · · · · · · · · · · · ·	CONCRETE		METAL STUD PARTITION		MEDIUM DENSITY FIBERBOARD
	CONCRETE / PLASTER (ELEVATION INDICATION)		NEW CONC SLAB PATCH		PLYWOOD
	EARTH / COMPACT FILL		PLASTIC		RIGID INSULATION

ABBREVIATIONS:

ACOUST.	ACOUSTICAL	CONTR. CORR.	CONTRACTOR	FLUOR.	FLUORESCENT
A.D.	AREA DRAIN		CORRIDOR	F.P.	FIRE PROOFING
ADJ.	ADJUSTABLE	C.R.	COLD ROLLED	F.S.	FIRE SHIELD
AFF	ABOVE FINISHED FLOOR	CRS.	COURSES	F.SZ.	FULL SIZE
ALU.	ALUMINUM	CSK.	COUNTERSINK	FT.	FEET/FOOT
ALUM.	ALUMINUM	CTOP	COUNTERTOP	FT.2	SQUARE FEET
ANCH.	ANCHOR	CU.	CUBIC	FT.3	CUBIC FEET
APPROX.	APPROXIMATELY	C.U.H.	CABINET UNIT HEATER	F.O.	FRAMED OPENING
@	AT	D.A.	DOUBLE ACTING	FUR.	FURRING
		D.A.F.S.	DIRECT APPLIED FINISH	GA.	GAUGE
BD.	BOARD		SYSTEM	GALV.	GALVANIZED
BKSP.	BACKSPALSH	DET.	DETAIL	G.C.	GENERAL CONTRACTOR
BKT.	BRACKET	D.F.	DRINKING FOUNTAIN	GL.	GLASS
BLDG.	BUILDING	DN.	DOWN	GR.	GRADE
BLK.	BLOCK	DO.	DITTO (REPEAT)	G.S.U.	GLAZED STRUCTURAL UNIT
BLKG.	BLOCKING	D.O.	DOOR OPENING	GYP.	GYPSUM
BM.	BEAM	DSP.	DISPENSER	G.W.B.	GYPSUM WALLBOARD
BOT.	BOTTOM OF BEAM	D.W.	DRY WALL	0.77.0.	OTT GOIN WINEEDOING
B.O.B.	BOTTOM OF BEAM	DWG.	DRAWING	H.C.	HANDICAP
B.O.P. B.O.D.	BOTTOM OF PIPES BOTTOM OF DUCT			H.C.P.	HANDICAP
D.O.D.	BOTTOWIOF DOCT	EA.	EACH	H.C.P.	HANDICAP
		ED.	EDUCATION	HD	HIGH DENSITY
		EDSP.	ENDSPLASH	HDWR.	HARDWARE
CG	CORNER GUARD	E.J.	EXPANSION JOINT	H.M.	HOLLOW METAL
CAB.	CABINET	EL.	ELEVATION (GRADE)	HORIZ.	HORIZONTAL
C.B.	CHALK BOARD	ELEC.	ELECTRICAL	HR.	HOUR
CEM.	CEMENT	ELEV.	ELEVATION (FACADE)	HT.	HEIGHT
CER./C.T.	CERAMIC TILE	ELEV.	ELEVATOR	HVAC	HEATING, VENTILATING
C.G.	CORNER GUARD	EQ.	EQUAL		& AIR CONDITIONING
C.I.	CAST IRON	E.S.	EACH SIDE		
C.I.P.	CAST IN PLACE	E.T.R.	EXISTING TO REMAIN	I.D.	INSIDE DIAMETER
C.J.	CONTROL JOINT	EXH.	EXHAUST	IN.	INCH, INCHES
CLG.	CEILING	EXIST.	EXITING	IN.2	SQUARE INCHES
CLKG.	CHALKING	EXP. JT.	EXPANSION JOINT	IN.3	CUBIC INCHES
CLR.	CLEAR	EXP.	EXPOSED	INCAN.	INCANDESCENT
CLOS.	CLOSET	EXT.	EXTERIOR	INFIL.	INFILTRATION
C.M.U.	CONC. MASONRY UNIT	EXTIN.	EXTINGUISHER	INSUL.	INSULATION
C.O.	CLEAR OPENING	F.C.P.	FIBER CEMENT PANEL	INT.	INTERIOR
COL.	COLUMN	F.D.C.	FIRE DEPT. CONNECTION	INV.	INVERT
CONC.	CONCRETE	F.D.V.	FIRE DEPT. VALVE	IOT	IOIOT
C.H.P.	CONC. HOUSEKEEPING PAD	F.D.V.C.	FIRE DEPT. VALVE CABINET	JST.	JOIST
COND.	CONDITION	FB.	FLAT BAR	JT.	JOINT
CONST.	CONSTRUCTION	F.C.	FIRE CODE		
CONT.	CONTINUOUS	F.D.	FLOOR DRAIN	1 A B A	LANAINIATED
		F.E.	FIRE EXTINGUISHER	LAM.	LAMINATED
		F.E.C.	FIRE EXTINGUISHER	LB./#	POUND
			CABINET	L.C.	LEAD COATED LAMINATED DRYWALL PART.
		F.F.	FACTORY FINISH	L.D.P. LGTH.	LENGTH
		F.H.	FI AT HEAD	LGIH.	

FLAT HEAD

FIN.

FIRE HOSE CABINET

L.G.M.F.

L.P.

LI.WT.

LVR.

LIGHT GAGE METAL FRAMING

LIMIT OF WORK

LIGHT WEIGHT

LOW POINT

LOUVER

_ CENTER LINE OF COLUMN GRIDS SHEET WHERE ELEVATION IS $\langle X.XX \rangle$ CENTER LINE OF COLUMN GRIDS WALL SECTION: SECTION IDENTIFICATION HR SEPARATION WALL **BUILDING SECTION** SECTION IDENTIFICATION SHEET WHERE SECTION IS DRAWN ROOM IDENTIFICATION: DETAIL IDENTIFICATION ROOM NAME $\stackrel{\frown}{\mathsf{X}}$ Cut on one sheet, XX - SHOWN ON ANOTHER **EXISITNG VERTICAL ELEVATION:** FLOOR/LEVEL IDENTIFICATION FLOOR/LEVEL IDENTIFICATION ELEVATION IDENTIFICATION **ELEVATION IDENTIFICATION** VIDE, WIDE FLANGE

METAL DOOR
MANUFACTURER

MISCELLANEOUS MOLDING

MASONRY OPENING

METAL THRESHOLD

MISC. METAL CONTRAC

NONCORROSIVE NOT IN CONTRACT

ON CENTER

OUTSIDE DIAMETEI
OPPOSITE HAND

PERPENDICULAR (TO)
PLASTIC LAMINATE

PLATE

PLYWOOD

PAINTED

QUANTITY

RISER

ROOF DRAIN

REINFORCING

REFRIGERATOR

PRESSURE TREATED

RADIATOR ENCLOSURE

PTD.

QTY.

REFIG.

MINIMUM

MOUNTED

METAL

	REQD. RESIL. RET. RM. R.O. R.W.L. RB.	REQUIRED RESILIENT RETAINING ROOM ROUGH OPENING RAIN WATER LEADER RESILIENT BASE	W. W/ W.C. WD. W.D. W.I. WIND. W.O.	WIDE, WIDE FLANGE WITH WATER CLOSET WOOD WINDOW DIMENSION WROUGHT IRON WINDOW WINDOW WINDOW OPENING
	SCHED. SECT. SH. SHT. S.I.G.S.	SCHEDULE SECTION SHELVES SHEET SILICON IMPREGNATED GYPSUM SHEATHING	W.D. WT. W.W.M. X YD. Z	WATERPROOFING WEIGHT WELDED WIRE MESH INDICATES TIMES OR BY YARD ZEE (STRUCTURAL SHAPE)
CTOR	SIM. SLID. SPEC. SQ. STOR.	SIMILAR SLIDING SPECIFICATIONS SQUARE STORAGE		
	S.T. S.S. STD. STL. STRUCT. SUSP.	STRUCTURAL TUBE STAINLESS STEEL STANDARD STEEL STRUCTURAL SUSPENDED		
	T. TBLE. T.B. T.C. TEL. TERR. T&G THK. THRESH. TLT. T.O.B. T.O.C. T.O.S. T.W. TYP. TWR.	TREADS TABLE TACK BOARD TERRA COTTA TELEPHONE TERRAZZO TONGUE & GROOVE THICKNESS THRESHOLD TOILET TOP OF BLOCKING TOP OF CONCRETE TOP OF STEEL TOP OF WALL TYPICAL TOWER		

UNDERWRITERS LABORATORY

UNLESS OTHERWISE NOTED

UNIT VENTILATOR

VINYL WALL COVERING

VENTILATOR

VERTICAL

VESTIBULE

U.O.N.

U.P.R.

U.V.

VENT.

VEST.

DRAWING LIST:

ARCHITECTURAL

00 COVER SHEE

A2.01 ROOF PLAN, ROOF DETAIL & CONTRACTOR STAGING / LIFT AREA

STRUCTURA

S1.01 GENERAL NOTES, PART. PLAN, NOTES & DETAILS

MECHANIC

H-1 DEMO & PROPOSED 3RD FLOOR PLANS, SCHEDULES & DETAILS

H-2 DEMO & PROPOSED ROOF HVAC PLANS

ELECTRICAL

E1.1 THIRD FLOOR PLAN -POWER
E2.1 ROOF PLAN -POWER

LEGENDS AND SCHEDULES

PROJECT NAME/LOCATION

WORCESTER
POLICE
HEADQUARTERS
TEMP. CHILLER
REPLACEMENT

BID SET

9-11 LINCOLN SQUARE WORCESTER, MA 01608

DRAWING TITLE

DRAWING TITLE



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DRAWING INFORMATION

SCALE AS INDICATED

DRAWN BY H.C.


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MAY 24, 2023

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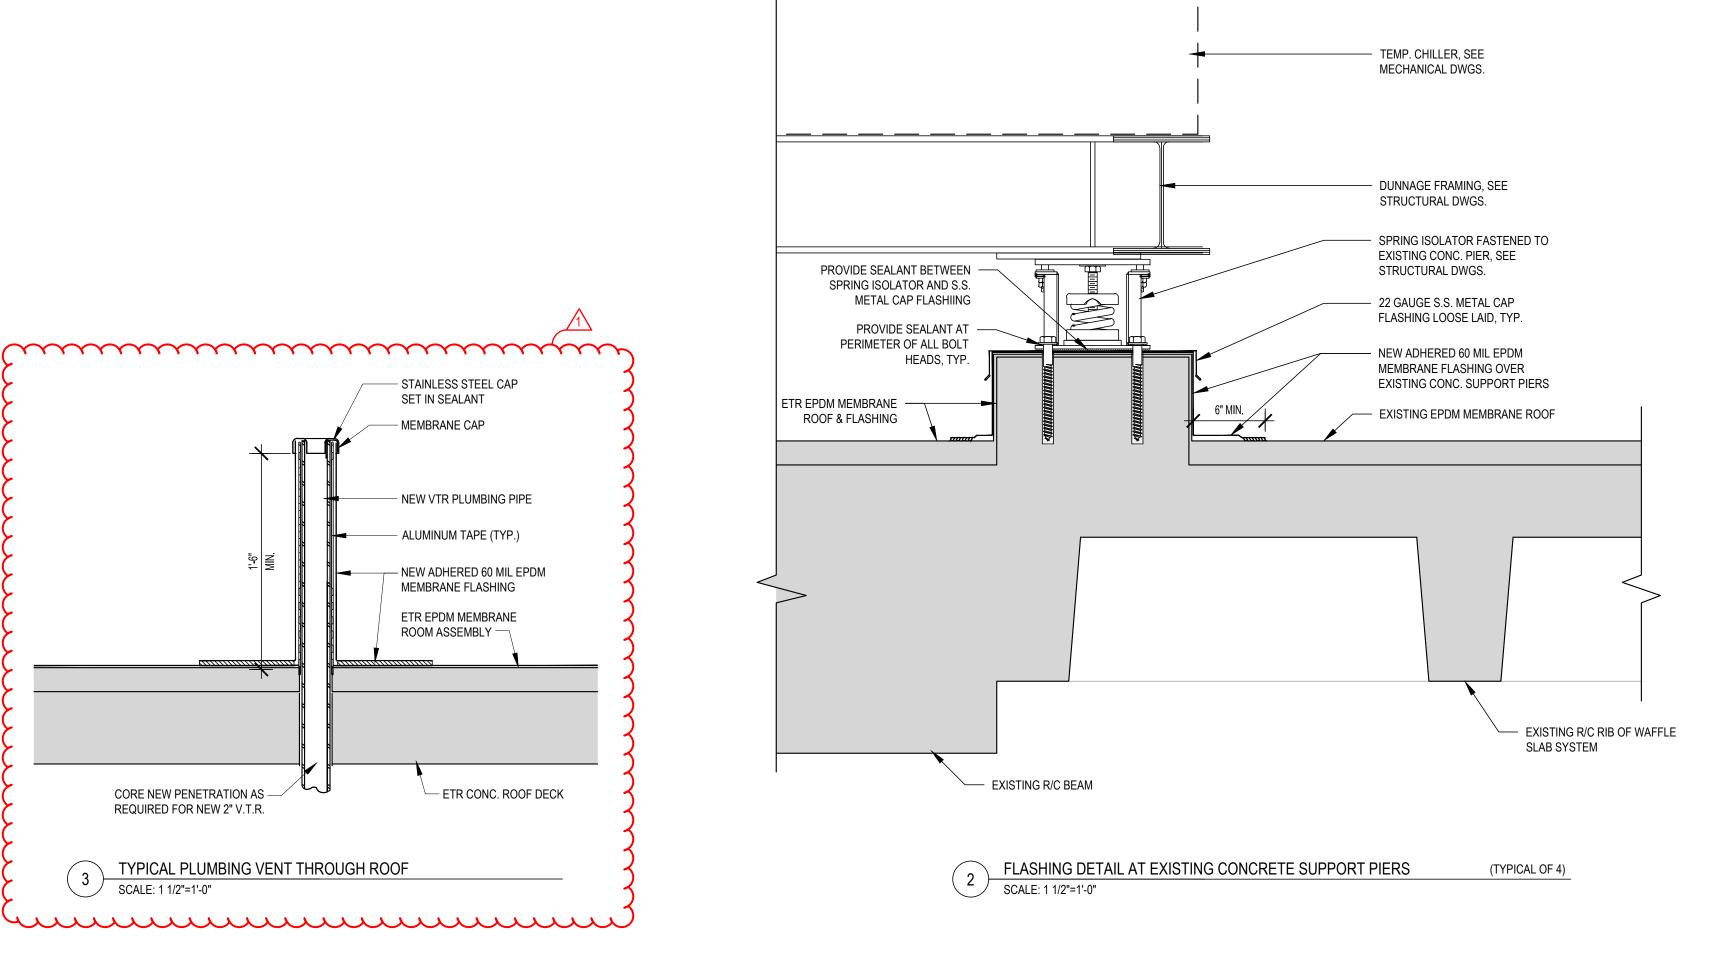
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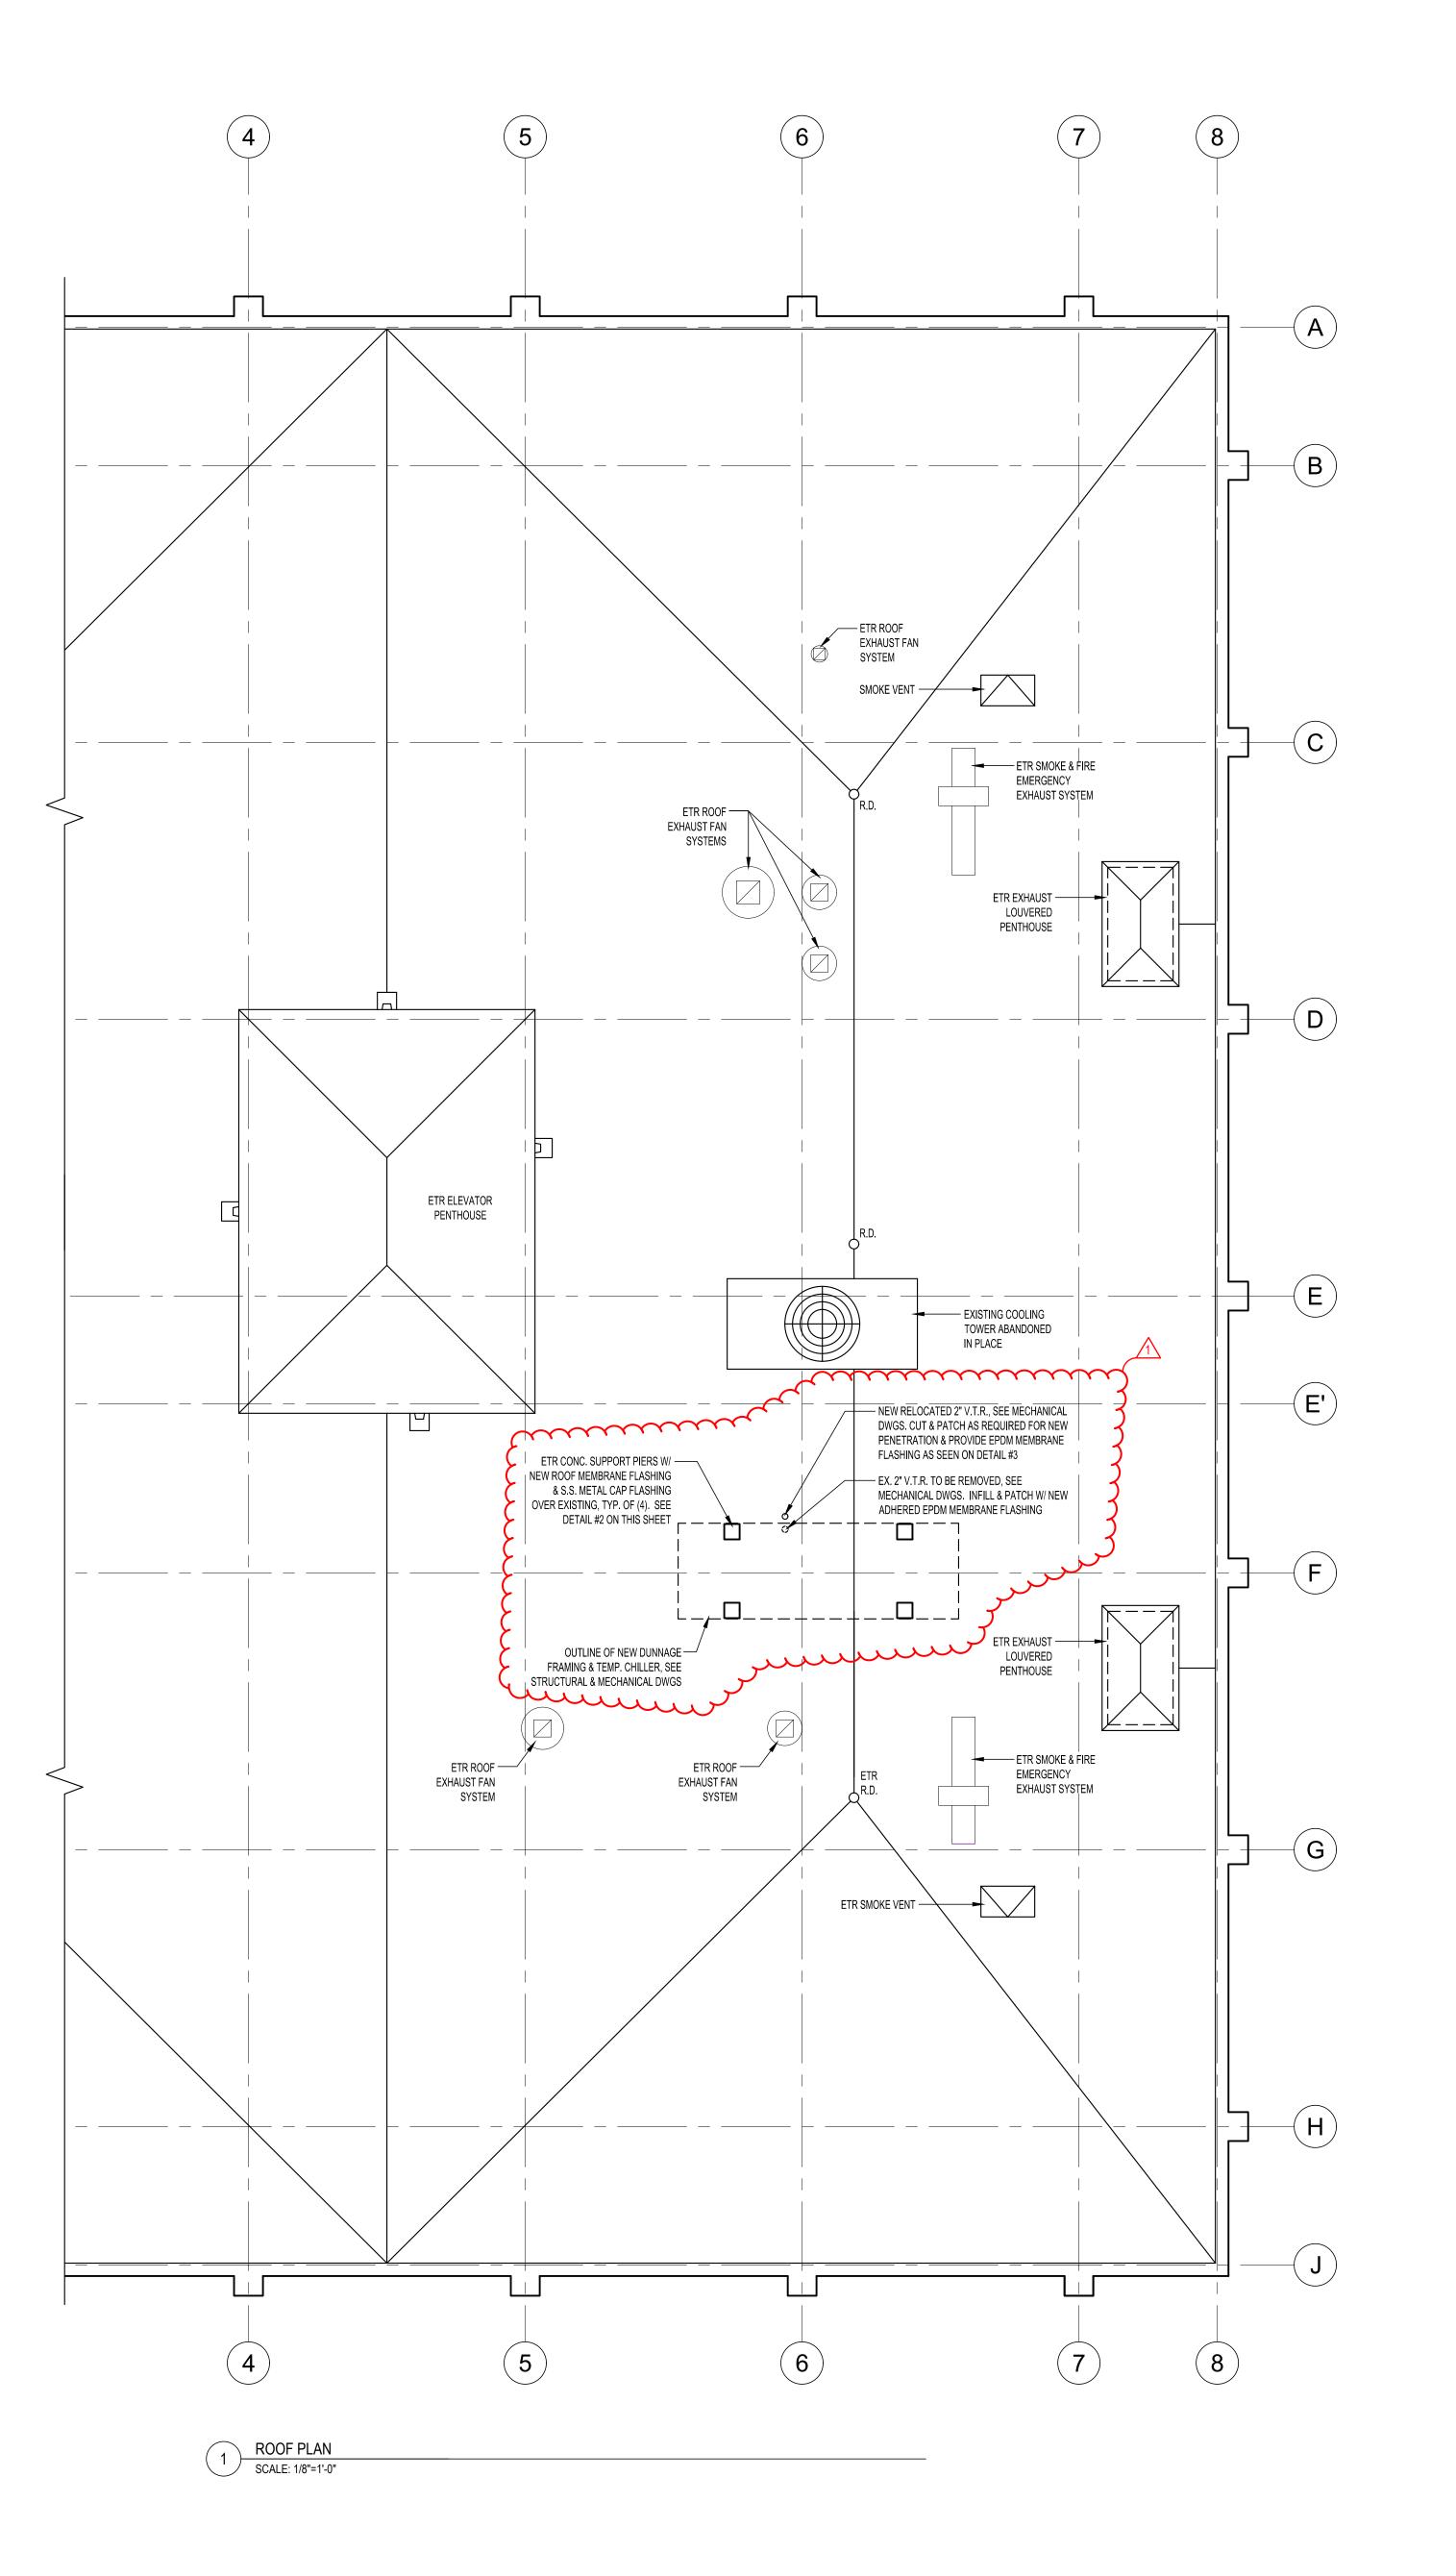
BID SET MAY 24, 2023



- MAIN BUILDING ENTRANCE



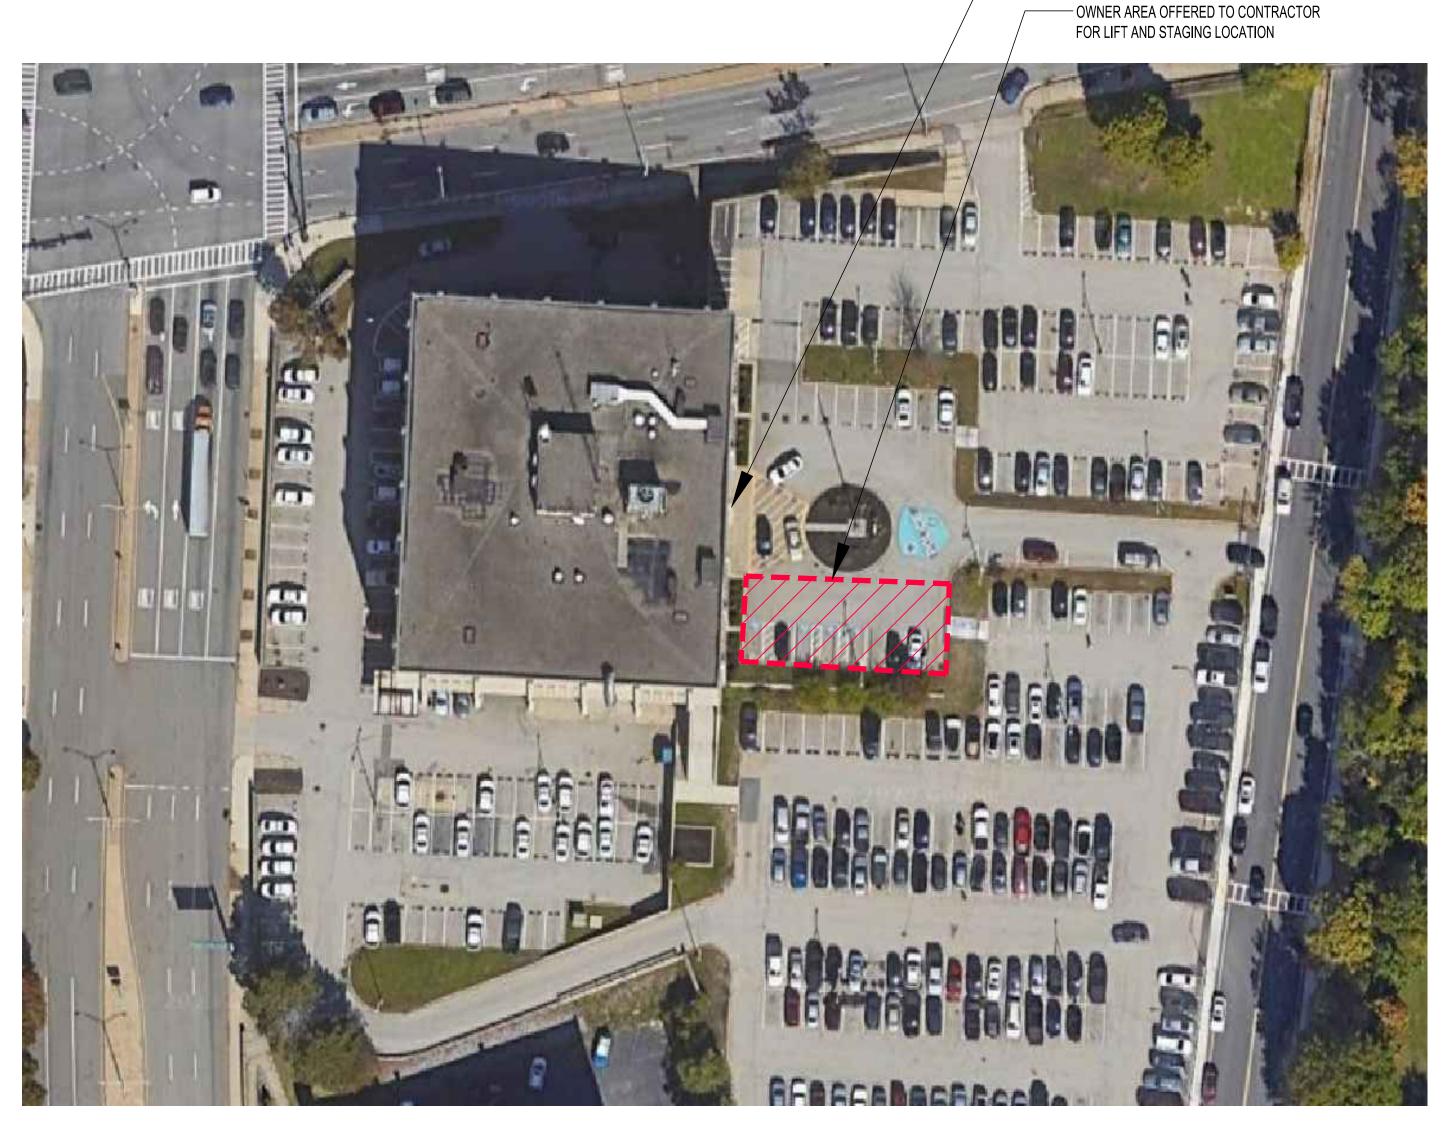



NORTH ARROW

CONSULTANTS

PROJECT PHASE

PROJECT NUMBER

BID SET

PROJECT NAME/LOCATION

WORCESTER

POLICE

02023.03

POLICE
HEADQUARTERS
TEMP. CHILLER
REPLACEMENT

9-11 LINCOLN SQUARE WORCESTER, MA 01608

DRAWING TITLE

ROOF PLAN, ROOF DETAIL & CONTRACTOR STAGING/ LIFT AREA PARAMETERS



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DATE MAY 24, 2023

DRAWING NUMBER

A2.01

GENERAL NOTES

GENERAL:

- 1. STRUCTURAL DRAWINGS SHALL BE USED IN CONJUNCTION WITH EQUIPMENT VENDOR DRAWINGS, ALONG WITH EXISTING FIELD CONDITIONS.
- SHOP DRAWINGS FOR STRUCTURAL STEEL SHALL BE SUBMITTED TO THE STRUCTURAL ENGINEER AND A STAMPED ACCEPTANCE RECEIVED BEFORE FABRICATION CAN PROCEED. ERECTION SHALL BE EXECUTED FROM ACCEPTED SHOP DRAWINGS ONLY.
- 3. ALL WORK SHALL CONFORM TO THE REQUIREMENTS OF THE LATEST EDITIONS (UNLESS OTHERWISE NOTED) OF THE FOLLOWING BUILDING CODES AND STANDARDS:
- a. THE COMMONWEALTH OF MASSACHUSETTS STATE BUILDING CODE, 9TH EDITION
- b. THE INTERNATIONAL BUILDING CODE, 2015 EDITION c. THE INTERNATIONAL EXISTING BUILDING CODE, 2015 EDITION
- d. ACI 530 "BUILDING CODE REQUIREMENTS FOR MASONRY STRUCTURES"

EXISTING CONSTRUCTION:


- 1. ALL INFORMATION RELATING TO THE EXISTING STRUCTURAL CONDITIONS HAS BEEN DERIVED FROM EXISTING STRUCTURAL DRAWINGS.
- 2. THE CONTRACTOR SHALL VERIFY ALL EXISTING CONDITIONS, DIMENSIONS AND MEMBER SIZES AS INDICATED ON THE DRAWINGS, IN THE FIELD. ANY DISCREPANCIES SHALL BE BROUGHT TO THE ATTENTION OF THE STRUCTURAL ENGINEER BEFORE PROCEEDING WITH THE AFFECTED PORTION OF THE WORK.
- 3. THE CONTRACTOR SHALL BE RESPONSIBLE FOR THE DESIGN AND EXECUTION OF ALL TEMPORARY BRACING AND SHORING METHODS, AS REQUIRED, TO PREVENT DANGER TO PERSONS AND PROPERTY.
- 4. ANY DIMENSION NOTED (±) ON PLAN SHALL BE COORDINATED AND VERIFIED BY THE CONTRACTOR, IN THE FIELD, PRIOR TO THE SUBMISSION OF STRUCTURAL STEEL SHOP DRAWINGS.

(2015 INTERNATIONAL BUILDING CODE WITH MA BUILDING CODE SUPPLEMENT, 9TH ED.)

- 1. BUILDING ROOF LOADS (PER SECTIONS 1606 THRU 1608) A. GROUND SNOW LOAD, Pg = 50 PSF (PER SECTION 1608)
- FLAT-ROOF SNOW LOAD, Pf = 42 PSF (MIN.)
- PLUS SNOWDRIFT LOADING WHERE APPLICABLE • SNOW EXPOSURE FACTOR, Ce = 1.0

5 PSF

- SNOW LOAD IMPORTANCE FACTOR, Is = 1.2 • THERMAL FACTOR, Ct = 1.0
- B. ROOFING AND INSULATION:
- C. SERVICES:
- D. CEILINGS (WHERE THEY OCCUR) 3 PSF E. STRUCTURE: ACTUAL WEIGHTS OF MATERIALS
- 2. BUILDING SECOND FLOOR LOADS (PER SECTIONS 1606 & 1607)
- A. LIVE LOAD: 50 PSF 3 PSF B. CEILING:
- 7 PSF C. SERVICES: D. PARTITIONS:
- E. STRUCTURE: ACTUAL WEIGHTS OF MATERIALS 3. WIND DESIGN (PER SECTION 1609 AND IEBC 2015)
- A. ULTIMATE DESIGN WIND SPEED, Vult (3-SECOND GUST) = 134 MPH
- B. NOMINAL DESIGN WIND SPEED, Vasd = 104 MPH C. RISK CATEGORY = 4

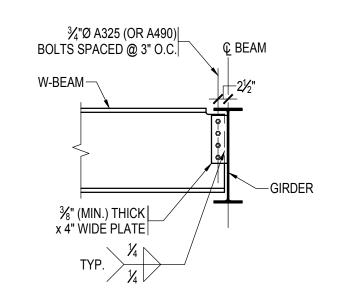

MINIMUM SHEAR CONNECTION REQUIREMENTS (ASD LOADS)					
BEAM DEPTH	MINIMUM SHEAR CAPACITY (KIPS)	MINIMUM NUMBER OF ROWS OF BOLTS	BOLT HOLE TYPE		
W10s AND LESS	16.5	2	STANDARD OR SHORT-SLOTTED		
W12s AND W14s	28.8	3	STANDARD OR SHORT-SLOTTED		
W16s AND W18s	41.5	4	STANDARD OR SHORT-SLOTTED		

- 1. SIMILAR AT BEAM TO COLUMN CONNECTIONS.
- 2. THE STEEL FABRICATOR SHALL DESIGN ALL CONNECTIONS FOR SHEAR REACTIONS GIVEN ON PLANS OR IN SECTIONS. IF NO REACTION IS GIVEN, THE MINIMUM SHEAR CAPACITIES IN THE TABLE TO THE RIGHT SHALL BE MAINTAINED.
- 3. THE STEEL FABRICATOR HAS THE OPTION TO USE ALTERNATE CONNECTION TYPES IN LIEU OF SINGLE PLATE CONNECTIONS, PROVIDED THAT THE MINIMUM SHEAR CAPACITIES AND NUMBERS OF BOLTS AS DEFINED IN THE TABLE ARE MAINTAINED, AND THE STEEL FABRICATOR PROVIDES FULL CALCULATIONS OR REFERENCES TO AISC STANDARD CONNECTION TABLES.
- 4. WHERE SHORT-SLOTTED HOLES ARE USED, THE HOLE MAY BE HORIZONTALLY SLOTTED IN EITHER THE BEAM WEB OR THE SHEAR PLATE AT THE FABRICATOR'S PREFERENCE.
- 5. MINIMUM SHEAR CONNECTION REQUIREMENTS ARE FOR ALLOWABLE STRENGTH DESIGN (ASD).

TYPICAL W-BEAM TO BEAM/COLUMN **SHEAR CONNECTION**

STRUCTURAL STEEL:

- ALL STRUCTURAL STEEL MATERIALS, WORKMANSHIP, AND DETAILS SHALL CONFORM TO THE REQUIREMENTS OF AISC 303-10 AND AISC 360-10. STRUCTURAL STEEL SHALL CONFORM TO THE FOLLOWING SPECIFICATIONS:
 - STRUCTURAL STEEL W- AND WT-SHAPES: ASTM A992 (GRADE 50) • STRUCTURAL PLATES: ASTM A572 (50 KSI) • STRUCTURAL ANGLES: ASTM A572 (GRADE 50)
- ALL STRUCTURAL STEEL SHALL BE UNPRIMED (TO RECEIVE SPRAYED-ON FIREPROOFING MATERIAL) UNLESS OTHERWISE NOTED.
- ALL EXPOSED STRUCTURAL STEEL AND THEIR ASSOCIATED CONNECTIONS, INCLUDING ANY DUNNAGE AND LOOSE LINTELS, SHALL BE HOT-DIPPED GALVANIZED. REFER TO ARCHITECTURAL DRAWINGS FOR COLOR GALVANIZING REQUIREMENTS.
- 4. SHOP OR FIELD WELDED CONNECTIONS SHALL CONFORM TO THE REQUIREMENTS OF THE LATEST EDITION OF AWS D1.1 "STRUCTURAL WELDING CODE - STEEL" BY THE AMERICAN WELDING SOCIETY AND SHALL USE E70 SERIES ELECTRODES. WHERE NO WELD SIZE IS INDICATED ON PLANS, DETAILS, OR SECTIONS, PROVIDE A MINIMUM OF 1/4" FILLET WELDS (ALL AROUND). ALL WELDING SHALL BE PERFORMED BY CERTIFIED WELDERS. ALL CERTIFICATIONS MUST BE CURRENT (i.e. WITHIN 12 MONTHS OF PERFORMANCE OF WELDING).
- SHOP OR FIELD BOLTED CONNECTIONS SHALL CONFORM TO THE REQUIREMENTS OF ASTM F3125, GRADE A325 OR GRADE A490. WHERE NO BOLT SIZE IS INDICATED ON PLANS, DETAILS, OR SECTIONS, PROVIDE A MINIMUM OF 3/4"Ø GRADE A325 BOLTS.


QUALITY ASSURANCE:

- THE OWNER WILL EMPLOY AND PAY FOR THE SERVICES OF AN INDEPENDENT TESTING AGENCY TO PROVIDE QUALITY ASSURANCE TESTING AND INSPECTIONS FOR WORK SPECIFIED IN CHAPTER 17 OF THE 2015 INTERNATIONAL BUILDING CODE, INCLUDING MASSACHUSETTS AMENDMENTS. THE TESTING AGENCY SHALL BE LICENSED IN MASSACHUSETTS AND ALL TESTING AND INSPECTIONS SHALL BE PERFORMED UNDER THE SUPERVISION OF AN ENGINEER REGISTERED IN MASSACHUSETTS.
- FAILURE OF QUALITY ASSURANCE TESTING AND INSPECTIONS TO DETECT ANY DEFECTIVE WORK OR MATERIAL SHALL NOT IN ANY WAY PREVENT LATER REJECTION WHEN SUCH DEFECT IS NOTED, NOR SHALL IT OBLIGATE THE OWNER'S REPRESENTATIVE FOR FINAL ACCEPTANCE.
- 3. THE TESTING AGENCY AND ITS REPRESENTATIVES ARE NOT AUTHORIZED TO REVOKE, ALTER, RELAX, ENLARGE OR RELEASE ANY PORTION OF THE WORK, PERFORM ANY DUTIES OF THE CONTRACTOR, OR BE A PARTY TO SCHEDULING OF WORK.
- RECORDS OF INSPECTIONS SHALL BE KEPT AVAILABLE TO THE BUILDING OFFICIAL DURING PROGRESS OF THE WORK AND FOR TWO YEARS AFTER COMPLETION OF THE PROJECT. RECORDS SHALL BE PRESERVED BY THE INDEPENDENT TESTING AGENCY.
- 5. REFER TO LIST OF REQUIRED SPECIAL INSPECTIONS BELOW:

LIST OF SPECIAL INSPECTIONS:

- STRUCTURAL STEEL:
 - A. GRADE B. PLACEMENT

 - C. BOLTED AND WELDED CONNECTIONS

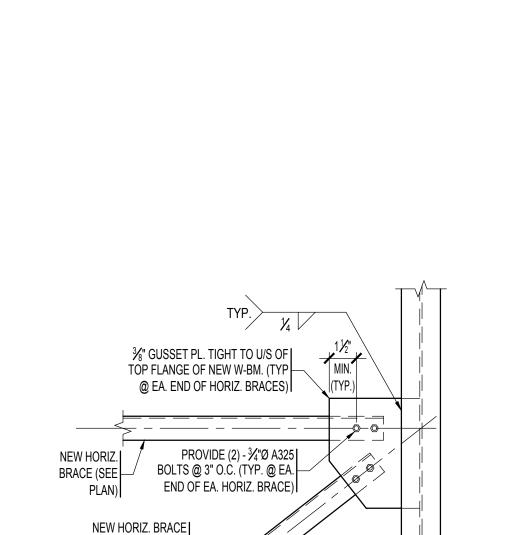


TYPICAL GUSSET PLATE CONNECTION FOR HORIZONTAL BRACES

NEW W-BM.

(SEE PLAN)


(SEE PLAN)

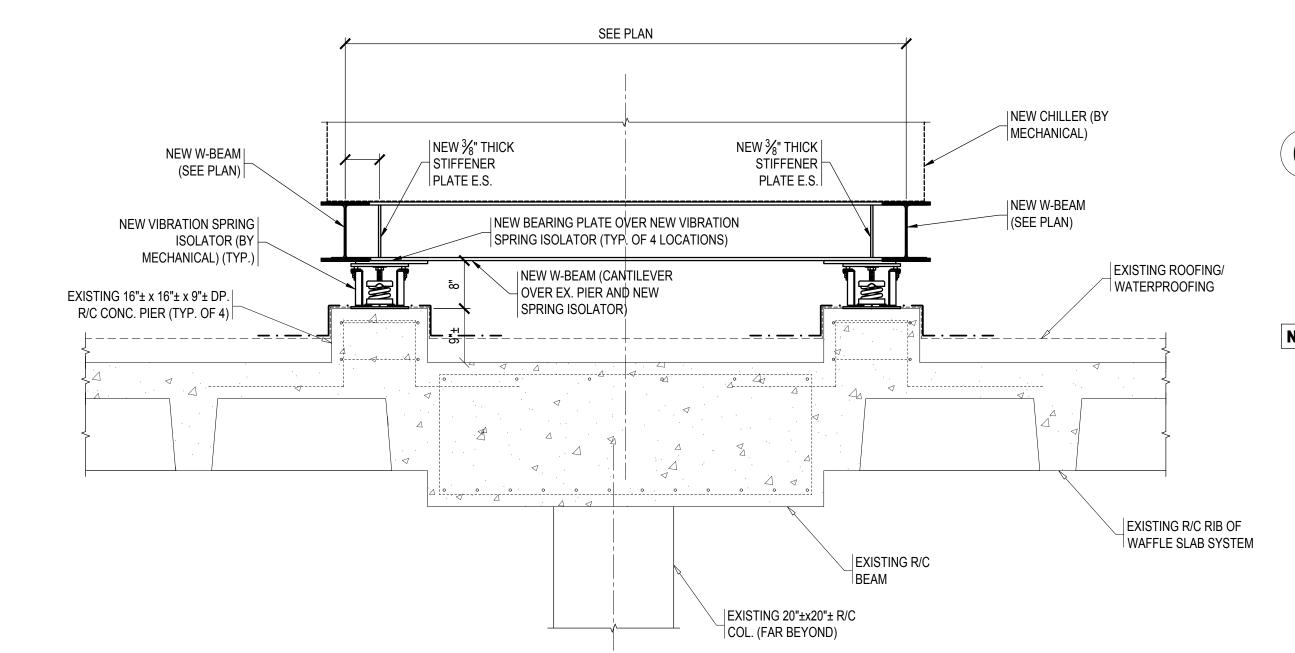

ASSOCIATED CONNECTIONS TO BE HOT-DIPPED

- "★" INDICATES CONTRACTOR TO COORDINATE WITH EQUIPMENT MANUFACTURER'S DRAWINGS, PRIOR TO SUBMISSION OF SHOP DRAWINGS
- 4. REFER TO GENERAL NOTES & TYPICAL DETAILS ON THIS DRAWING.
- WHERE REQUIRED, ALL FIELD WELDS AND SCARRED AREAS TO BE
- 6. CONTRACTOR TO RE-PATCH ALL PENETRATIONS THRU EXISTING ROOF MEMBRANE FOR A TIGHT AND SEALED FIT, AS REQUIRED - SEE ARCH. DWGS.
- 7. NEW DUNNAGE T.O.S. ELEVATION SHALL BE AS NOTED ON PLAN AND IN SECTIONS.
- TO THE SUBMISSION OF SHOP DRAWINGS. SHOP DRAWINGS THAT DO NO INCLUDE FIELD VERIFIED DIMENSIONS WILL BE REQUIRED TO BE RESUBMITTED PRIOR TO ACCEPTANCE.
- REQUIRED, TO PREVENT DAMAGE TO PERSONS OR PROPERTY. COORDINATE EXACT LOCATION AND SIZE OF UNIT WITH MECHANICAL DRAWINGS.
- MECHANICAL SHOP DRAWINGS, AND WITH LOCATIONS OF EXISTING STRUCTURAL MEMBERS. CONTRACTOR SHALL COORDINATE LOCATIONS OF NEW DUNNAGE IN THE FIELD WITH NEW MECHANICAL UNIT. CONTRACTOR SHALL VERIFY ALL DIMENSIONS WITH THE EQUIPMENT MANUFACTURER PRIOR TO SHOP DRAWING SUBMISSION.
- OF THE EXISTING STRUCTURE AND NEW DUNNAGE FRAMING.

- 14. PROVIDE ½" THICK x 12" x 12" BEARING PLATE OVER NEW SPRING ISOLATOR AND

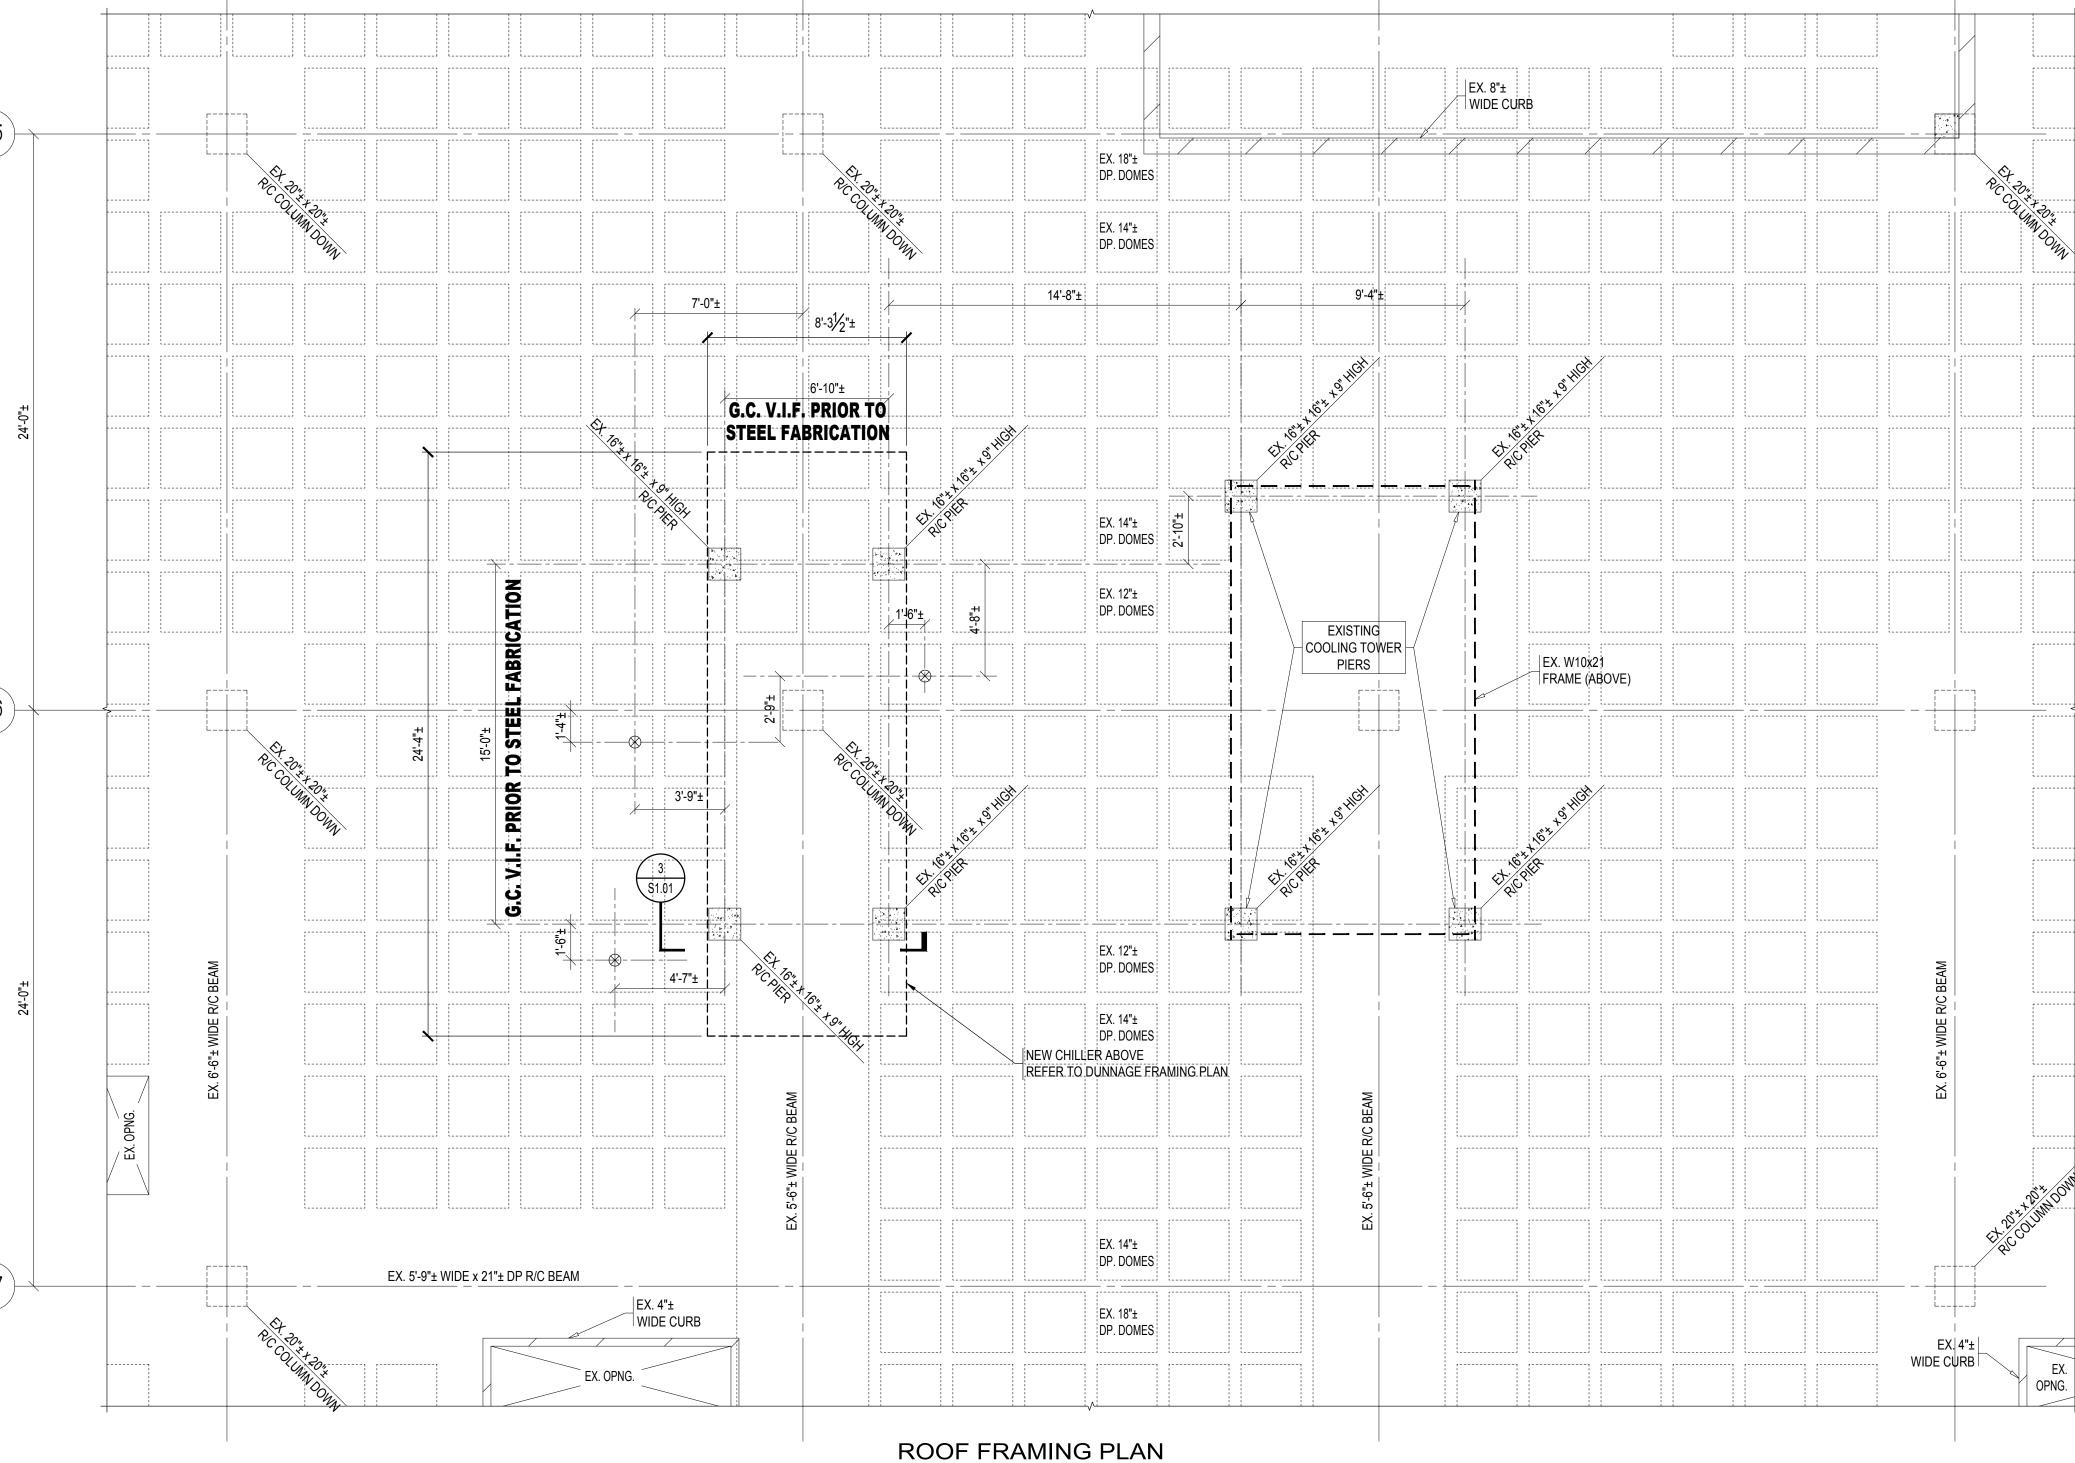

24'-0"±

24'-0"±

1/₄"=1'-0"

GALVANIZED. 3'-7"± 3'-3"± **NOTE #14** . GALV. W10x22 BM_. NOTE #14 NEW CHILLER WEIGHT = 21 KIPS NOTE #1 GALV. W8x10 BM. NOTE #14 NOTE #14

NOTE WELL: ALL STEEL &

DUNNAGE FRAMING PLAN

DUNNAGE FRAMING PLAN NOTES

- WHERE INDICATED, PROVIDE NEW GALV. L6x4x5/16 (LLV) HORIZONTAL BRACES. TOP OF STEEL AT NEW BRACES SHALL BE SET AT UNDERSIDE OF ADJACENT BEAM FLANGE BUT NO MORE THAN 2" BELOW ADJACENT TOP OF STEEL ELEVATION. (TYP. - U.O.N.). REFER TO DETAIL 2 ON DRAWING \$1.01.
- REFER TO MEP DRAWINGS FOR DIMENSIONS/ELEVATIONS NOT SHOWN.
- TOUCHED-UP W/ 4 MILS MIN. OF A ZINC-RICH PRIMER (BRUSH-APPLIED ONLY).
- ALL DIMENSIONS NOTED (±) SHALL BE VERIFIED IN FIELD BY THE CONTRACTOR PRIOR
- THE CONTRACTOR SHALL BE RESPONSIBLE FOR THE DESIGN AND EXECUTION OF ALL TEMPORARY SHORING AND BRACING DURING THE ENTIRE CONSTRUCTION PERIOD. AS
- 10. NEW MECHANICAL UNIT IS SHOWN IN APPROXIMATE LOCATION. CONTRACTOR SHALL
- 11. IF THE SIZE OR THE LOCATION OF THE NEW UNIT CHANGES, THE CONTRACTOR SHALL NOTIFY THE STRUCTURAL ENGINEER IMMEDIATELY FOR REVIEW AND RE-EVALUATION
- 12. EXISTING STRUCTURAL ELEMENTS SHALL NOT BE REMOVED OR MODIFIED, U.O.N.
- 13. ALL NEW STRUCTURAL STEEL AND ASSOCIATED CONNECTIONS SHALL BE HOT-DIPPED

AND PARTNERS INC. FRUCTURAL ENGINEERS CRANBERRY HILL, SUITE 301 LEXINGTON, MA 02421 WWW.SOUZATRUE.COM

NORTH ARROW

CONSULTANTS

24'-0"±

BID SET

PROJECT NAME/LOCATION WORCESTER POLICE

HEADQUARTERS

TEMP. CHILLER

REPLACEMENT

WORCESTER, MA 01608

02023.03

9-11 LINCOLN SQUARE


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GENERAL NOTES, PART PLAN, NOTES, & DETAILS




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178 Albion Street




CHECKED JAY MAY 24, 2023

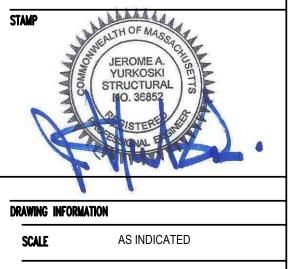DRAWING NUMBER

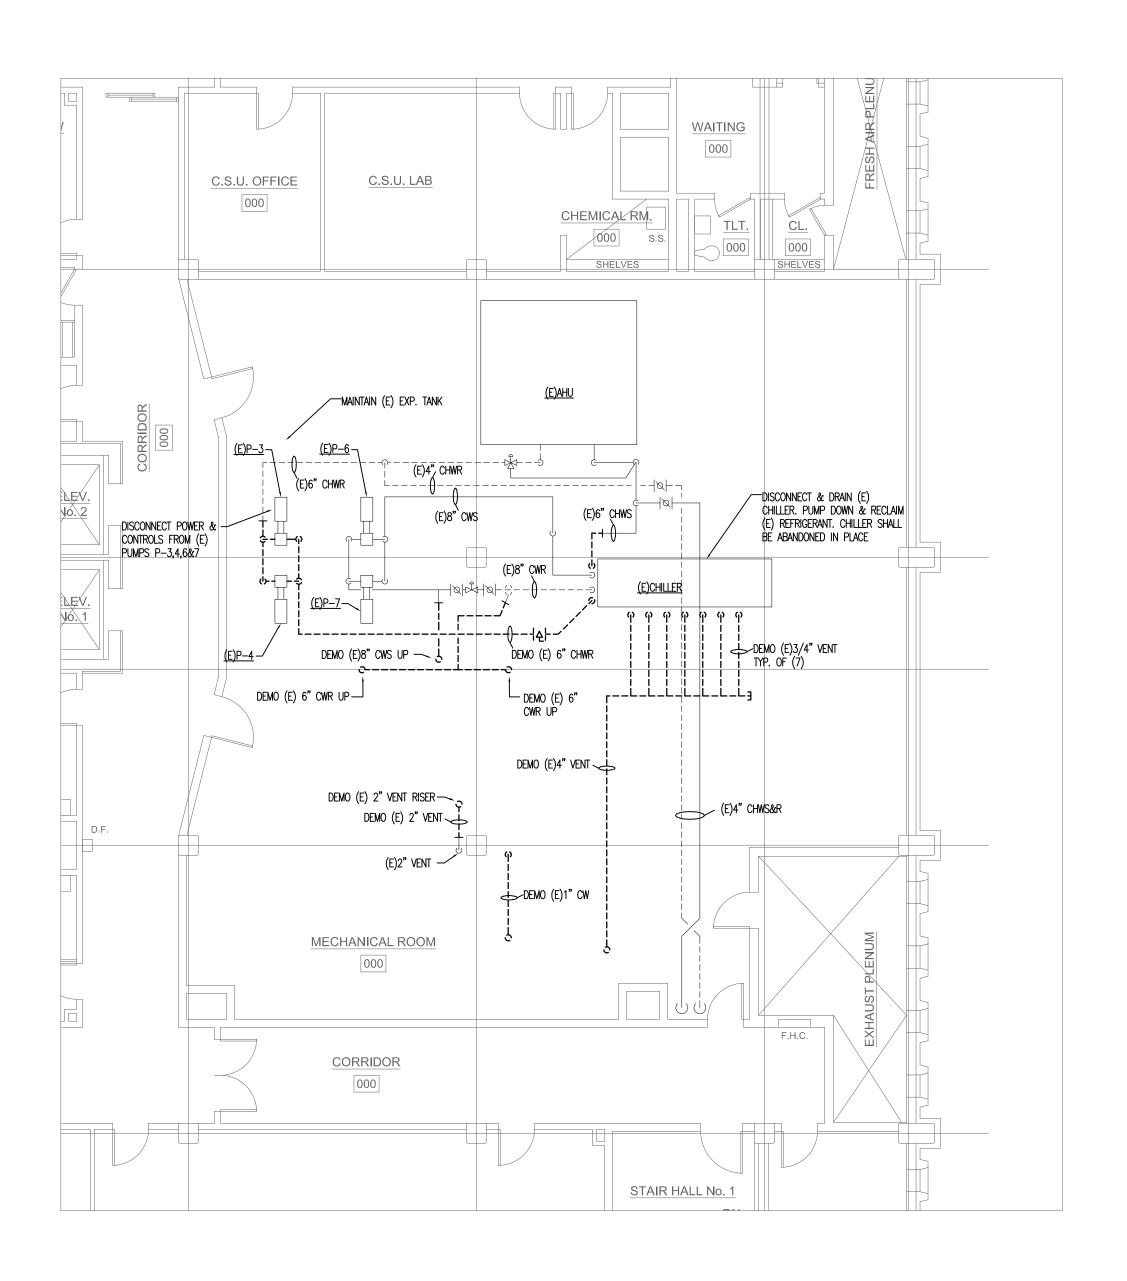


3RD FLOOR DEMO HVAC PLAN

SCALE: 1/8" = 1'-0"

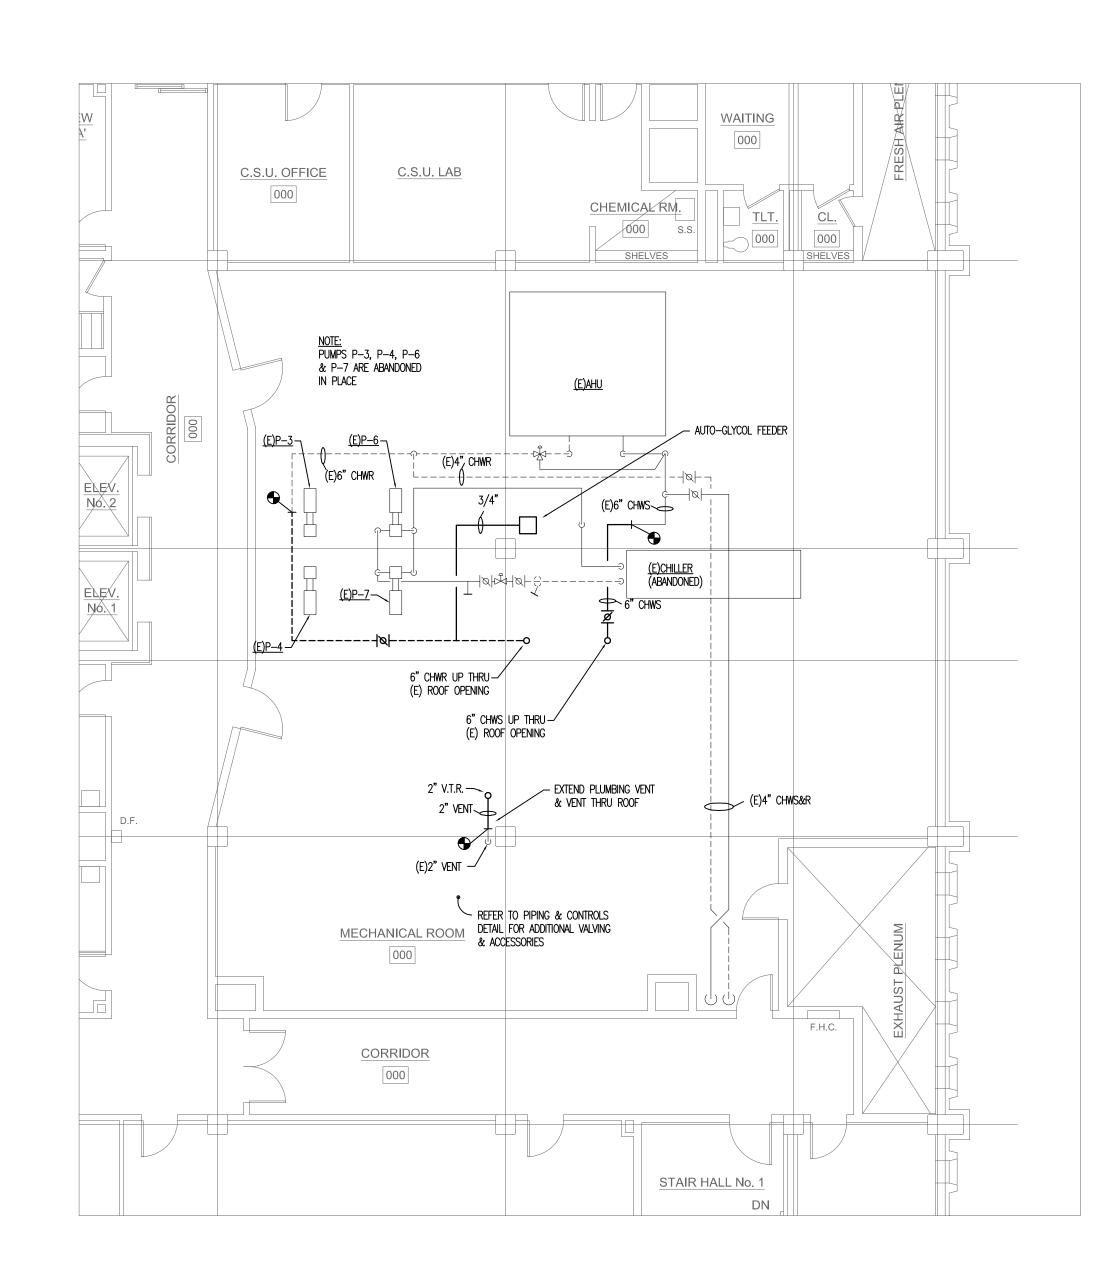


3RD FLOOR HVAC PLAN

SCALE: 1/8" = 1'-0"

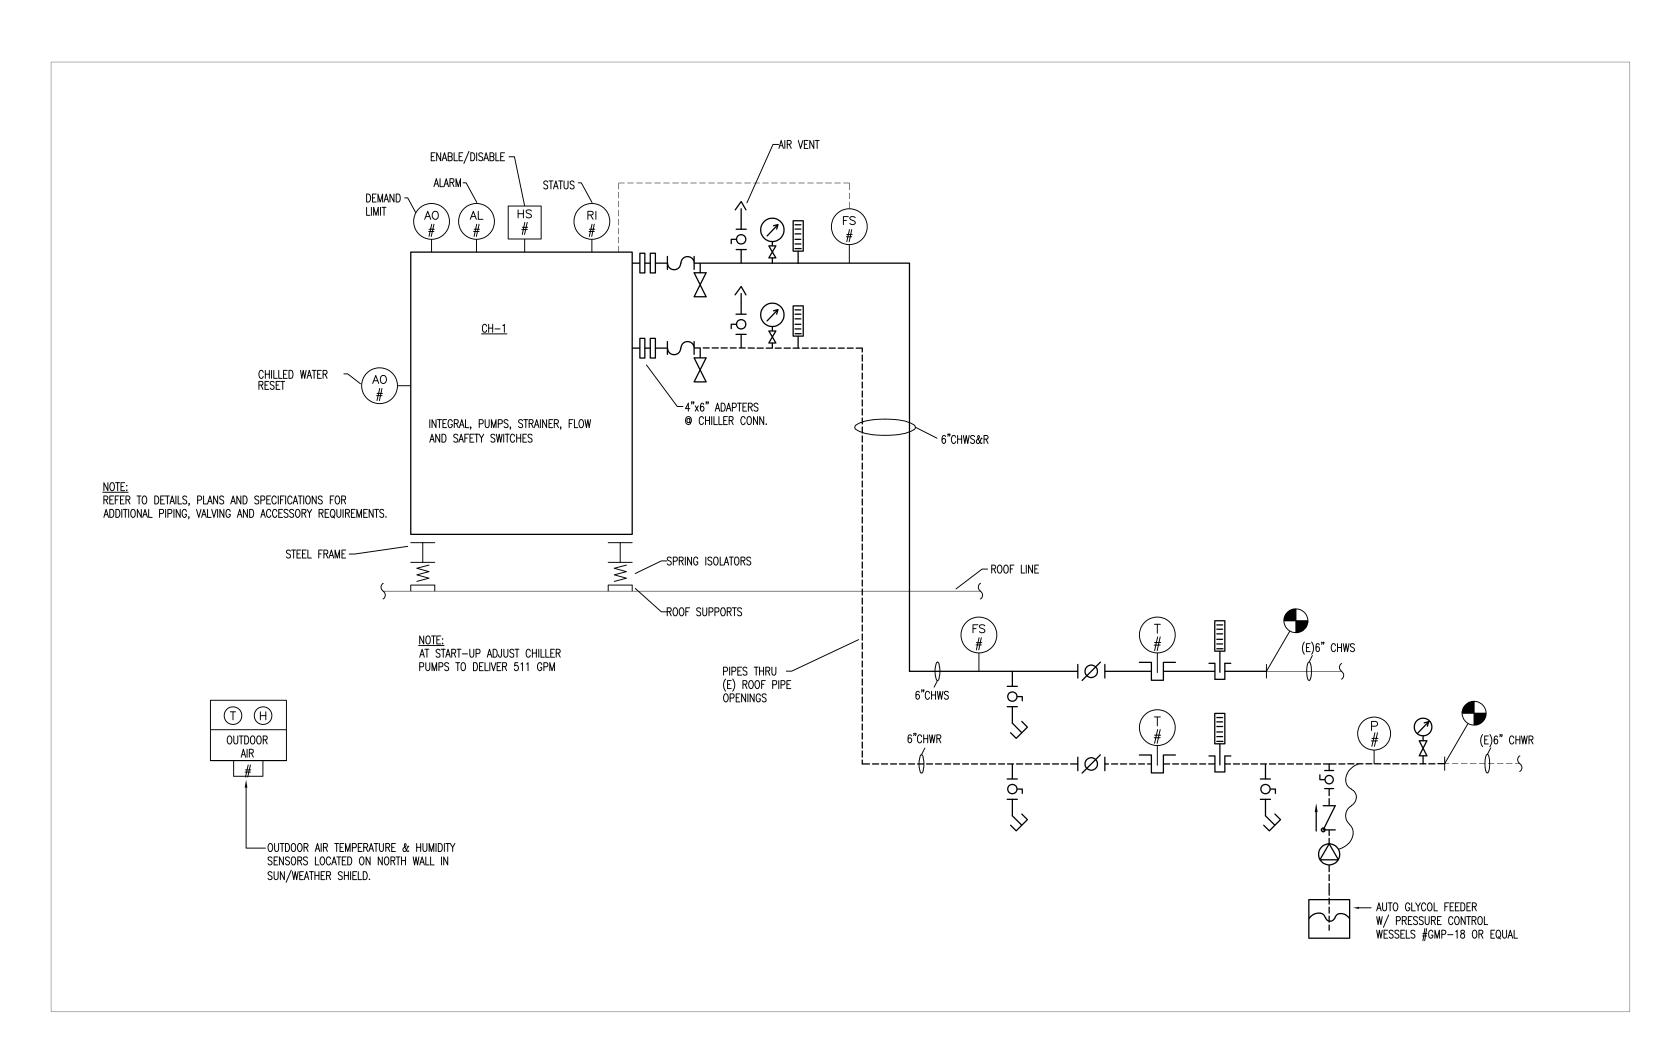

CHILLER PIPING & CONTROLS DETAIL

NO SCALE

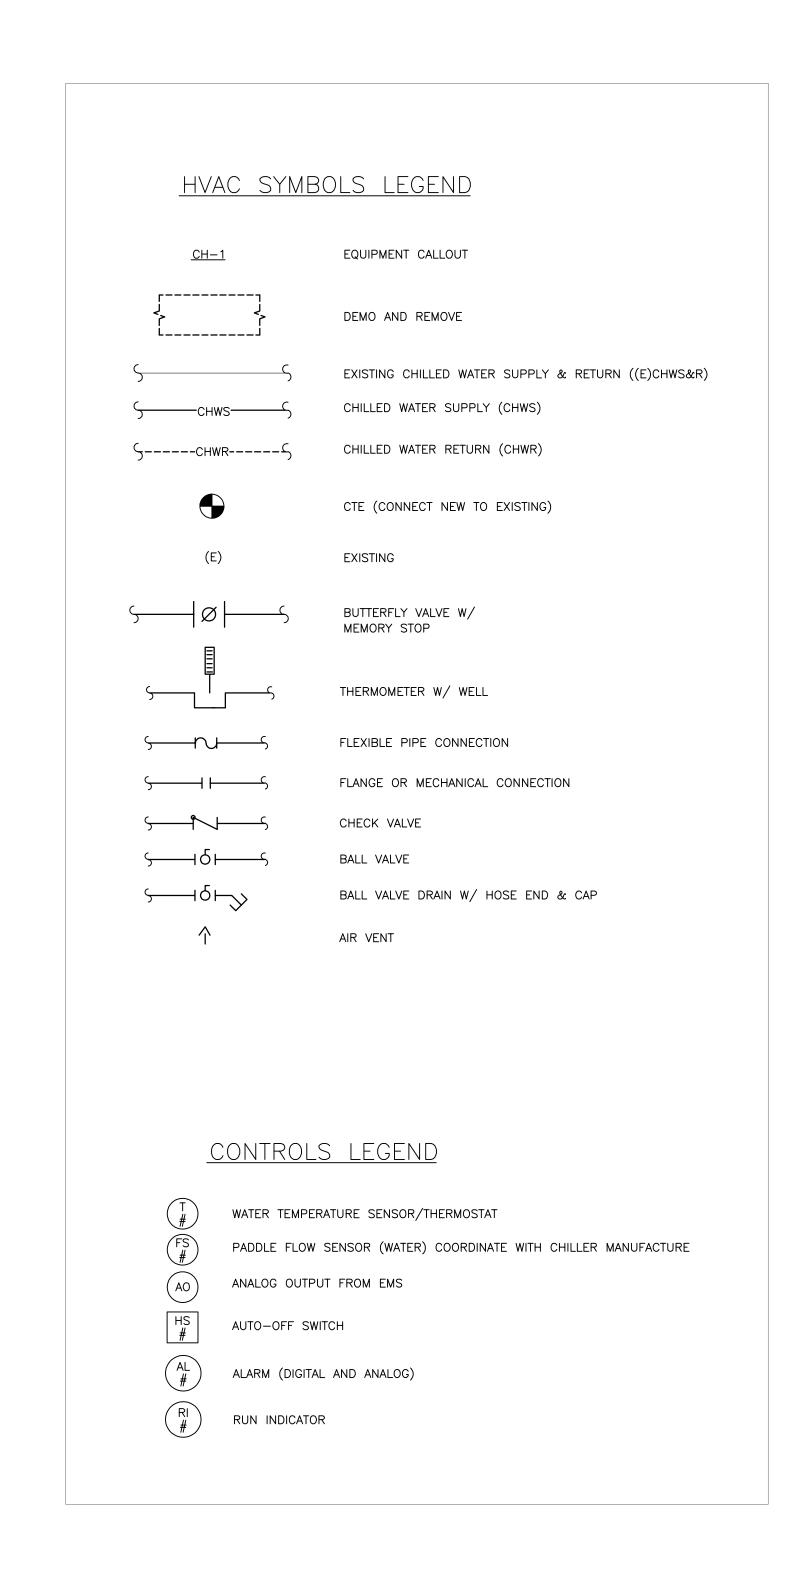

PROJECT PHASE **BID SET** PROJECT NUMBER 02023.03 PROJECT NAME/LOCATION WORCESTER POLICE **HEADQUARTERS** TEMP. CHILLER REPLACEMENT 9-11 LINCOLN SQUARE WORCESTER, MA 01608 DRAWING TITLE **DEMO & PROPOSED** 3RD FLOOR HVAC PLAN, SCHEDULES & DETAILS MOUNT VERNON GROUP ARCHITECTS 178 Albion Street Wakefield, Massachusetts 01880 781 213 5030 T 781 213 5040 F info@mvgarchitects.com E

DRAWING INFORMATION

DRAWING NUMBER


H-1

CHECKED KRS

MAY 24, 2023


NORTH ARROW

CONSULTANTS

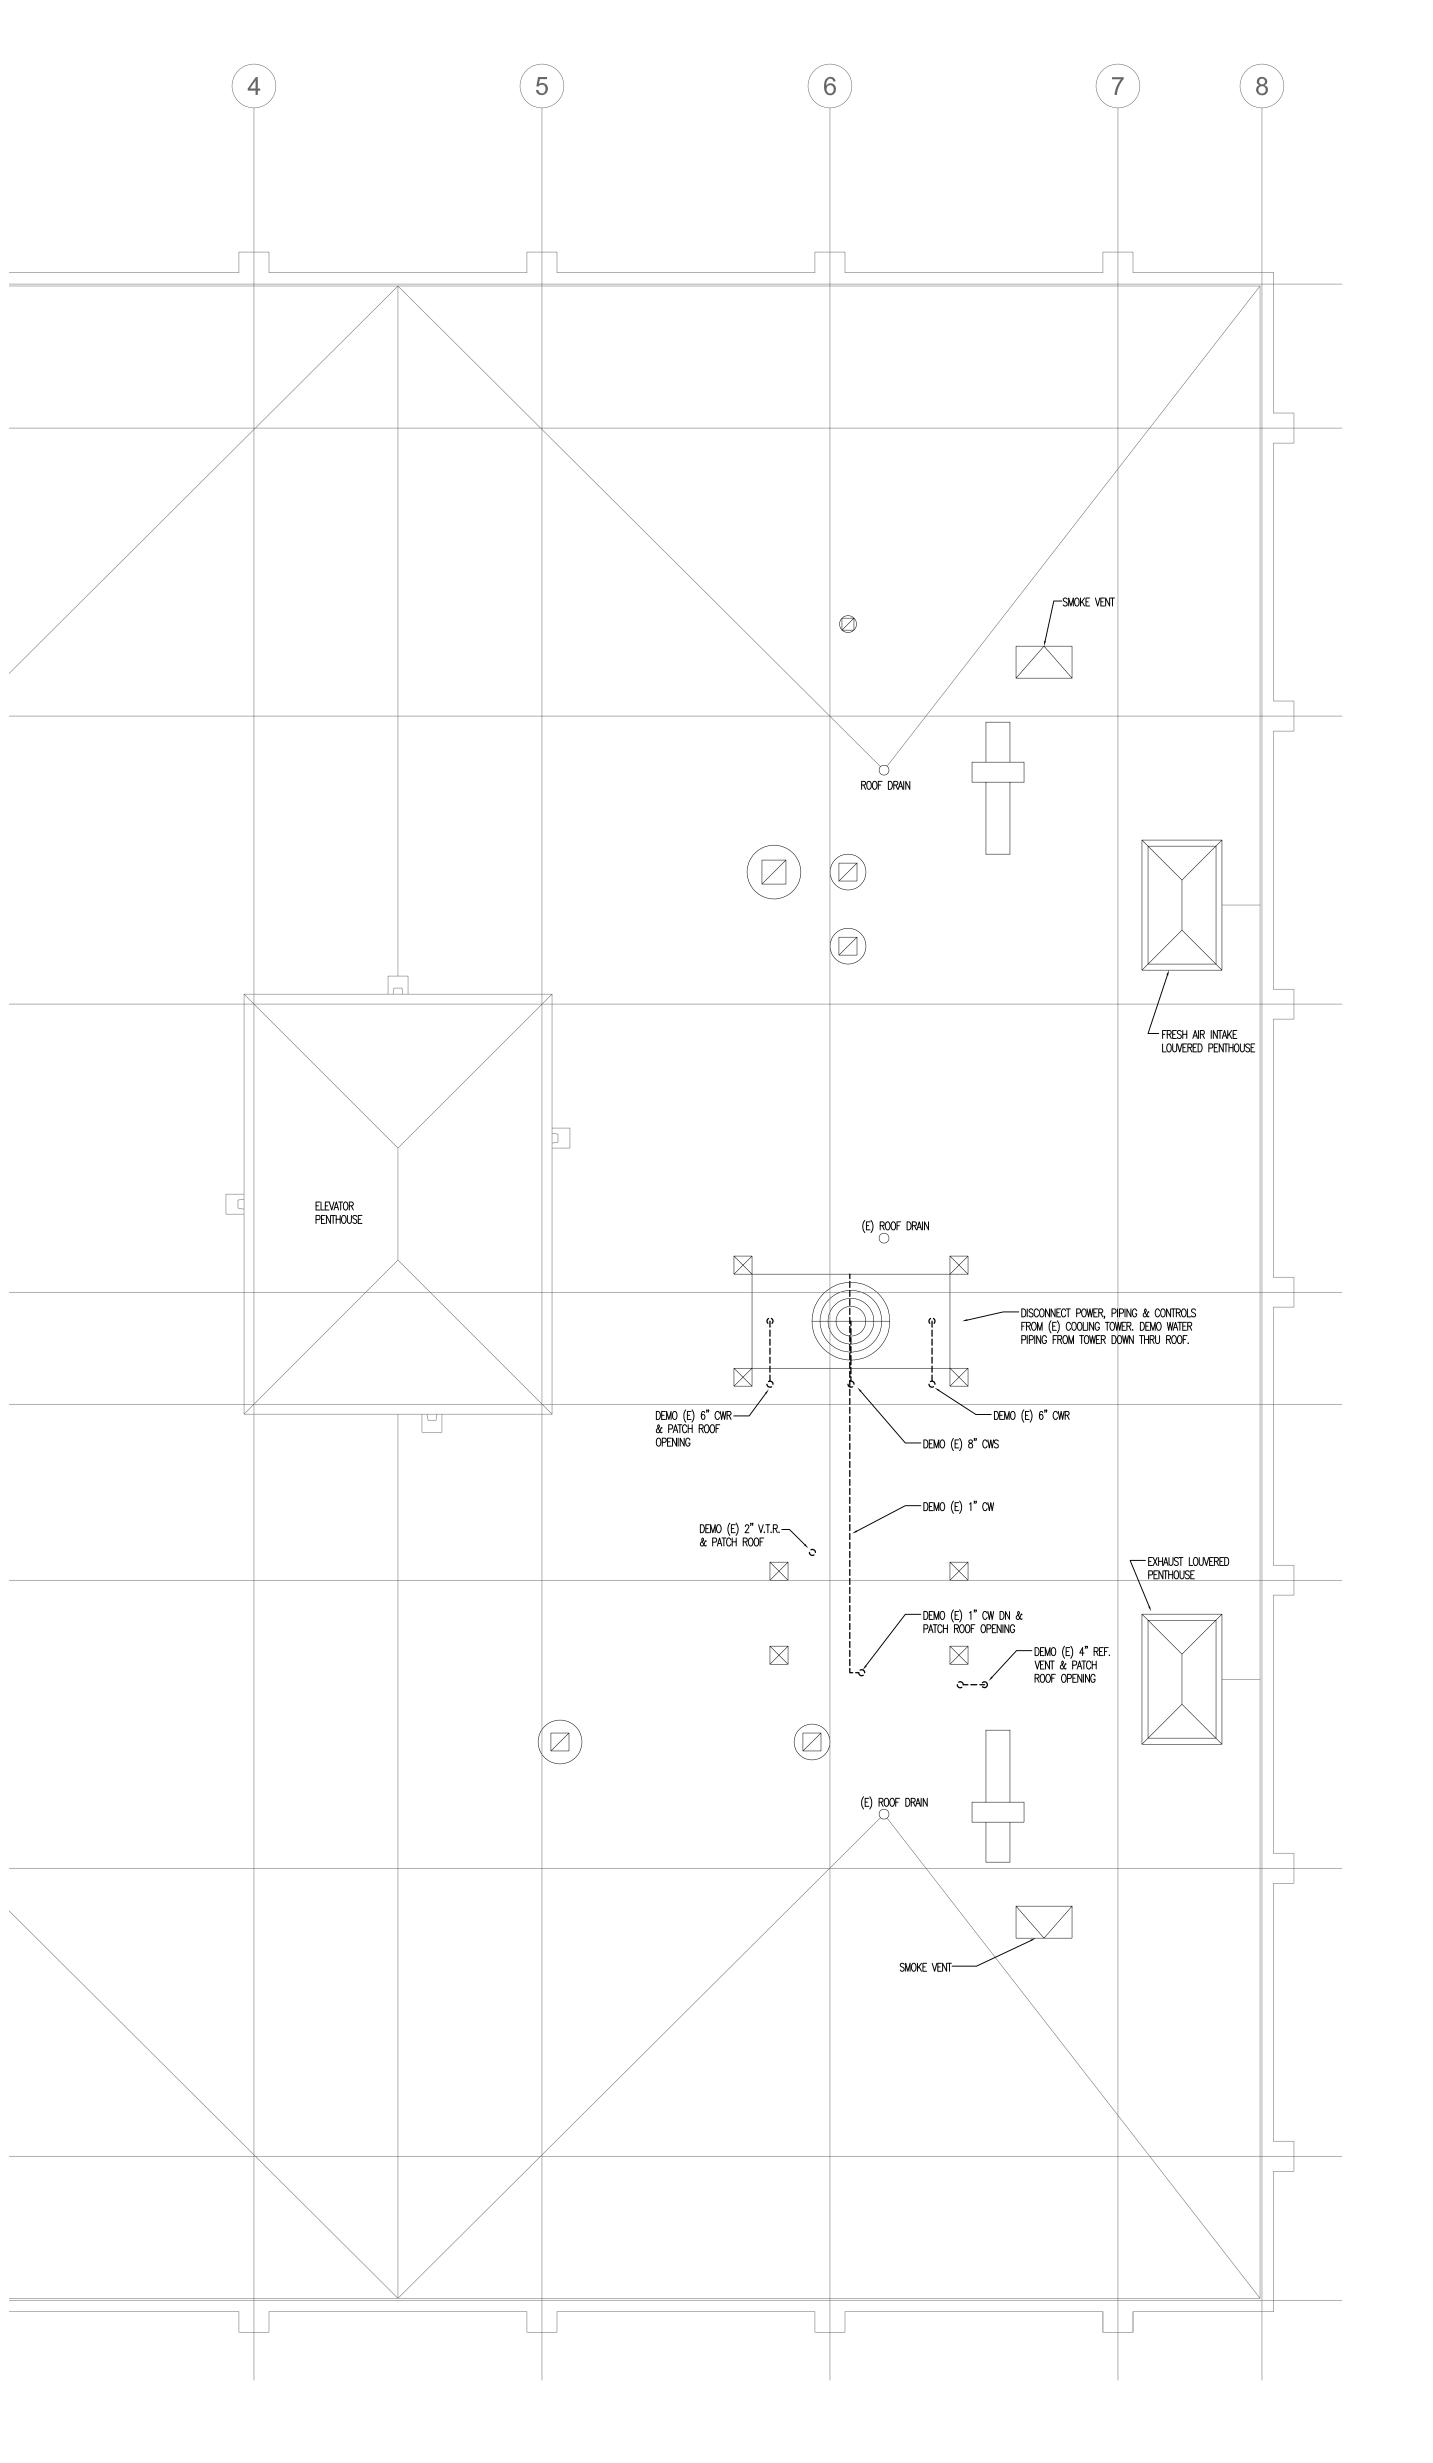

SCALE: 1/8" = 1'-0"

ROOF DEMO HVAC PLAN

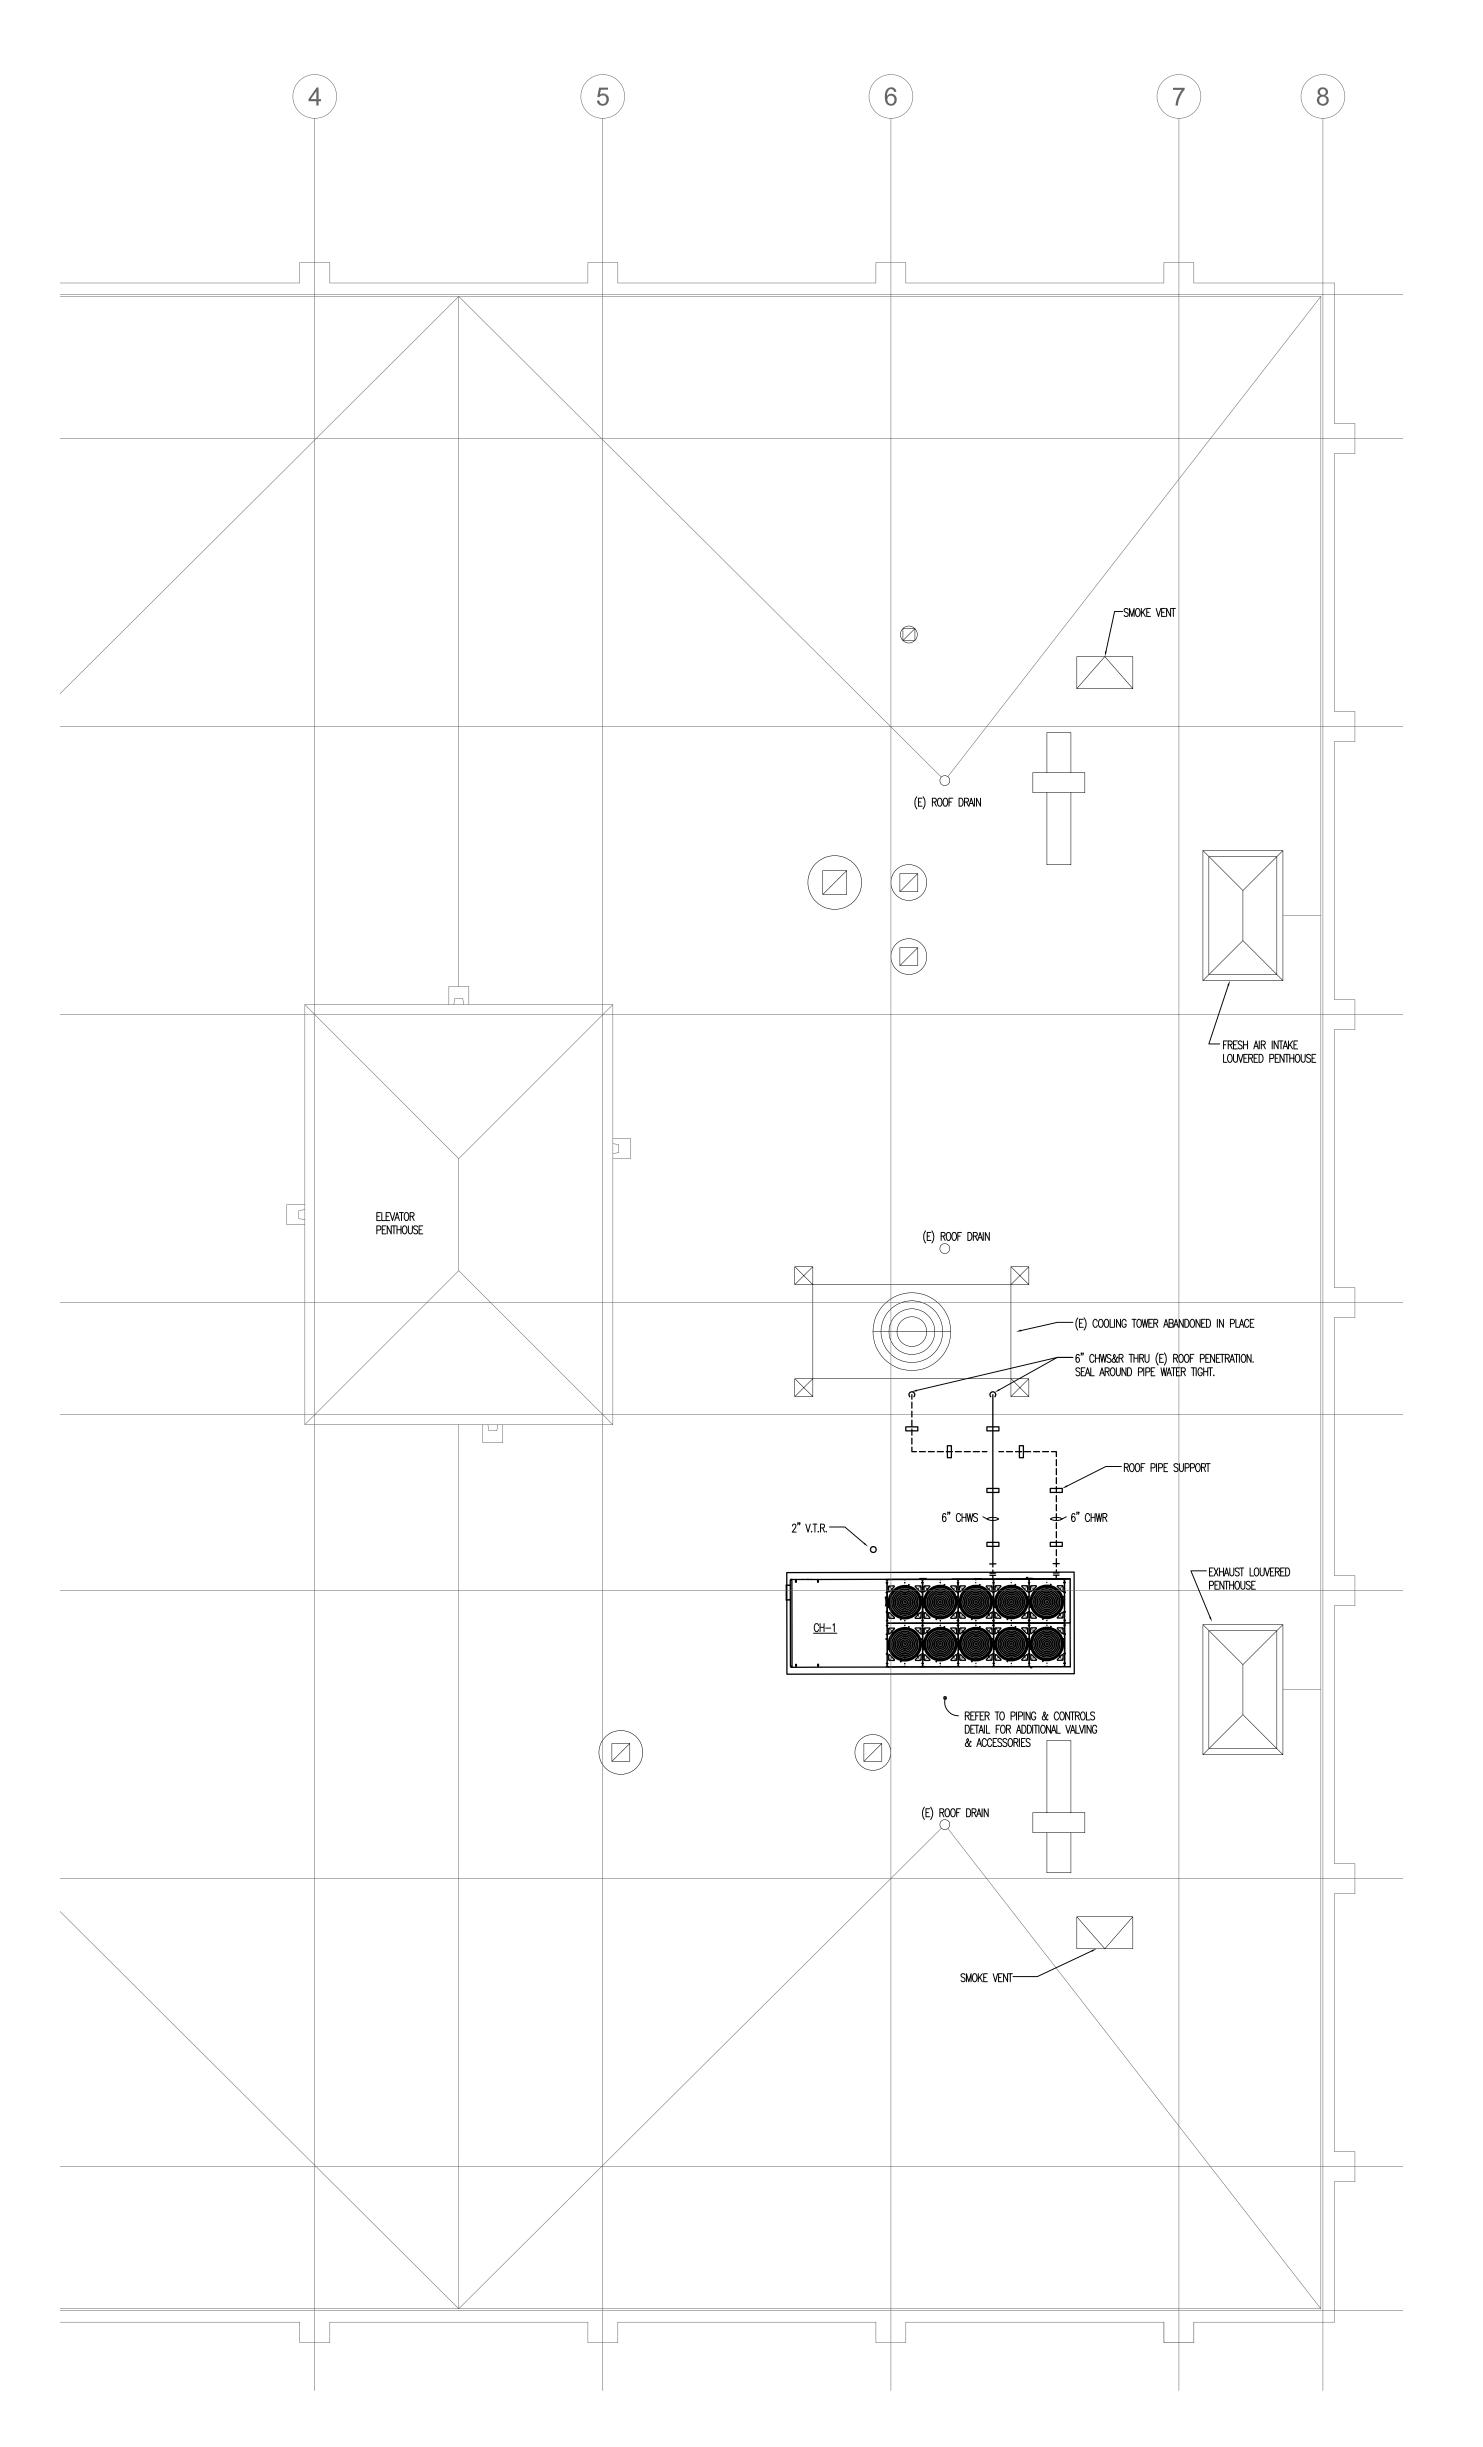

ROOF HVAC PLAN SCALE: 1/8" = 1'-0"

PROJECT PHASE

PROJECT NUMBER 02023.03

BID SET

PROJECT NAME/LOCATION WORCESTER POLICE HEADQUARTERS TEMP. CHILLER REPLACEMENT

9-11 LINCOLN SQUARE WORCESTER, MA 01608

DRAWING TITLE

DEMO & PROPOSED **ROOF HVAC PLAN**




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DRAWING INFORMATION **CHECKED** KRS **DATE** MAY 24, 2023

DRAWING NUMBER

H-2



ELECTRICAL EQUIPMENT LEGEND

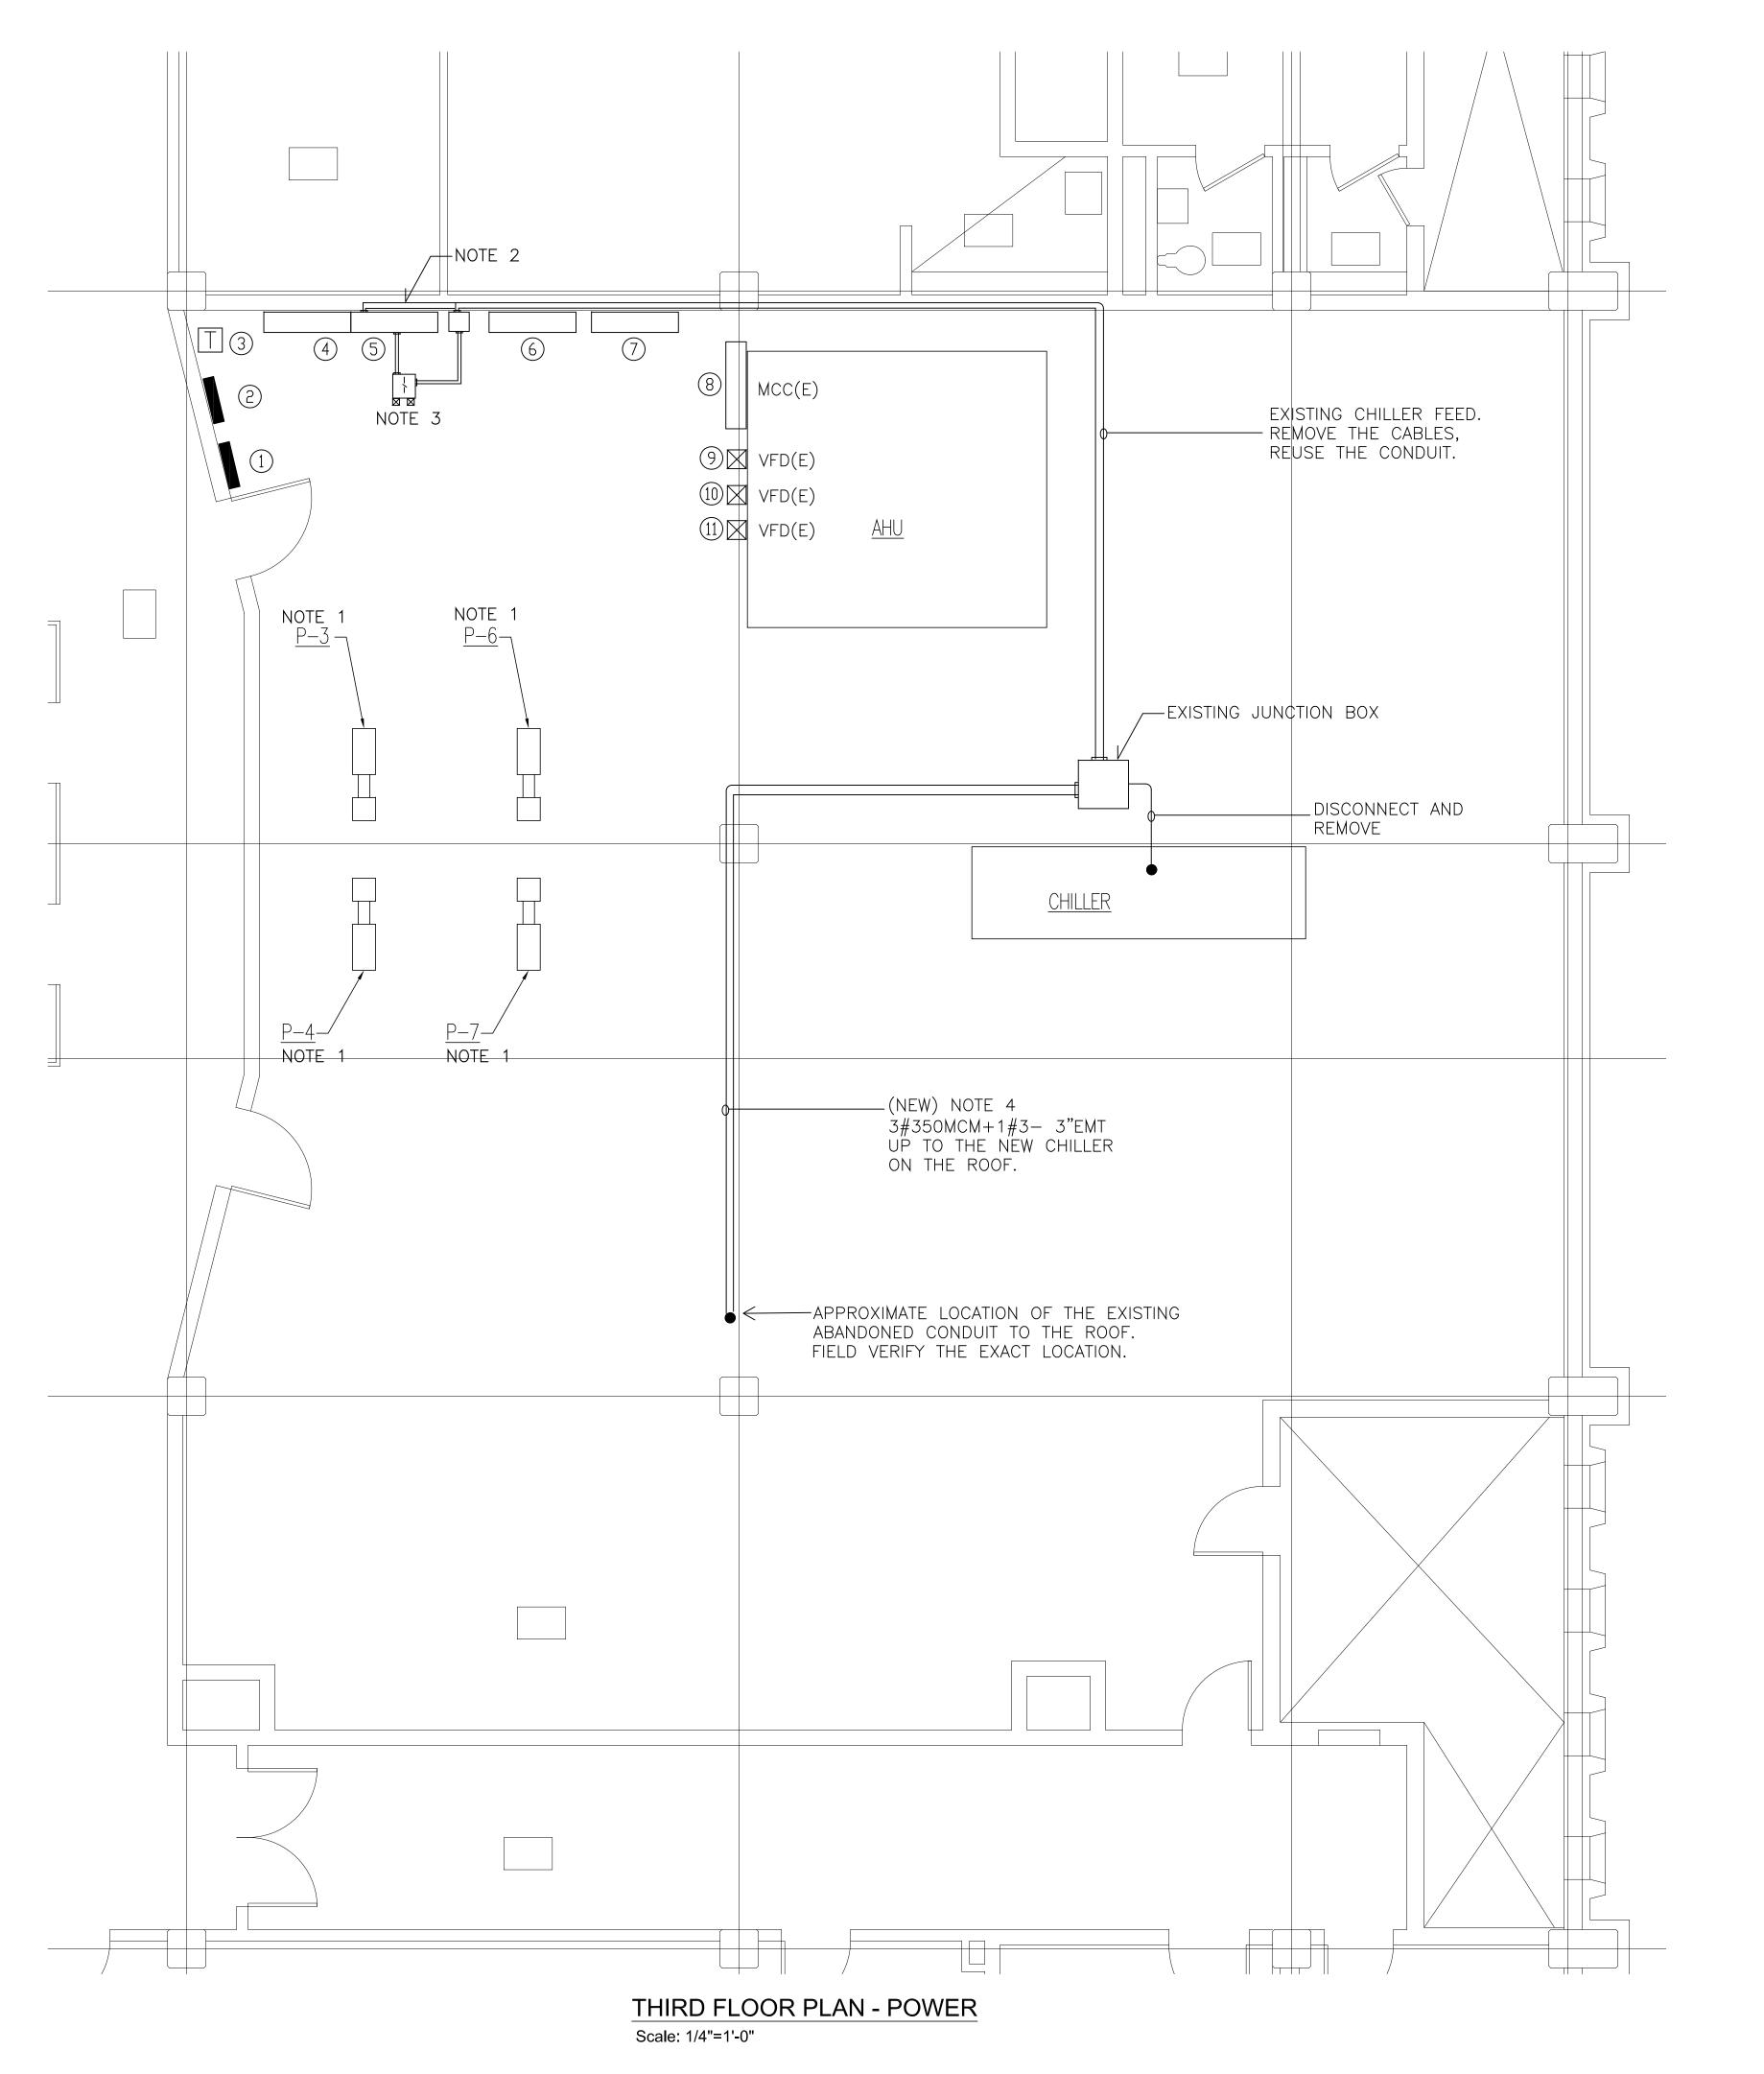- 1 PANEL CD3 (FPE) 100A MLO 120/208V 3PHASE 4W
- 9KVA TRANSFORMER 480V DELTA- 120/208V WYE
- PANEL MP3-1A (FPE) 1000A MLO 277/480V 3PHASE 4W
- PANEL MP3-1B (FPE) SECTION 2 277/480V 3PHASE 4W. SEE NOTE 2
- ELECTRIC DUCT HEATER PANEL 480V, 3PHASE, 3W. FED TO MP3-1A
- HVAC CONTROL PANEL
- MOTOR CONTROL CENTER. FED TO MP3-1B

NOTE 1:
DISCONNECT AND REMOVE THE EXISTING PUMP ELECTRICAL FEEDS IN THEIR ENTIRETY BACK TO THE MOTOR CONTROL CENTER (MCC). LABEL THE CIRCUITS AS SPARE.

NOTE 2: DISCONNECT AND REMOVE THE EXISTING 300A-480V-3 POLE CIRCUIT BREAKER IN PANEL MP3-1B DEDICATED FOR THE CHILLER. INSTALL A BLANK COVER PLATE OVER THE BREAKER BEING REMOVED.

NOTE 3: FURNISH AND INSTALL A NEW 300A MCB-480V-3 POLE DISCONNECT SWITCH IN FRONT OF THE EXISTING PANEL MP3-1B. INSTALL ON A UNI-STRUT SUPPORT. INSTALL 3#350MCM THW (CU) + 1#3 THW (CU) CONDUCTORS IN A 3" EMT CONDUIT TO THE NEW DISCONNECT SWITCH. TAP THE LOAD SIDE OF THE EXISTING PANEL BUSSING. DISCONNECT AND REMOVE THE EXISTING BRANCH FEEDER FROM PANEL MP3-1B TO THE EXISTING CHILLER BEING ABANDONED. FROM THE NEW DISCONNECT INSTALL 3#350MCM THW(CU) + 1#3 THW (CU) IN A 3" EMTCONDUIT UP TO THE NEW ROOFTOP CHILLER.

- PANEL M31 (FPE) 30A MCB 120/208V 3PHASE 4W

- VFD ROOF AHU
- VFD RA12

NORTH ARROW

CONSULTANTS

SHEPHERD ENGINEERING, INC. ELECTRICAL CONSULTANTS

PHONE: (508) 757-7793 * FAX: (508) 753-2309 REFERENCE NO.: 23112

PROJECT PHASE **BID SET**

PROJECT NUMBER

PROJECT NAME/LOCATION WORCESTER

02023.03

POLICE HEADQUARTERS TEMP. CHILLER REPLACEMENT

9-11 LINCOLN SQUARE

WORCESTER, MA 01608

DRAWING TITLE

THIRD FLOOR PLAN **POWER**



MOUNT VERNON GROUP ARCHITECTS 178 Albion Street Suite 240

> 781 213 5030 T 781 213 5040 F

Wakefield, Massachusetts 01880


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DRAWING INFORMATION

DRAWN BY AJV CHECKED JDS

DATE MAY 30, 2023

DRAWING NUMBER

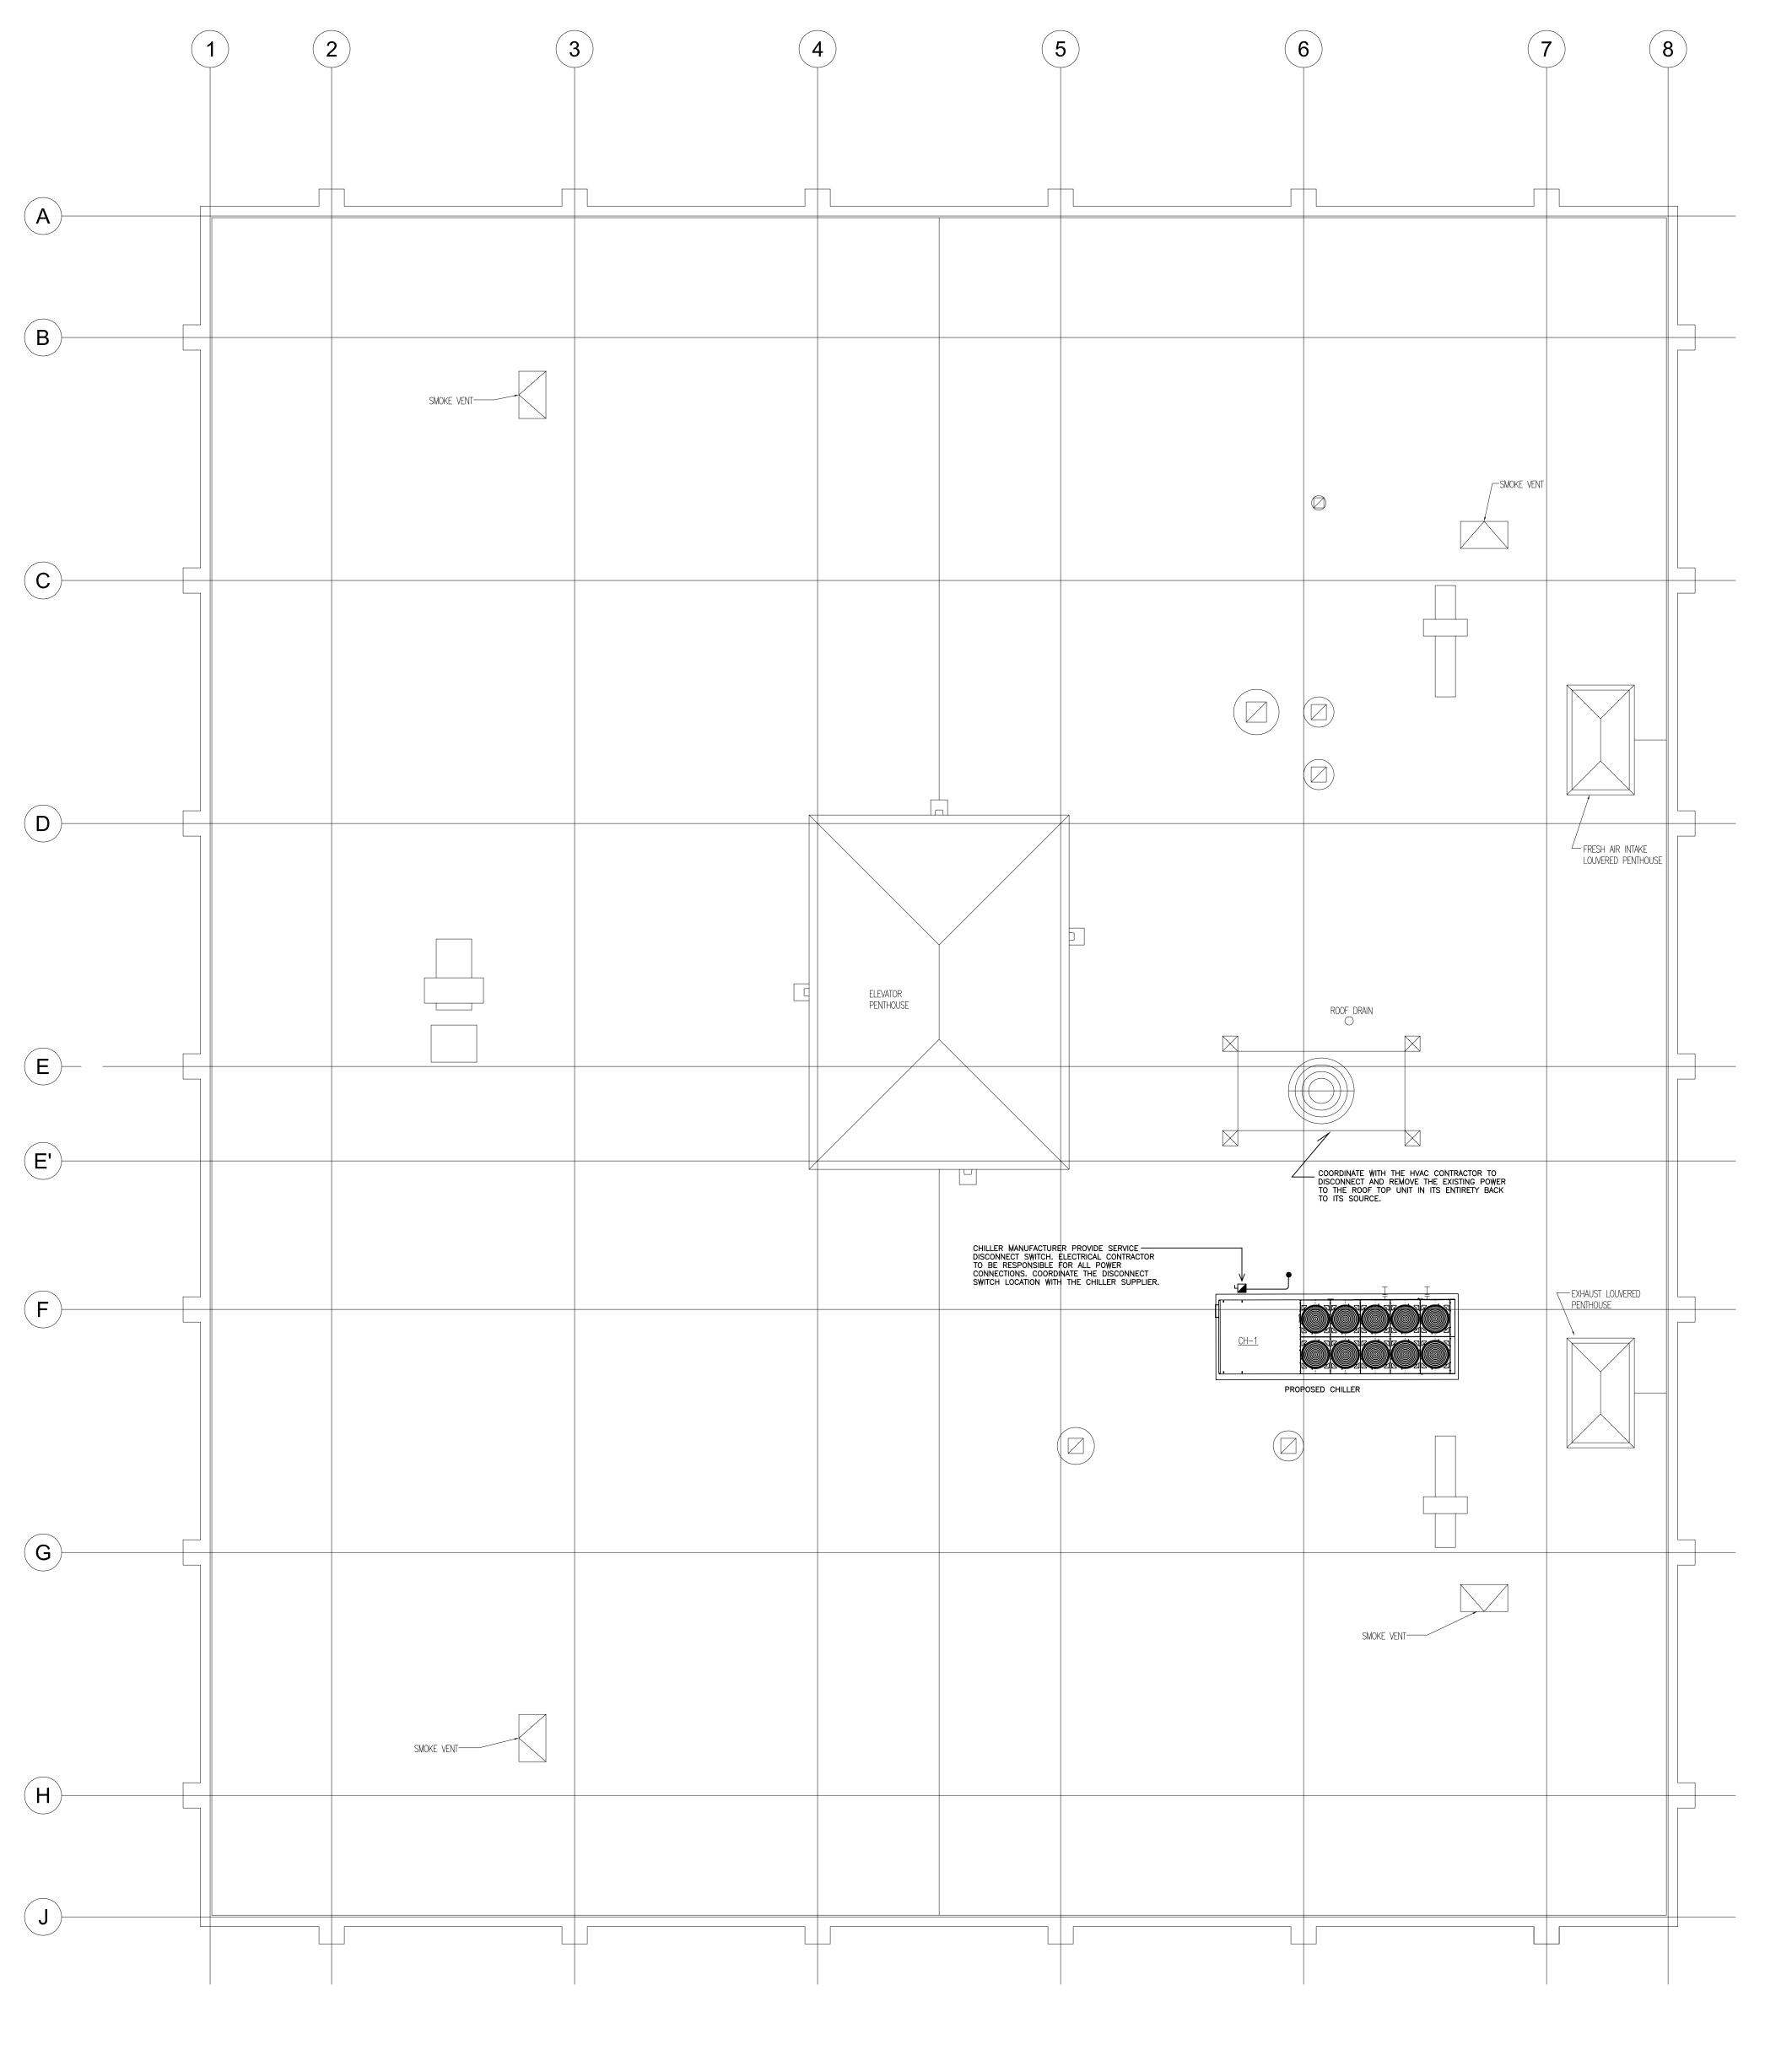

ROOF PLAN - POWER
Scale: 1/8"=1'-0"

NORTH ARROW

CONSULTANTS

SHEPHERD ENGINEERING, INC

SHEPHERD ENGINEERING, INC.

ELECTRICAL CONSULTANTS

1308 GRAFTON STREET
WORCESTER, MASSACHUSETTS 01604

PHONE: (508) 757-7793 * FAX: (508) 753-2309
REFERENCE NO.: 23112

REVISIONS

PROJECT PHASE

BID SET

PROJECT NUMBER

PROJECT NAME/LOCATION

WORCESTER
POLICE

WORCESTER
POLICE
HEADQUARTERS
TEMP. CHILLER
REPLACEMENT

9-11 LINCOLN SQUARE WORCESTER, MA 01608

DRAWING TITLE

ROOF PLAN POWER



A R C H I T E C T S

178 Albion Street
Suite 240
Wakefield, Massachusetts 01880

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DRAWING INFORMATION

SCALE 1/8" = 1'-0"


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DATE MAY 30, 2023

DRAWING NUMBER

E2.1



NORTH ARROW

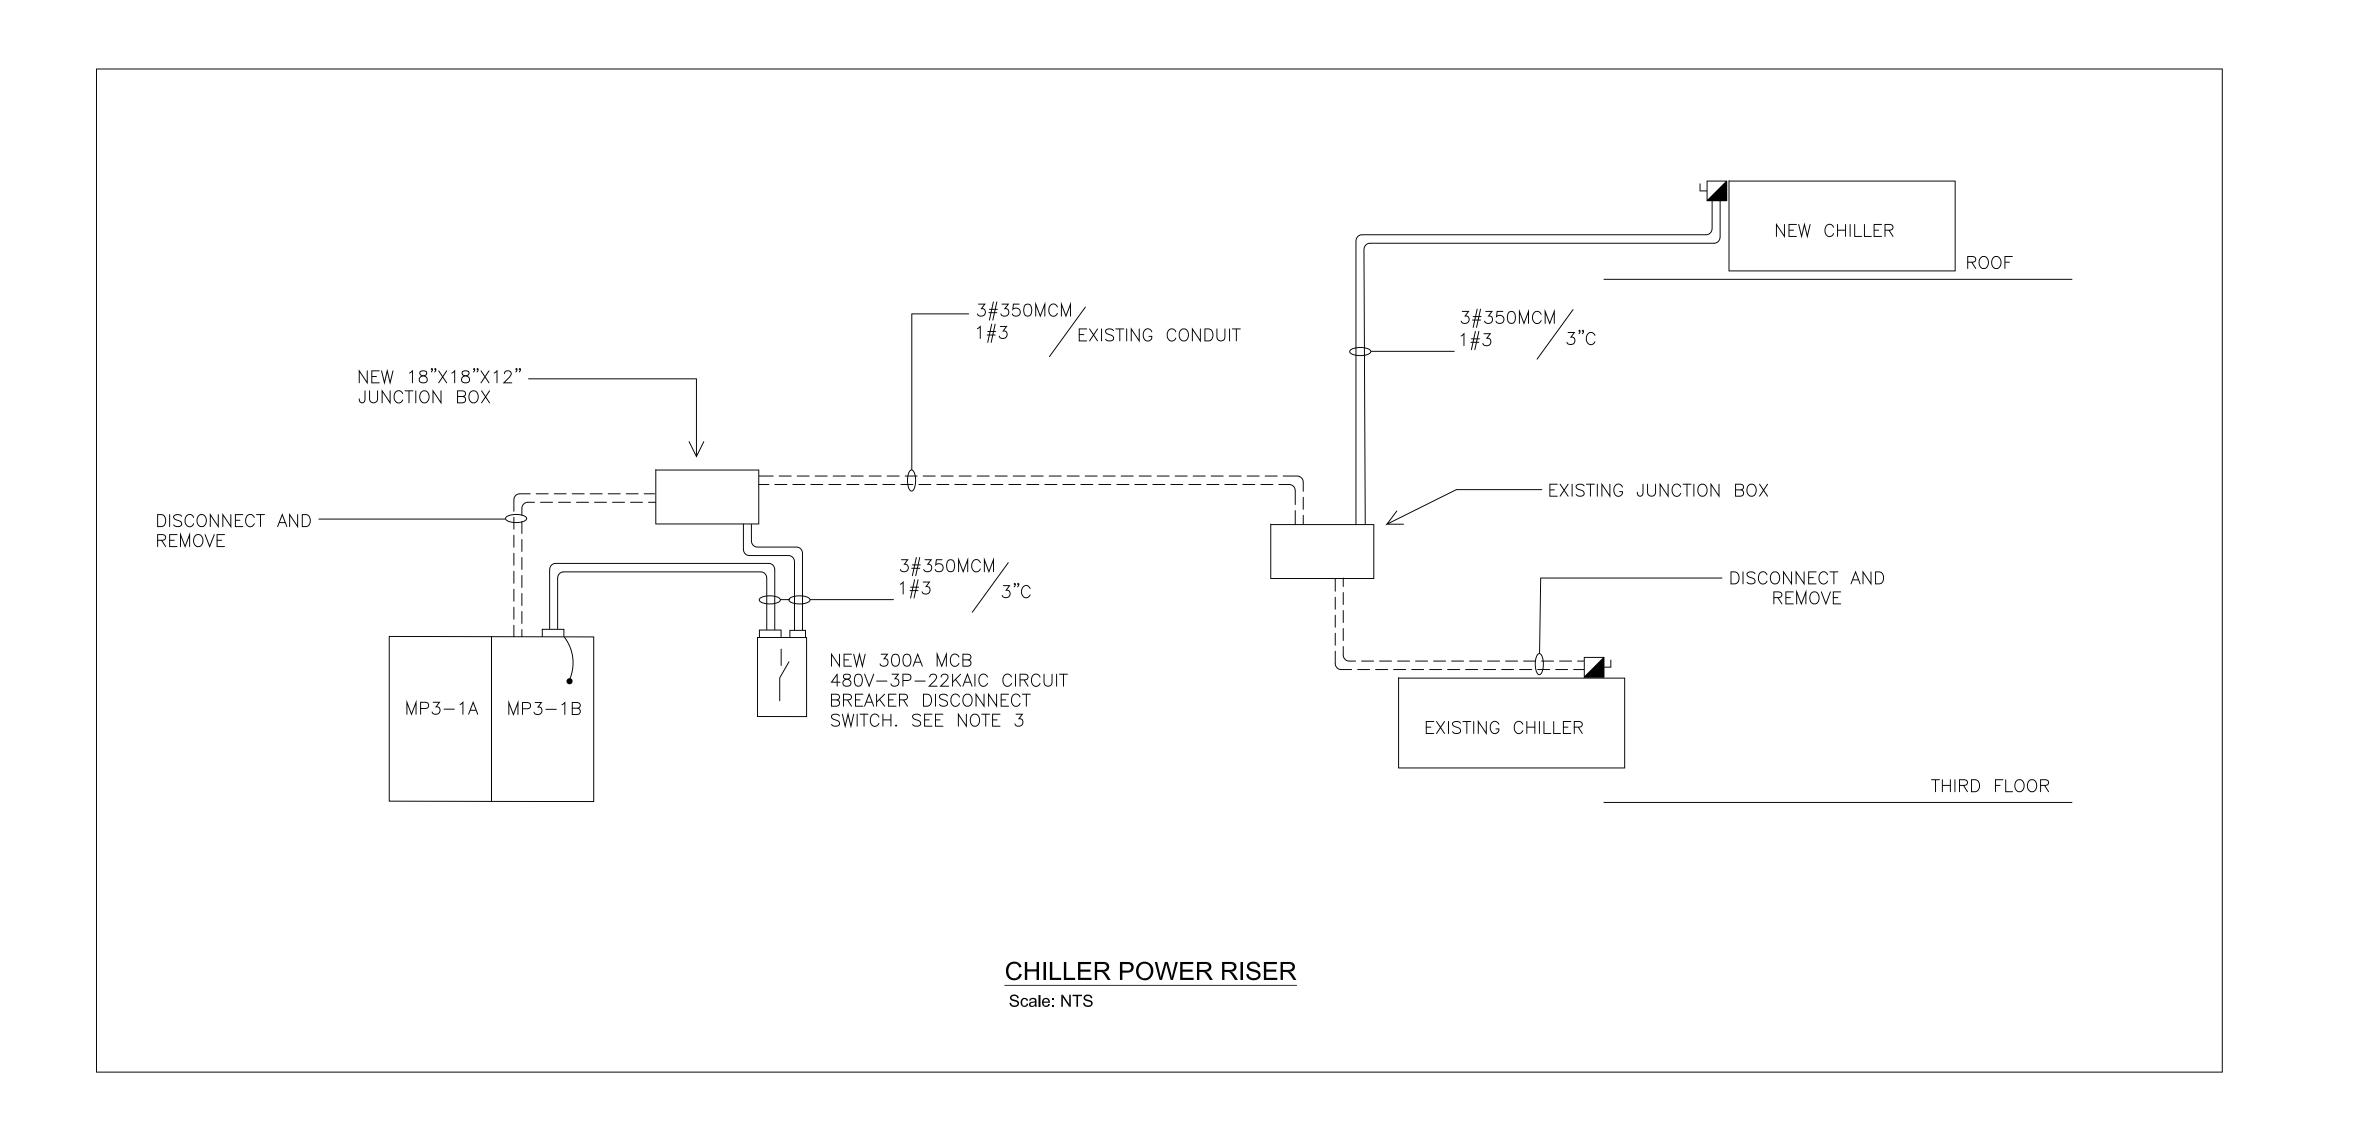CONSULTANTS

SHEPHERD ENGINEERING INC

SHEPHERD ENGINEERING, INC.

ELECTRICAL CONSULTANTS

1.308 GRAFTON STREET
WORCESTER, MASSACHUSETTS 01604

PHONE: (508) 757-7793 * FAX: (508) 753-2309
REFERENCE NO.: 23112

REVISIONS

PROJECT PHASE
BID SET

PROJECT NUMBER 02023.03

PROJECT NAME/LOCATION

WORCESTER

POLICE

HEADQUARTERS

TEMP. CHILLER

REPLACEMENT

9-11 LINCOLN SQUARE WORCESTER, MA 01608

RAWING TITLE

LEGENDS AND SCHEDULES



M O U N T V E R N O N G R O U P A R C H I T E C T S

Suite 240 Wakefield, Massachusetts 01880 781 213 5030 T 781 213 5040 F

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DRAWING INFORMATION

SCALE 1/8" = 1'-0"

DRAWN BY AJV

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DATE MAY 30, 2023

DRAWING NUMBER

E3.1