
UNION STATION NEW FIRST FLOOR TOILET ROOM AND SHOWER ROOM

2 WASHINGTON SQUARE, WORCESTER, MA

BID SET JUNE, 2022



LOCUS PHOTO

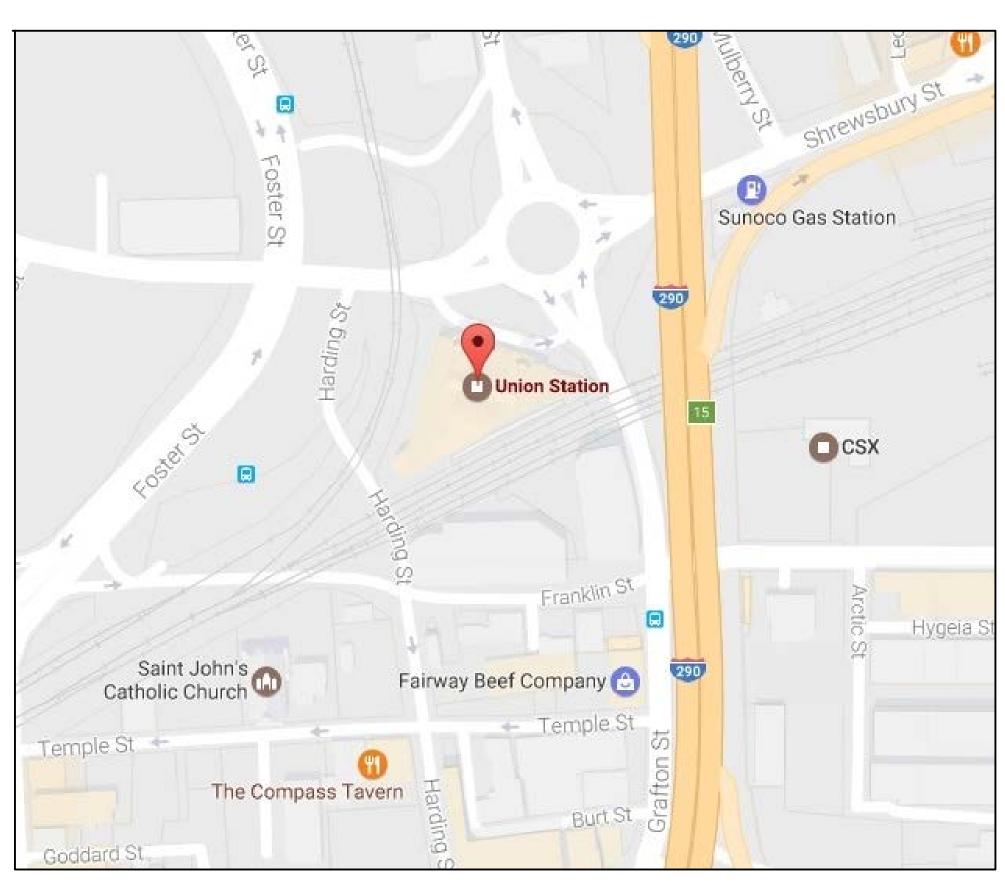

LOCUS MAP - NOT TO SCALE

ARCHITECT:



71 HOPE AVENUE WORCESTER, MA 01603 TEL: (508)755-6134 FAX: (508) 754-4661 MECHANICAL ENGINEER:



LIST OF DRAWINGS

T1 - COVER SHEET

A1.0 - FIRST FLOOR TOILET AND SHOWER ROOM PLANS, ELEVATIONS AND DETAILS

FP0.0 - FIRE PROTECTION LEGEND AND ABBREVIATIONS

FP1.0 - FIRE PROTECTION NEW WORK PLAN

PO.O - PLUMBING LEGEND AND ABBREVIATIONS

P1.0 - PLUMBING PLAN

P2.0 - PLUMBING DETAILS AND SCHEDULES

HO.O - MECHANICAL LEGEND AND ABBREVIATIONS

H1.0 - HVAC DUCTWORK DEMO AND NEW WORK

H2.0 - HVAC SCHEDULE AND DETAILS

E0.1 - ELECTRICAL LEGEND AND NOTES

E1.0 - ELECTRICAL FLOOR PLANS

E5.0 - ELECTRICAL SCHEDULES

DRAWING TITLE

COVER SHEET

JOB NUMBER: 1680

MISCELLANEOUS RENOVATIONS
NEW FIRST FLOOR TOILET ROOM
AND SHOWER ROOM
UNION STATION
WORCESTER, MA

CONSULTANT

ARCHITECT

NAULT ARCHITECTS, INC.


71 HOPE AVENUE
WORCESTER, MA 01603

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FAX: (508) 754-4661

DRAWING NO.

JUNE 2022

AS NOTED

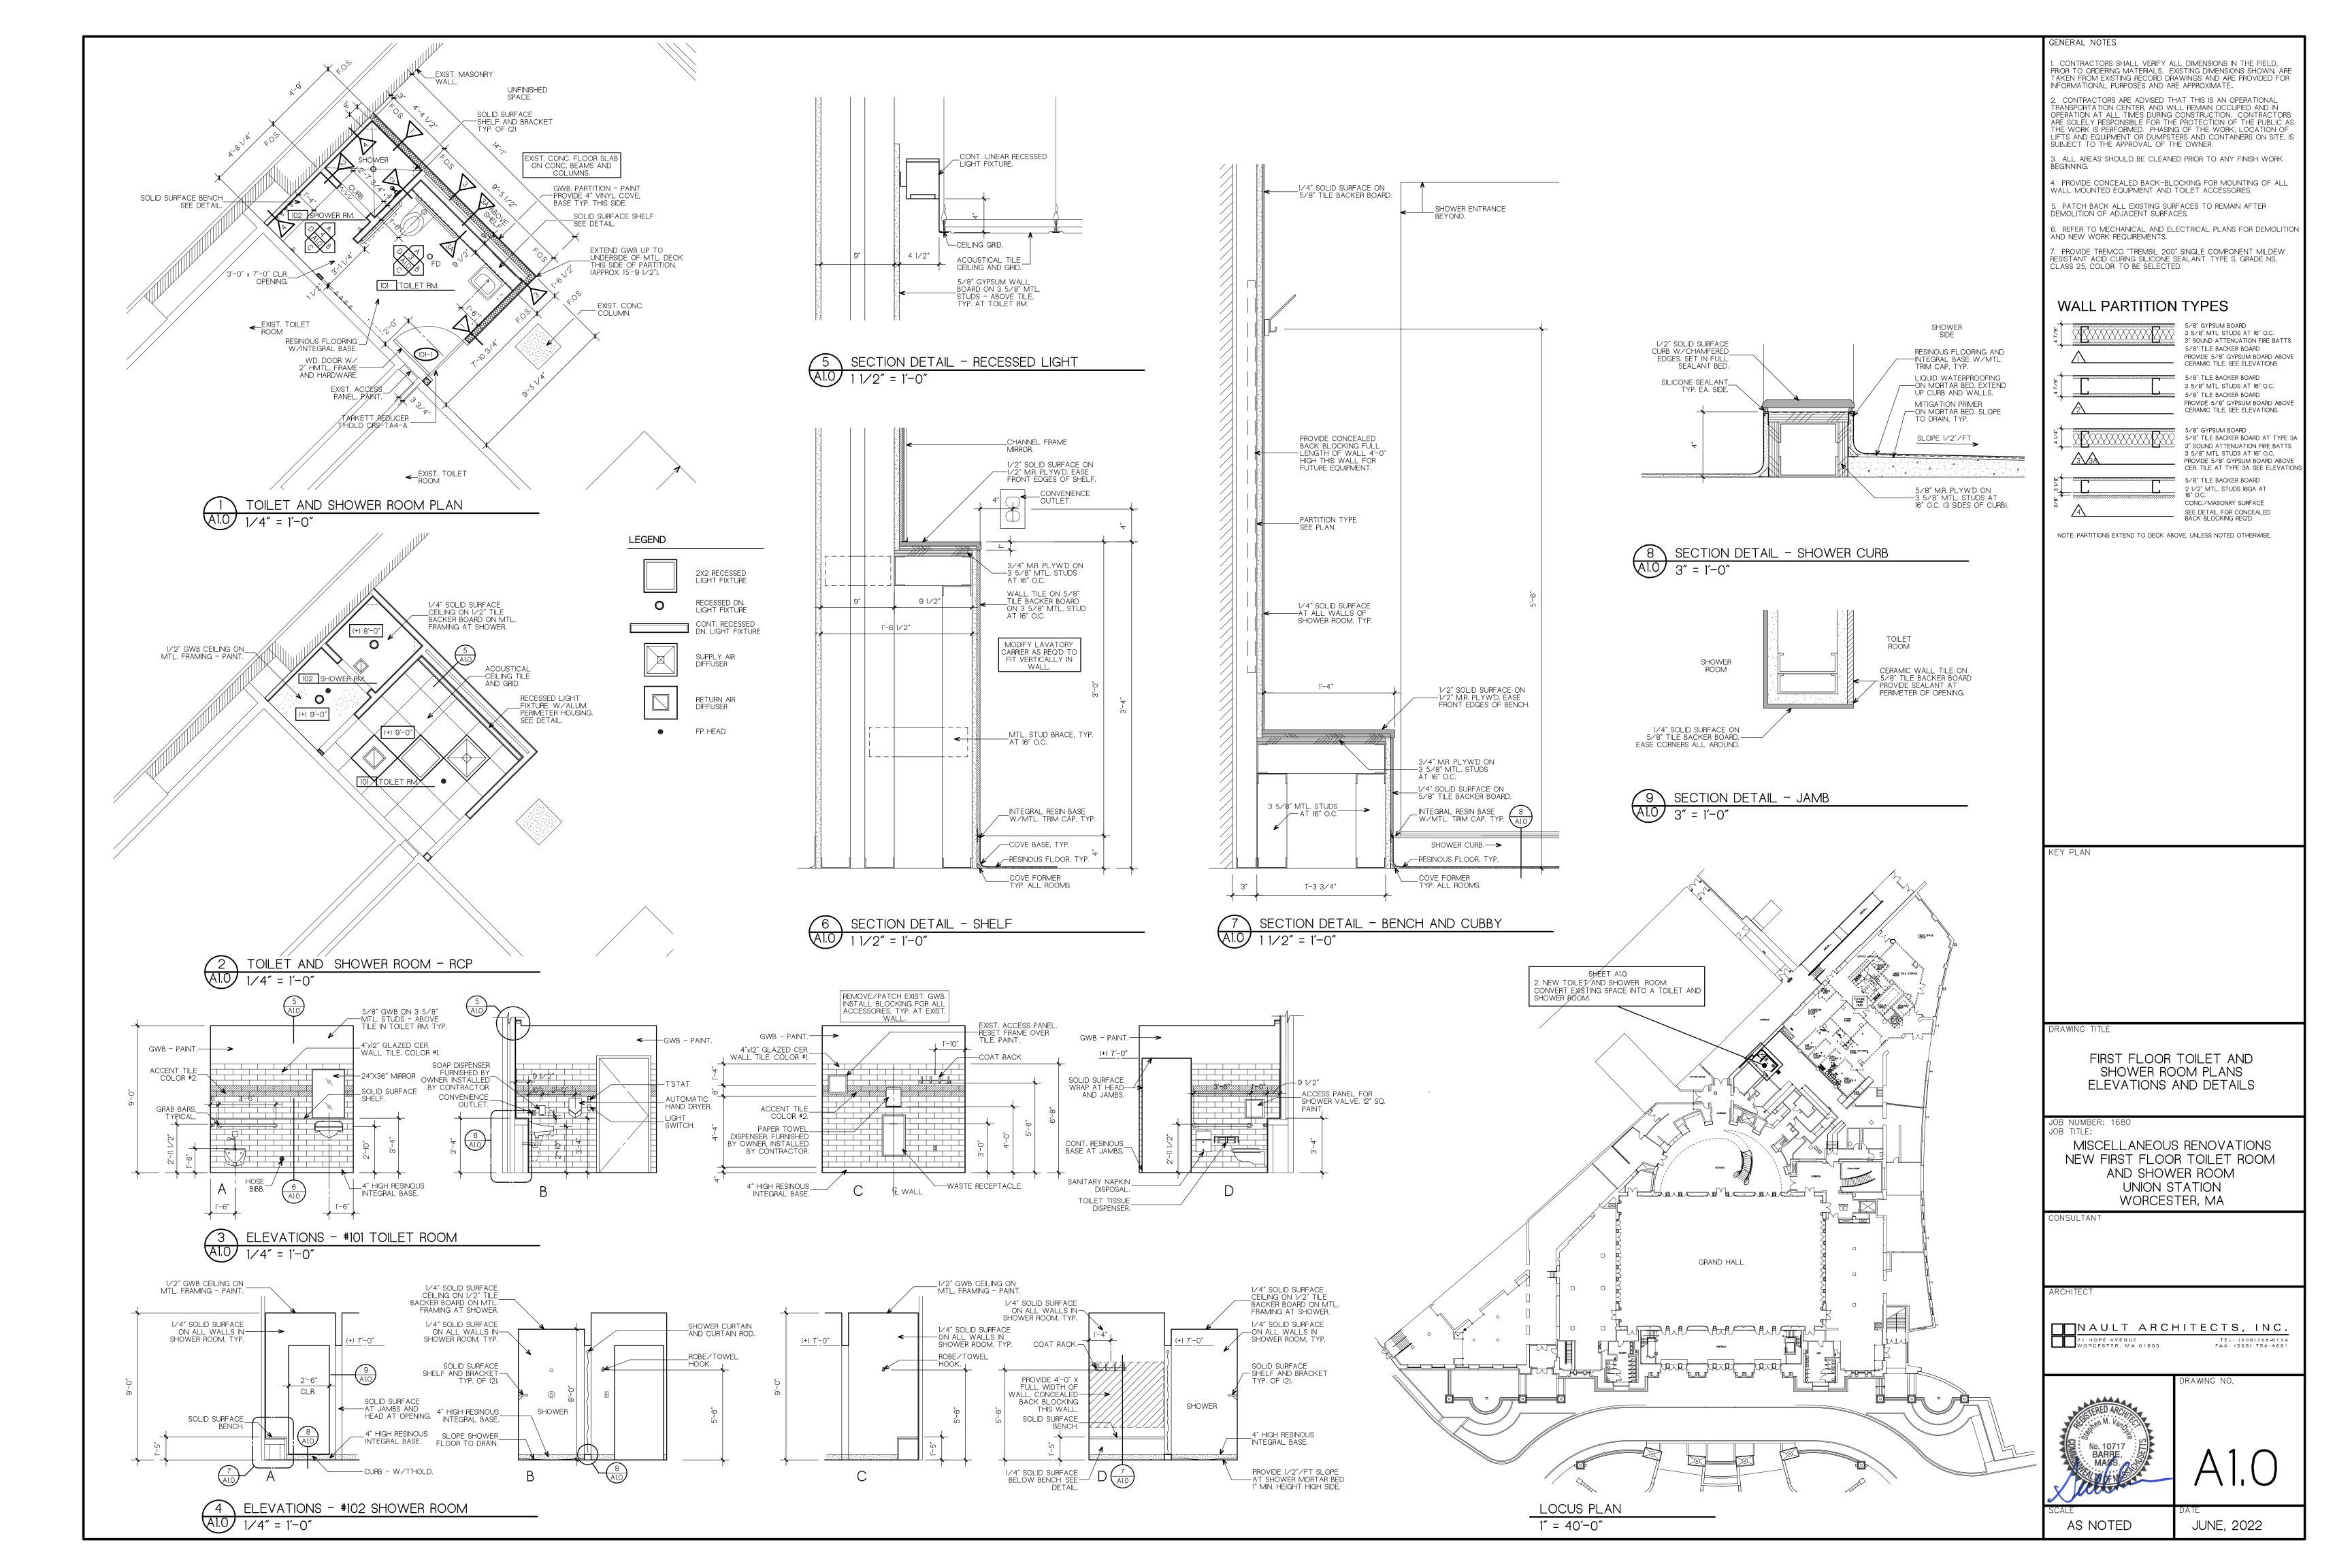

FIRE PROTECTION LEGEND & SYMBOLS

ABBREVIATIONS & SYMBOLS	<u>PIPING</u>
AFF ABOVE FINISHED FLOOR AFG ABOVE FINISHED GRADE AHU AIR HANDLING UNIT AP ACCESS PANEL BFF BELOW FINISHED FLOOR BFP BACKFLOW PREVENTER BHP BRAKE HORSEPOWER BOD BOTTOM OF DUCT BOP BOTTOM OF PIPE BTUH BTU PER HOUR CAP CAPACITY CL CENTERLINE CLG CEILING CO CLEANOUT CONN CONNECTION CTE CONNECT TO EXISTING DIA DIAMETER DN DOWN DWG DRAWING ERH EXTERIOR ROOF HYDRANT EXIST EXISTING	EXISTING WORK TO REMAIN EXISTING WORK TO BE REMOVED ON DEMOLITION DRAWINGS NEW WORK ON PROPOSED DRAWINGS FIRE PROTECTION PIPING
ETR EXISTING TO REMAIN FCO FLOOR CLEANOUT FD FLOOR DRAIN OR FIRE DAMPER FDC FIRE DEPARTMENT CONNECTION FDV FIRE DEPARTMENT CONNECTION FDV FIRE DEPARTMENT HOSE VALVE FLA FULL LOAD AMPS FM FLOW METER OR FACTORY MUTUAL FMS FACILITY MANAGEMENT SYSTEM FP FIRE PROTECTION FT FEET G GAS GC GENERAL CONTRACTOR GPH GALLONS PER HINUTE HD HEAD HD HORSEPOWER OR HEAT PUMP HS HOSE STATION HZ HERTZ ID INSIDE DIAMETER LOS POUNDS LWCO LOW WATER CUT OFF MC MECHANICAL CONTRACTOR MCA MINIMUM CIRCUIT AMPACITY MOCP MAXIMUM OVERCURRENT PROTECTION MTD MOUNTED NC NORMALLY CLOSED NATURAL GAS NIC NOT IN CONTRACT NO NORMALLY OPEN NTS NOT TO SCALE PAV PRE—ACTION VALVE PSI POUNDS PER SQUARE INCH PSIC POUNDS PER SQUARE INCH PSIC POUND PER SQUARE	PIPE TURNING DOWN (PIPE DROP) PIPE TURNING UP (PIPE RISE) TEE UP (OFF TOP) TEE DOWN (OFF BOTTOM) PIPE DROP IN RUN PIPE DROP AND TURN TEE OFF TOP TEE OFF BOTTOM CROSS CROSS WITH RISER PLAIN ELBOW PLAIN TEE (OFF SIDE) CONCENTRIC REDUCER UNION PIPE CAP THEADED JOINT PIPE CAP THEADED HOSE END WITH CAP PIPE GUIDE PIPE ANCHOR WALL SLEEVE
	FLEX CONNECTION PRESSURE GAUGE BACKFLOW PREVENTER

VALVES

— CHECK ——─── GATE PRESSURE REGULATING OR REDUCING ——FCVA—— FLOW CONTROL VALVE ASSEMBLY

SPRINKLER SYMBOLS

── WET PENDENT, CONCEALED SPRINKLER ₩ET PENDENT, SEMI-RECESSED SPRINKLER ——— DRY PENDENT, CONCEALED SPRINKLER DRY PENDENT, SEMI-RECSSED SPRINKLER WET HORIZONTAL SIDEWALL SPRINKLER $\overline{\hspace{1cm}}$ DRY HORIZONTAL SIDEWALL SPRINKLER WET UPRIGHT SPRINKLER DRY UPRIGHT SPRINKLER

GENERAL NOTES

- 1. THE SPRINKLER LAYOUT AND PIPE SIZES SHOWN ON THE FIRE PROTECTION DESIGN DOCUMENTS ARE TO DEFINE THE DESIGN INTENT FOR COMPETITIVE BIDDING AND FOR PRELIMINARY SUBMISSION TO THE AUTHORITIES HAVING
- 2. THE WORK OF THE FIRE PROTECTION CONTRACTOR'S CONTRACT SHALL INCLUDE HYDRAULIC CALCULATIONS AND SPRINKLER SYSTEM SHOP DRAWINGS INDICATIVE OF THE ACTUAL FIELD INSTALLED CONDITIONS. SPRINKLER SHOP DRAWINGS SHALL BE PREPARED BY THE FIRE PROTECTION CONTRACTOR AND SUBMITTED TO THE ENGINEER FOR APPROVAL PRIOR TO ANY SPRINKLER WORK BEGINNING IN THE FIELD. IT IS REQUIRED THAT SPRINKLER SYSTEMS BE SIZED HYDRAULICALLY IN ACCORDANCE WITH NFPA STANDARDS. ALL HYDRAULIC CALCULATIONS PREPARED AND SUBMITTED BY THE FIRE PROTECTION CONTRACTOR FOR REVIEW SHALL BEAR THE SEAL AND SIGNATURE OF A REGISTERED PROFESSIONAL ENGINEER.
- 3. THE FIRE PROTECTION CONTRACTOR SHALL LOCATE SPRINKLERS AS REQUIRED IN THESE DOCUMENTS AND PER THE REFERENCED NFPA 13 STANDARDS UTILIZING ARCHITECT'S REFLECTED CEILING PLAN, AS NECESSARY, FOR LOCATIONS OF LIGHTS, DIFFUSERS, ETC. 4. IT IS NOT THE INTENTION THAT THESE DRAWINGS DEPICT EVERY DEVICE

REQUIRED FOR A COMPLETE SYSTEM. ALL SUCH ITEMS SHALL BE PROVIDED

AS MAY BE NECESSARY TO PROVIDE A COMPLETE FIRE PROTECTION SYSTEM, TO THE SATISFACTION OF THE ENGINEER AND AUTHORITY HAVING JURISDICTION. 5. NEW WET PIPE SPRINKLER SYSTEM SHALL BE HYDRAULICALLY SIZED TO NFPA

13 (2013) STANDARDS FOR LIGHT HAZARD WITH A DENSITY OF 0.15 GPM/SQ-FT OVER THE MOST REMOTE 1500SQ-FT.

KEY PLAN

KEY PLAN NOT TO SCALE


FIRE PROTECTION LEGEND AND ABBREVIATIONS

JOB TITLE:

MISCELLANEOUS RENOVATIONS NEW FIRST FLOOR TOILET ROOM AND SHOWER ROOM UNION STATION

Mansfield, MA 02048 Tel: 508.821.9759 www.Hallam-ICS.com

NAULT ARCHITECTS, INC.

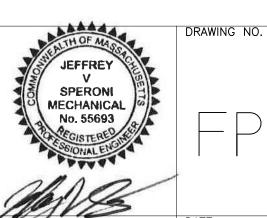

JUNE, 2022

GENERAL NOTES

DRAWING TITLE

JOB NUMBER: 1680

WORCESTER, MA

AN EMPLOYEE OWNED COMPANY 575 West Street, Suite 220

GENERAL NOTES

 NEW WET PIPE SPRINKLER SYSTEM SHALL BE HYDRAULICALLY SIZED TO NFPA 13 (2013) STANDARDS FOR LIGHT HAZARD WITH A DENSITY OF 0.15 GPM/SQ-FT OVER THE MOST REMOTE 1500SQ-FT.

MOST REMOTE 1500SQ-FT.

2. SPRINKLER AND PIPING LAYOUT SHOWN SHALL BE USED FOR ESTIMATING PURPOSES ONLY. FINAL SYSTEM DESIGN MUST BE CALCULATED, LAID OUT IN ACCORDANCE WITH THE ABOVE SPECIFICATIONS AND SUBMITTED FOR APPROVAL.

3. COORDINATE SPRINKLER LOCATIONS WITH ELECTRICAL AND MECHANICAL CONTRACTORS. PENDANT TYPE SPRINKLER HEADS SHALL BE INSTALLED IN THE CENTER OF CEILING TILES.

KEYED NOTES: 1 EXISTING SPRINKLER TO REMAIN.

2. NEW CONCEALED PENDANT SPRINKLER WITH WHITE COVER.

KEY PLAN

KEY PLAN NOT TO SCALE

DRAWING TITLE

FIRE PROTECTION NEW WORK PLAN

JOB NUMBER: 1680 JOB TITLE:

MISCELLANEOUS RENOVATIONS
NEW FIRST FLOOR TOILET ROOM
AND SHOWER ROOM
UNION STATION
WORCESTER, MA

Hallam ICS
AN EMPLOYEE OWNED COMPANY


575 West Street, Suite 220 Mansfield, MA 02048 Tel: 508.821.9759 www.Hallam-ICS.com

RCHITECT

NAULT ARCHITECTS, INC.

71 HOPE AVENUE
WORCESTER, MA 01603

TEL: (508) 755-6134
FAX: (508) 754-4661

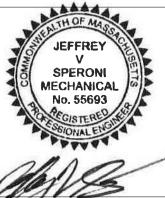

DRAWING NO.

FP1.0

DATE
JUNE, 2022

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POLYETHYLENE ——── AUTOMATIC FLOW CONTROL CROSS LINKED POLYETHYLENE PROPELLER FAN PROPANE GAS OR PROPYLENE GLYCOL BALL OR BUTTERFLY (SIZE POLYPROPYLENE DEPENDENT) POWER ROOF EXHAUST PRESSURE REDUCING VALVE ——— CHECK POWER WALL EXHAUSTER POUNDS PER SQUARE INCH POUND PER SQUARE INCH GAUGE ———Ø——— BALANCING RETURN AIR **ROOF DRAIN** RELATIVE HUMIDITY ——─── GATE **ROOFTOP UNIT** RETURN REGISTER SUPPLY AIR SMOKE DAMPER OR SUPPLY DIFFUSER SUPPLY FAN ——

→ PLUG SHOWER SQUARE INLINE CENTRIFUGAL STATIC PRESSURE PRESSURE REGULATING OR REDUCING SUPPLY REGISTER STAINLESS STEEL TRANSFER AIR RELIEF TESTING, ADJUSTING & BALANCING TRENCH DRAIN ANGLE PATTERN MULTI PURPOSE PUMP TRANSFER GRILLE TUBULAR INLINE CENTRIFUGAL DISCHARGE THERMOSTATIC MIXING VALVE STRAIGHT PATTERN MULTI PURPOSE TOP OF DUCT TOTAL STATIC PRESSURE PUMP DISCHARGE **TYPICAL** ────── VALVE IN TEE DROP UNDERCUT DOOR UNDERGROUND UNIT HEATER ————— VALVE IN TEE RISE URINAL UTILITY SINK VENT VALVE IN ELBOW DROP VARIABLE AIR VOLUME VACUUM BREAKER VALVE IN ELBOW RISE VOLUME DAMPER VARIABLE FREQUENCY DRIVE VENT THROUGH ROOF 2-WAY CONTROL (ELECTRONIC) WET BULB WATER CLOSET OR WATER COLUMN WALL CLEANOUT — 2-WAY CONTROL (PNEUMATIC) WATER GAUGE WATER HEATER **EXPLOSION PROOF** 3-WAY CONTROL (ELECTRONIC) NEW CONNECTION TO EXISTING 3-WAY CONTROL (PNEUMATIC)

VALVES

FITTINGS PIPING EXPANSION JOINT ----- EXISTING WORK TO REMAIN EXISTING WORK TO BE REMOVED ON PIPE TURNING DOWN (PIPE DROP) DEMOLITION DRAWINGS PIPE TURNING UP (PIPE RISE) $\overline{}$ NEW WORK ON PROPOSED DRAWINGS TEE UP (OFF TOP) ----- CD ----- CONDENSATE DRAIN TEE DOWN (OFF BOTTOM) GAS PIPING PIPE DROP IN RUN —— FOF —— FUEL OIL FILL PIPE DROP AND TURN FOS FUEL OIL SUPPLY TEE OFF TOP ——— FOR ——— FUEL OIL RETURN TEE OFF BOTTOM FUEL OIL VENT PLAIN ELBOW FIRE PROTECTION SPRINKLER SANITARY ELBOW TEPID WATER PLAIN TEE (OFF SIDE) ——— CW ——— DOMESTIC COLD WATER SANITARY TEE (OFF SIDE) CONCENTRIC REDUCER ——— HWC ——— DOMESTIC HOT WATER RECIRC. -ECCENTRIC REDUCER SANITARY DRAIN UNION SANITARY DRAIN BELOW FLOOR FLANGED JOINT — V — SANITARY VENT PIPE CAP ——— ST ——— STORM DRAIN THREADED HOSE END WITH CAP ——— ST ——— STORM DRAIN BELOW FLOOR —— ST (SEC) —— SECONDARY STORM DRAIN METAL GASKET FACE SEAL PIPE GUIDE — D — INDIRECT DRAIN PIPE ANCHOR ——— NPW ——— NON POTABLE WATER WALL SLEEVE —— NPHW —— NON POTABLE HOT WATER FLEX CONNECTION _____ DIRECTION OF FLOW PRESSURE GAUGE PITCH PIPE DOWN TEMPERATURE GAUGE ——— CA ——— COMPRESSED AIR MANUAL AIR VENT PUMP DIFFERENTIAL PRESSURE TP TRAP PRIMER _____T______TEST PLUG WATER FILTER HOUSING AND CARTRIDGE WYE STRAINER W/BLOWDOWN BASKET STRAINER PUMP SUCTION DIFFUSER ____ VACUUM BREAKER BACKFLOW PREVENTER WALL HYDRANT (ELEVATION) WALL HYDRANT (PLAN VIEW) CLEANOUT END OF LINE

TRAP

——эо

FLOOR CLEANOUT

GENERAL NOTES

KEY PLAN

KEY PLAN NOT TO SCALE

DRAWING TITLE

PLUMBING LEGEND AND ABBREVIATIONS


JOB NUMBER: 1680 JOB TITLE:

MISCELLANEOUS RENOVATIONS NEW FIRST FLOOR TOILET ROOM AND SHOWER ROOM UNION STATION WORCESTER, MA

CONSULTANT AN EMPLOYEE OWNED COMPANY 575 West Street, Suite 220

> Mansfield, MA 02048 Tel: 508.821.9759 www.Hallam-ICS.com

MNAULT ARCHITECTS, INC.

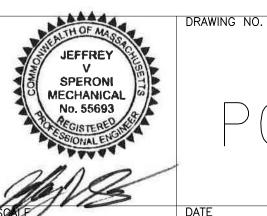


AS NOTED

JUNE, 2022

PD

PRESSURE DROP



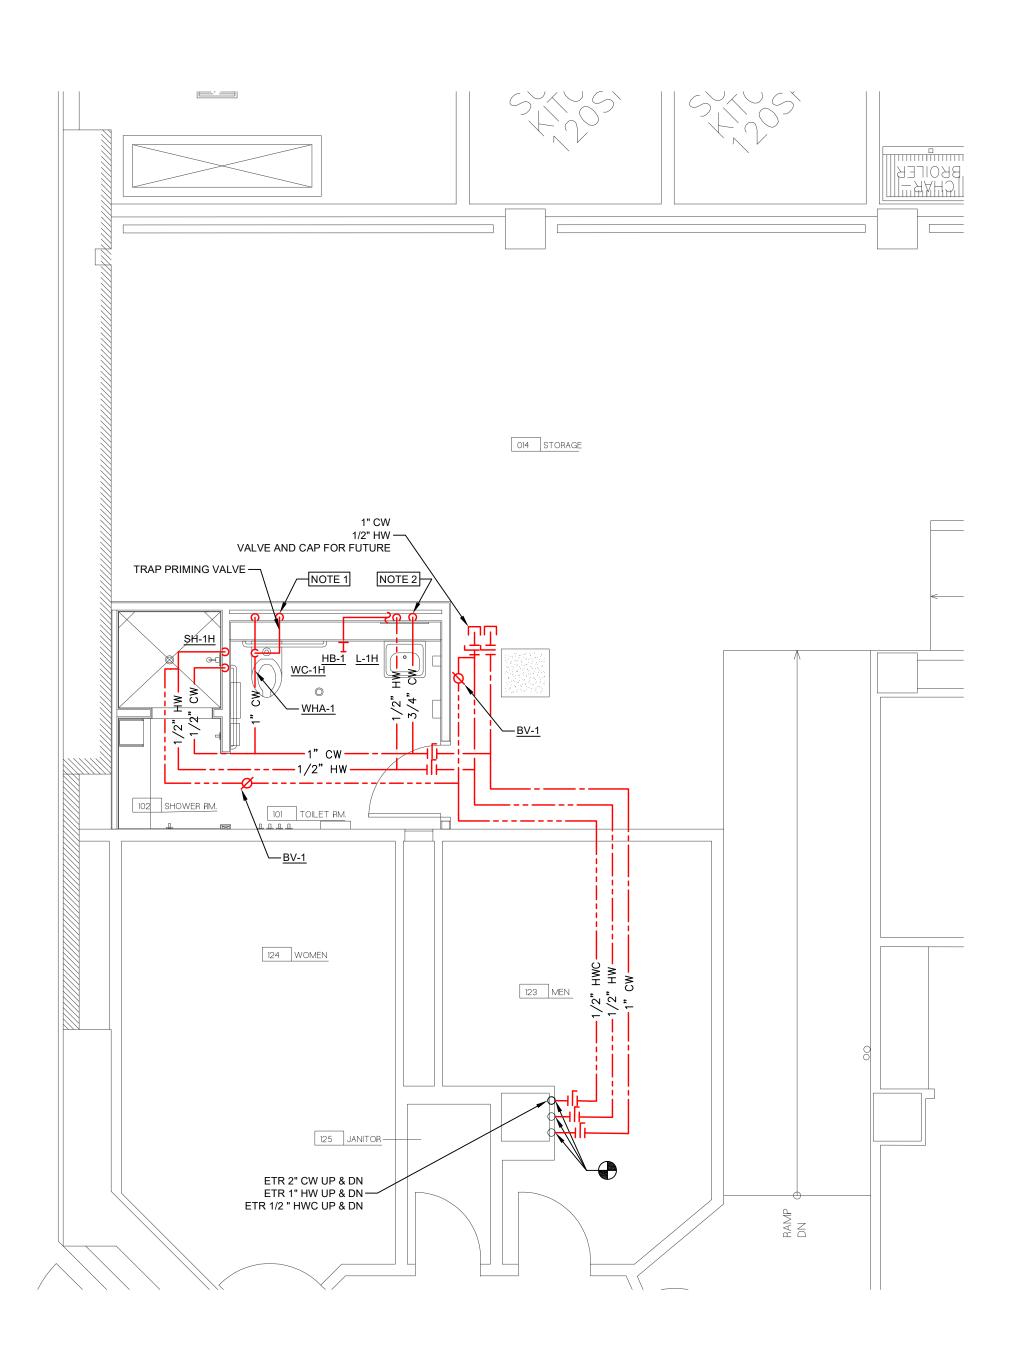

DOMESTIC WATER PLAN - NEW WORK
SCALE: 1/4"=1'-0"

GENERAL NOTES IF NECESSARY MODIFY WATER CLOSET CARRIER TO FIT BELOW SHELF SEE SECTION 6 ON A1.0.
 IF NECESSARY MODIFY LAVATORY CARRIER TO FIT BELOW SHELF SEE SECTION 6 ON A1.0.

KEY PLAN

KEY PLAN NOT TO SCALE DRAWING TITLE

PLUMBING PLAN

JOB NUMBER: 1680 JOB TITLE:

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NAULT ARCHITECTS, INC. TEL: (508)755-6134 FAX: (508) 754-4661



AS NOTED

DRAWING NO.

JUNE, 2022

							PLUN	1BING	FIXTURE SCHEDULE	
TAG NO.	DESCRIPTION	DESIGN BASIS	MOUNTING		CC	ONNECTIONS	(in)		ACCESSORIES & FEATURES REMARKS	NOTES
				HW	CW	TW	W	V		
WC-1H	WATER CLOSET, WALL MOUNTED W/ MANUAL FLUSHOMETER	AMERICAN STANDARD AFWALL FLOWISE 3351.128	WALL	-	1"	-	4"	2"	CHURCH #9500 CT OPEN FRONT ELONGATED SEAT, SLOAN ROYAL #111-1.28 MANUAL FLUSH VALVE RATED FOR 1.28 GPF	1,2
						-				
L-1H	LAVATORY, ROUND UNDERCOUNTER, SINGLE LEVER MANUAL FAUCET	AMERICAN STANDARD MURRO 0954.004EC	WALL	1/2"	1/2"	-	1-1/2"	1-1/2"	SYMMONS #S-60-G METERING FAUCET WITH GRID STRAINER -	1,2
SH-1	ADA SHOWER	SYMMONS S9608PLRTRM	WALL	1/2"	1/2"		2"	1-1/2"	ENCLOSURE BY ARCHITECT	1,2
FD-1	FLOOR DRAIN	ZURN Z415B	FLOOR	-	-	-	2"	1-1/2"		
FD-2	FLOOR DRAIN	ZURN Z415N	FLOOR	-	-	-	2"	1-1/2"	SHOWER DRAIN	
HB-1	HOSE BIBB	ZURN Z1333	WALL	-	3/4"	-	-	-	INTERIOR WALL INSTALLATION WITH STAINLESS STEEL FACE AND OPERATING KEY.	


NOTES

1. REFER TO ARCHITECTURAL DRAWINGS FOR FIXTURE HEIGHTS AND FLUSH VALVE HEIGHTS WHERE APPLICABLE.

2. INSULATE DRAIN AND WATER SUPPLIES PER ADA REQUIREMENTS.

	MFR MODEL OPEN CLOSED											
TACNO	NO. SIZE (IN.) CLOSING TEMPERATURE (°F) MFR MODEL OPEN CLOSED REMARKS											
TAG NO.	SIZE (IIV.)	TEMPERATURE (°F)	MFR	MODEL	OPEN	CLOSED	KEWAKKS					
BV-1	1/2	120	CIRCUITSOLVER	CSUAS-1/2-120-CV1	1.3	0.2	BALANCING VALVE, STRAINER AND SHUT-OFF VALVE ASSEMBLY					

		WATER H	AMMER AR	RESTC	RS SCHEDULE	
TACNO	SIZE (IN.)	DESI	GN BASIS	FIXTURE	DEMADIZE	
TAG NO.	SIZE (IIV.)	MFR	MODEL	UNITS	REMARKS	
WHA-1	3/4	PPP	SC-750B	11.5		

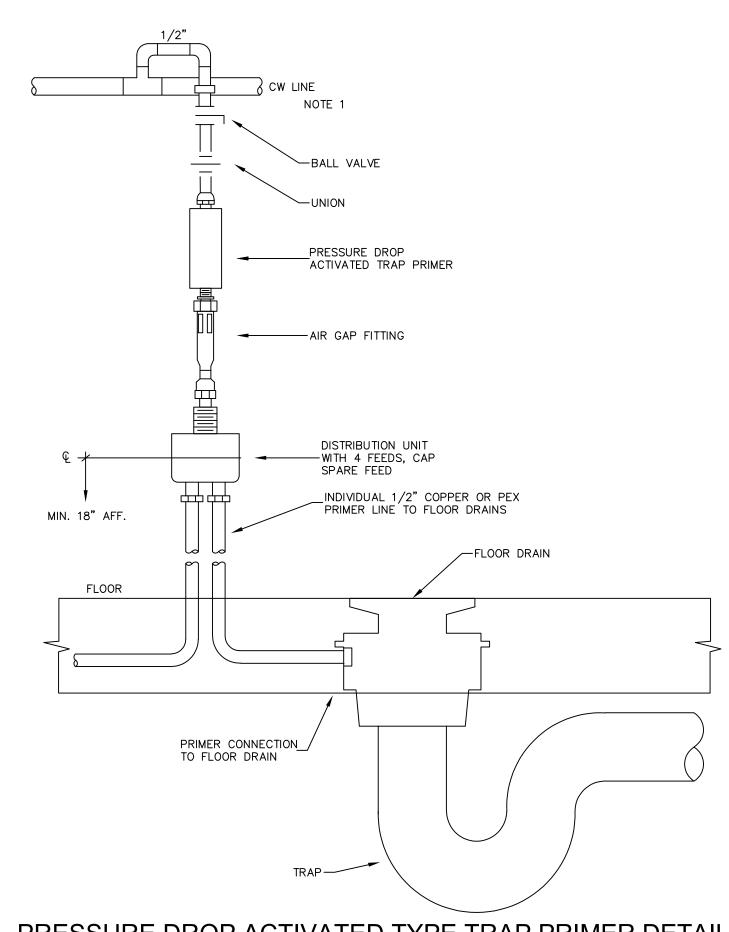

PRESSURE DROP ACTIVATED TYPE TRAP PRIMER DETAIL
SCALE: NONE

 CW LINE MUST BE FREQUENTLY USED AND PRODUCING MINIMUM 10 PSI PRESSURE DROP ON USAGE TO ACTIVATE PRIMER.

NOTES:

KEY PLAN KEY PLAN NOT TO SCALE DRAWING TITLE PLUMBING DETAILS AND SCHEDULES JOB NUMBER: 1680 JOB TITLE: MISCELLANEOUS RENOVATIONS NEW FIRST FLOOR TOILET ROOM AND SHOWER ROOM UNION STATION WORCESTER, MA AN EMPLOYEE OWNED COMPANY 575 West Street, Suite 220 Mansfield, MA 02048 Tel: 508.821.9759 www.Hallam-ICS.com NAULT ARCHITECTS, INC. TEL: (508)755-6134 FAX: (508) 754-4661 SPERONI MECHANICAL No. 55693 DRAWING NO.

JUNE, 2022

GENERAL NOTES

KEY PLAN

GENERAL NOTES

KEY PLAN NOT TO SCALE

DRAWING TITLE

MECHANICAL LEGEND AND ABBREVIATIONS

JOB NUMBER: 1680 JOB TITLE:


> MISCELLANEOUS RENOVATIONS NEW FIRST FLOOR TOILET ROOM AND SHOWER ROOM UNION STATION WORCESTER, MA

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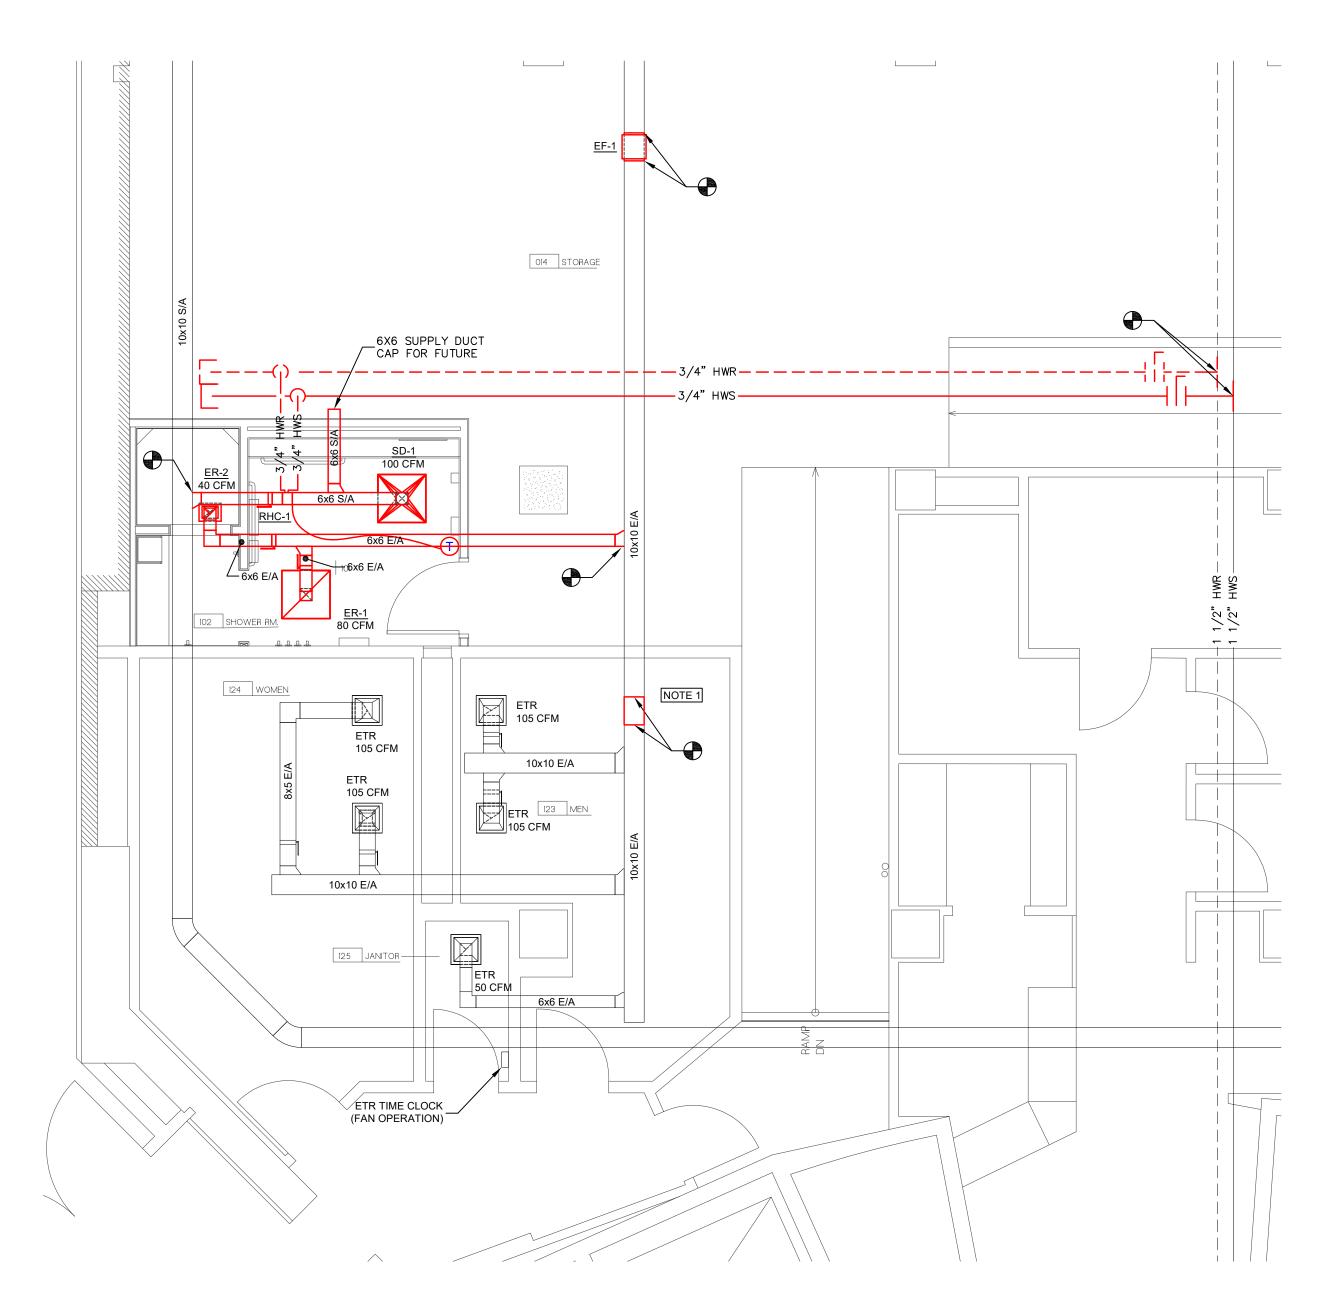


AS NOTED

JUNE, 2022

DRAWING NO.

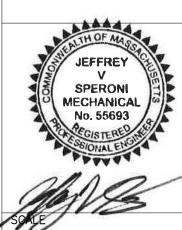



HVAC DUCTWORK & PIPING- NEW WORK SCALE: 1/4"=1'-0"

GENERAL NOTES KEYED NOTES

1. REMOVE EXISTING FAN AND REPLACE WITH DUCT. KEY PLAN KEY PLAN NOT TO SCALE DRAWING TITLE HVAC DUCTWORK DEMO AND NEW WORK JOB NUMBER: 1680 JOB TITLE:

JEFFREY
V
SPERONI
MECHANICAL
No. 55693
CGISTERES
SOIONAL ELICITION

<u>| | 1 (</u>

DRAWING NO.

TEL: (508)755-6134 FAX: (508) 754-4661

DATE
AS NOTED JUNE, 2022

MISCELLANEOUS RENOVATIONS
NEW FIRST FLOOR TOILET ROOM
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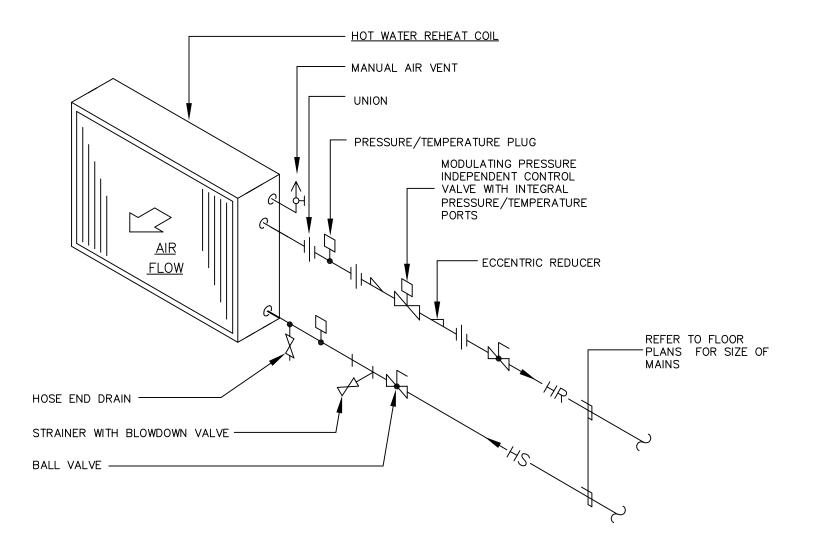
NAULT ARCHITECTS, INC.

					FAN S	CHEDULE	=							
FAN NO.	LOCATION	SERVES	DESIGN BASIS	FAN TYPE	WHEEL SIZE/TYPE	FLOW SETPOINT (CFM)	FUTURE FLOW	SP (IN)	RPM	MAX (dBA)		MOTOR		REMARKS
						(0)	(CFM)				HP	VOLTS	PH	
EF-1	RN 014	BATHROOMS 101,124,125 &123	GREENHECK SQ-99-VG	INLINE		590	781	0.9	1,932	69	3/4	120	1	DIRECT DRIVE ECM MOTOR


NOTES: 1. AIR FLOW QUANTITIES ARE NOMINAL AND INCLUDE AN ALLOWANCE FOR LEAKAGE. FINAL BALANCING MUST BE BASED ON ACTUAL AIR FLOWS. 2. RPM AND BHP MAY VARY BY NO MORE THAN 10% FROM INDICATED VALUE.

		DIFFUSER, REGISTER	AND GRI	LLE SCHE	DULE			
PLAN SYMBOL	DESCRIPTION	DESIGN BASIS	NECK SIZE	CFM RANGE	ACCESSORIES	REMARKS		
SD-1	CEILING S/A DIFFUSER (DIRECTIONAL FACE STYLE)	METAL AIRE SERIES 5500 4-WAY BLOW UNLESS OTHERWISE NOTED ON PLAN	6x6	0-125	OBD, 24x24 FACE PANEL, 6"x6" NECK TRANSITION	COLOR AND BORDER TYPE TO BE COORDINATED WITH ARCHITECT PRIOR TO ORDERING		
ER-1	CEILING R/A OR E/A REGISTER (CUBE CORE STYLE)	Y I METALAIDE MODEL COED I 6v6 I 0.1		0-100	OBD, 24x24 FACE PANEL, 6"x6" NECK TRANSITION	COLOR AND BORDER TYPE TO BE COORDINATED WITH ARCHITECT PRIOR TO ORDERING		
ER-2		METAL AIRE MODEL CC5S	6x6	0-100	OBD, 8x6 FACE PANEL, 6"x6" NECK TRANSITION	COLOR AND BORDER TYPE TO BE COORDINATED WITH ARCHITECT PRIOR TO ORDERING		

	COIL SCHEDULE															
EQUIPMENT NUMBER				AIR SIDE						WATER SIDE						
	LOCATION	SERVICE	CAPACITY (CFM)	FUTURE CAPACITY (CFM)	MAX. FACE VELOCITY (FPM)	MAX. AIR PRESS. DROP (IN W.G.)	TOTAL COIL CAPACITY (MBH)	ENTERING AIR TEMP. (°F)	LEAVING AIR TEMP. (°F)	COIL SIZE (IN)	FLUID TYPE	ENTERING WATER TEMP. (°F)	LEAVING WATER TEMP. (°F)	FLOW RATE (GPM)	MAX FLUID PRESS. DROP (FT.)	REMARKS
RHC-1	RESTROOM 101	101	100	200	400	0.30	9.1	55	95	6x6	HOT WATER	180	160	0.9	0.3	



HEATING HOT WATER COIL PIPING DETAIL SCALE: NONE

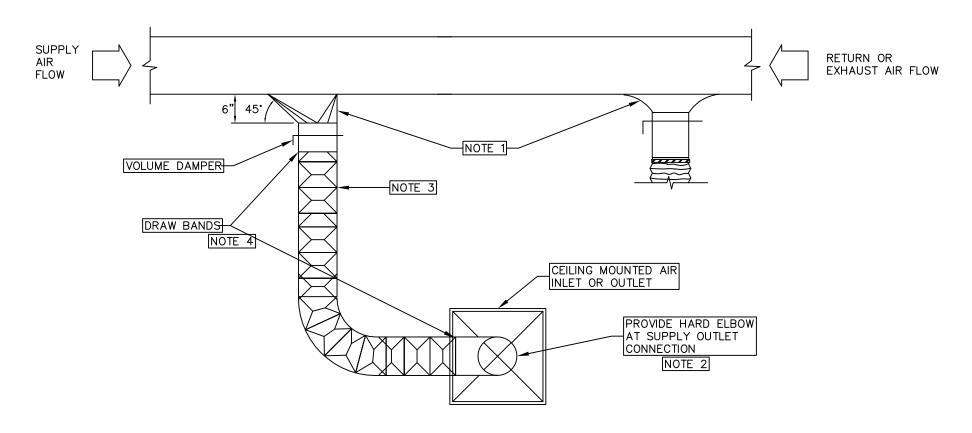


CEILING MOUNTED SUPPLY/RETURN/EXHAUST INLET AND OUTLET CONNECTION DETAIL

SCALE: NONE NOTES:

1. AT CONTRACTORS OPTION, CONTRACTOR MAY USE TRANSITION TYPE TAKE-OFF OR" BELL MOUTH" TYPE TAKEOFF WITH GASKET SEAL.

- 2. ELBOW MUST BE FULL RADIUS TYPE. WHERE BRANCH DUCT IS 18" OR MORE ABOVE DIFFUSER, USE 45° ELBOW OR MIN. 9" STRAIGHT DUCT AT OUTLET CONNECTION, OTHERWISE PROVIDE 90° ELBOW.
- 3. PROVIDE FLEXIBLE DUCT ON SUPPLY AND RETURN CONNECTIONS, 6' MAX. LENGTH WITH BEND FOR ADDED SOUND ATTENUATION. EXHAUST CONNECTIONS MUST BE HARD CONNECTED.
- 4. PROVIDE DRAWBANDS AT BOTH INNER SLEEVE AND OUTER JACKET OF FLEXIBLE DUCTWORK CONNECTIONS.

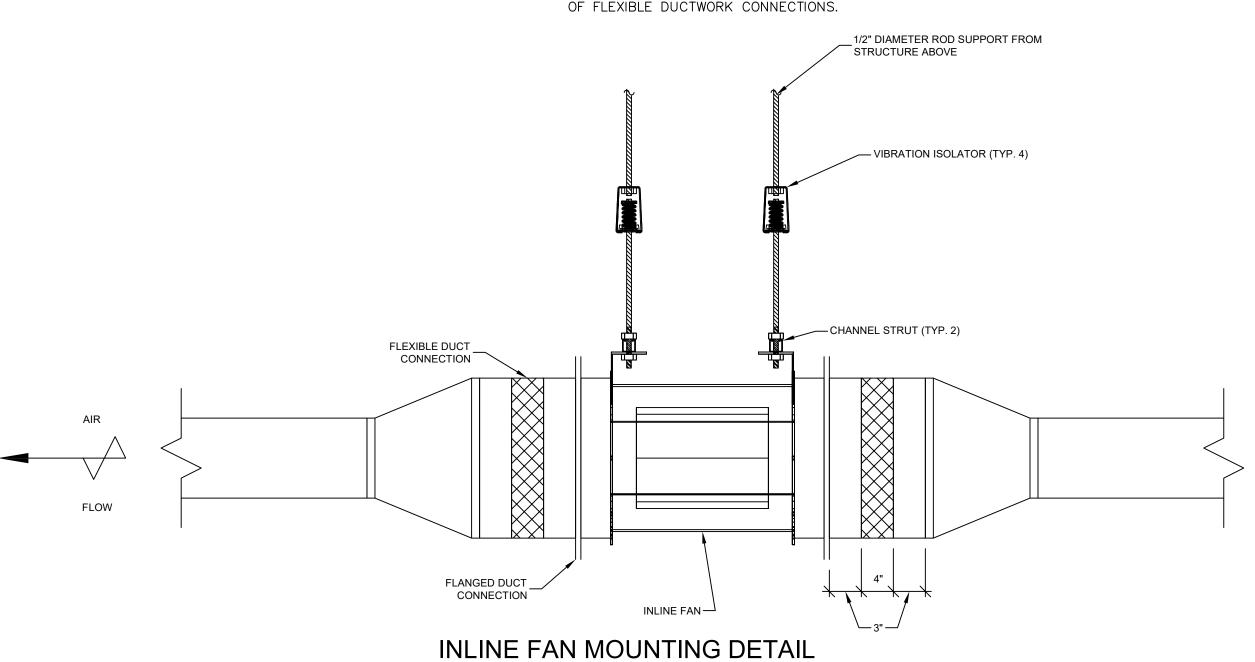

SCALE: NONE

KEY PLAN

KEY PLAN NOT TO SCALE

DRAWING TITLE

HVAC SCHEDULE AND DETAILS

JOB NUMBER: 1680 JOB TITLE:

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DRAWING NO.



JUNE, 2022

DUCT MOUNTED HOT WATER COIL SEQUENCE OF OPERATION:

5*F(ADJ) FOR GREATER THAN 30 MINUTES (ADJ).

1. THE WALL MOUNTED TEMPERATURE SENSOR MEASURES THE SPACE TEMPERATURE. IF THE SPACE TEMPERATURE IS BELOW SETPOINT OF

70*F (ADJ) THE REHEAT COIL VALVE SHALL MODULATE OPEN. IF THE

SPACE TEMPERATURE IS ABOVE SETPOINT, THE VALVE SHALL CLOSE. THE ROOM SHALL HAVE A 2*F DEADBAND. THE BMS SHALL ASSERT

AN ALARM WHEN THE SPACE IS ABOVE OR BELOW SETPOINT BY

MOTORS & EQUIPMENT

MOTOR. REFER TO MOTOR CIRCUIT SCHEDULE FOR ADDITIONAL INFORMATION.

FUSED DISCONNECT SWITCH

MOTOR STARTER COMBINATION MOTOR STARTER/DISCONNECT VARIABLE FREQUENCY DRIVE, FURNISHED AND INSTALLED BY HVAC CONTRACTOR, WIRED BY ELECTRICAL

CONTRACTOR MUSHROOM TYPE EMERGENCY SHUTDOWN SWITCH

AQUASTAT FURNISHED AND INSTALLED BY PLUMBING CONTRACTOR, WIRED BY ELECTRICAL CONTRACTOR

FIROMATIC

LIGHTING

1X4 SURFACE FIXTURE, LETTER DENOTES TYPE, SMALL LETTER DENOTES SWITCH LOOP 2X2 SURFACE FIXTURE, LETTER DENOTES TYPE, SMALL LETTER DENOTES SWITCH LOOP 2X4 SURFACE FIXTURE, LETTER DENOTES TYPE, SMALL LETTER DENOTES SWITCH LOOP 1X4 RECESSED FIXTURE, LETTER DENOTES TYPE, SMALL

LETTER DENOTES SWITCH LOOP 2X2 RECESSED FIXTURE, LETTER DENOTES TYPE, SMALL LETTER DENOTES SWITCH LOOP 2X4 RECESSED FIXTURE, LETTER DENOTES TYPE, SMALL LETTER DENOTES SWITCH LOOP

CEILING MOUNTED/RECESSED LIGHT FIXTURE, LETTER DENOTES TYPE, SMALL LETTER DENOTES SWITCH LOOP WALL MOUNTED FIXTURE, LETTER DENOTES TYPE, SMALL LETTER DENOTES SWITCH LOOP WALL MOUNTED LIGHT FIXTURE, LETTER DENOTES TYPE, SMALL LETTER DENOTES SWITCH LOOP

STRIP FIXTURE, LETTER DENOTES TYPE, SMALL LETTER DENOTES SWITCH LOOP EMERGENCY INDUSTRIAL LIGHT FIXTURE EMERGENCY LIGHT FIXTURE, LETTER DENOTES TYPE.

UNDER CABINET LIGHTING EMERGENCY LIGHTS, BATTERY BACKUP EMERGENCY LIGHTS, REMOTE BATTERY

EMERGENCY LIGHTS, REMOTE HEAD EXIT LIGHT, WALL MOUNTED, LETTER DENOTES TYPE SINGLE FACE EXIT LIGHT, CEILING MOUNTED, LETTER

DOUBLE FACE EXIT LIGHT, CEILING MOUNTED, LETTER DENOTES TYPE TRACK LIGHTING WITH FIXTURE HEAD BOLLARD LIGHT FIXTURE POLE LIGHT, SINGLE HEAD

POLE LIGHT, DOUBLE HEAD

LIGHT FIXTURE DESIGNATION DETAIL

UPPER CASE DENOTES

LIGHTING CONTROL

TIME CLOCK

PHOTOCELL

NOTES:

ROOM LIGHTING CONTROL LOCATION, REFER TO LIGHTING

DENOTES TYPE, 3=3-WAY, 4=4-WAY

2. NEUTRAL CONDUCTOR REQUIRED AT DEVICE PER N.E.C.

COMBINATION FLOOR BOXES

3. FOR LED DIMMING, PROVIDE ADDITIONAL 0-10V CONDUCTORS

RECESSED FLUSH, FIRE CLASSIFIED, COMBINATION FLOOR

TELECOMMUNICATION AND A/V ON THE OTHER BRACKETS.

WIREMOLD #RFB4-4DBIC, OR APPROVED EQUAL. BOX FOR

SLAB-ON-GRADE APPLICATION SHALL BE FURNISHED WITH

RECESSED FLUSH, FIRE CLASSIFIED, COMBINATION FLOOR

FURNITURE SYSTEM. PROVIDE (1) 1"C. FOR POWER, (1) 1

"SLAB-ON-GRADE APPLICATION SHALL BE FURNISHED WITH

BOX FOR POWER AND TELECOMMUNICATION FEED TO

1/4"C. FOR TELECOMMUNICATION WIRING. WIREMOLD

EPOXY COATING. PROVIDE FLANGED FURNITURE FEED

RECESSED 6" FIRE RATED POKE THRU FOR POWER AND

AND MOUNTING PROVISIONS FOR TELECOMMUNICATION.

RECESSED 6" FIRE RATED POKE THRU FOR POWER AND

RECESSED 6" FIRE RATED POKE THRU FOR POWER,

TELECOMMUNICATION CONNECTIONS TO FURNITURE SYSTEMS.

WIREMOLD #6ATCP, OR APPROVED EQUAL

WIREMOLD #6ATCFF, OR APPROVED EQUAL

TELECOMMUNICATIONS. PROVIDE (2) DUPLEX RECEPTACLES

#RIB4-4DBFCM OR APPROVED EQUAL. BOX FOR

BOX WITH (4) DUPLEX BRACKETS. PROVIDE WITH (2)

DUPLEX RECÉPTACLES AND PROVISIONS FOR

PROVIDE (1) 1"C. FOR POWER. (1) 1"C. FOR

EPOXY COATING. PROVIDE FLANGED COVER

TELECOMMUNICATIONS AND (1) 1 1/4"C. FOR A/V.

FAN/LIGHT COMBINATION

1. PROVIDE POWER PACKS AS NECESSARY.

BETWEEN DIMMER AND FIXTURES.

COVER ASSEMBLY.

APPROVED EQUAL

EMERGENCY LIGHTING SWITCHING RELAY

DENOTES SWITCHING

IM ISOLATION MODULE AUX AUXILIARY STROBE POWER SUPPLY

LOCATION AND REQUIREMENTS.

NOTES:

1. ALL DEVICES 15cd UNLESS NOTED OTHERWISE. 2. MOUNT DEVICES ON COMMON VERTICAL PLANE WITH OTHER DEVICES ON SAME SURFACE.

3. FIRE ALARM SYSTEM SHALL BE INSTALLED IN ACCORDANCE WITH LOCAL FIRE DEPARTMENT STANDARDS. ALL FIRE ALARM WIRING SHALL BE AS REQUIRED BY THE MANUFACTURER AND INSTALLED IN CONDUIT. FIRE ALARM MC CABLE MAY BE USED IF APPROVED BY THE LOCAL FIRE DEPARTMENT.

4. ELECTRICAL CONTRACTOR SHALL ENGAGE THE SERVICES OF THE EXISTING FIRE ALARM SYSTEM MANUFACTURER OR AUTHORIZED REPRESENTATIVE TO ASSIST WITH EXPANSION OF EXISTING SYSTEM AND RECALCULATING BATTERY SIZING.

5. PROVIDE POWER SUPPLY (QUANTITY AS REQUIRED) FOR NEW SPEAKER/STROBE CIRCUITS.

6. LOCATE DUCT SMOKE DETECTOR REMOTE TEST SWITCHES IN CEILING OR ADJACENT WALL NEAREST EQUIPMENT BEING SERVED.

8. FIRE ALARM SHOP DRAWING SUBMITTAL SHALL INCLUDE A RISER

DIAGRAM AND COMPLETED BATTERY CALCULATIONS. 9. BEFORE WIRING NEW OR RELOCATED FIRE ALARM DEVICES INTO EXISTING LOOPS, THE ELECTRICAL CONTRACTOR SHALL VERIFY CAPACITY FOR NEW DEVICES AND PROVIDE ANY ADDITIONAL SYSTEM COMPONENTS, WIRING OR PROGRAMMING REQUIRED TO INCORPORATE THE NEW/RELOCATED DEVICES INTO THE EXISTING

FIRE ALARM SYSTEM.

DATA/COMM DATA OUTLET, SUBSCRIPT DENOTES QUANTITY. 4" SQUARE BACK BOX WITH 1" CONDUIT TO ABOVE NEAREST

COMBINATION DATA/TELEPHONE OUTLET SUBSCRIPT DENOTES QUANTITY. 4" SQUARE BACK BOX WITH 1" CONDUIT TO ABOVE NEAREST ACCESSIBLE CORRIDOR

FLOOR MOUNTED DATA OUTLET FLOOR MOUNTED TELEPHONE OUTLET

ENVIRONMENTAL ALARM POINT

TELECOMMUNICATION AND A/V. WIREMOLD #6ATPAV, OR THERMOSTAT

RECESSED WALL TV/MONITOR SERVICE BOX. WIREMOLD #EFSB4, FOUR GANG BOX WITH DUPLEX RECEPTACLE, AND

FIRE ALARM

MANUAL FIRE PULL STATION SPEAKER STROBE LIGHT/SPEAKER HORN/LIGHT

LIGHT MAGNETIC HOLD HOLDERS REMOTE TEST STATION CHIME/STROBE LIGHT REMOTE ALARM INDICATOR

SMOKE DETECTOR, NO SUBSCRIPT PHOTOELECTRIC SUBSCRIPT I=IONIZATION SUBSCRIPT H=PHOTOELECTRIC w/135' HEAT DETECTION HEAT DETECTOR, SUBSCRIPT #=TEMPERTURE, R=RATE

CO DETECTOR DUCT MOUNTED SMOKE DETECTOR

DUCT MOUNTED HEAT DETECTOR SPRINKLER TAMPER SWITCH FURNISHED AND INSTALLED BY E FIRE PROTECTION CONTRACTOR, WIRED BY ELECTRICAL

SPRINKLER FLOW SWITCH FURNISHED AND INSTALLED BY THE FIRE PROTECTION CONTRACTOR, WIRED BY ELECTRICAL CONTRACTOR

SPRINKLER PRESSURE SWITCH

FACP FIRE ALARM CONTROL PANEI FIRE ALARM VOICE PANEL FIRE ALARM ANNUNCIATOR

FIRE ALARM CONTROL RELAY AMM ADDRESSABLE MONITOR MODULE

MASTER BOX. COORDINATE WITH FIRE DEPARTMENT FOR EXTERIOR FIRE ALARM BEACON

7. THE EXISTING FIRE ALARM SYSTEM SHALL REMAIN FULLY FUNCTIONAL DURING THE ENTIRE DEMOLITION AND CONSTRUCTION PERIOD. RE-USE OF THE EXISTING FIRE ALARM RACEWAYS SHALL NOT BE ALLOWED. ALL REQUIRED SYSTEM SHUTDOWNS SHALL BE COORDINATED WITH AND APPROVED BY THE OWNER'S REPRESENTATIVE AND THE AUTHORITY HAVING JURISDICTION. DEMOLITION OF THE EXISTING SYSTEM SHALL NOT COMMENCE UNTIL THE NEW SYSTEM HAS BEEN COMPLETELY INSTALLED, TESTED AND APPROVED BY THE AUTHORITY HAVING JURISDICTION.

ACCESSIBLE CORRIDOR CEILING. PROVIDE PULL STRING

TELEPHONE OUTLET, SUBSCRIPT DENOTES QUANTITY. 4" SQUARE BACK BOX WITH 1" CONDUIT TO NEAREST ACCESSIBLE ABOVE CORRIDOR CEILING. PROVIDE PULL STRING

TELEPHONE BELL

WIRELESS ACCESS POINT. PROVIDE 4" SQUARE BACK BOX

SECURITY DEVICES

CARD READER DOOR CONTACT DOOR RELEASE ELECTRIC LOCK ELECTRIC STRIKE SYSTEM KEYPAD MAGNETIC LOCK MOTION SENSOR

POWER SUPPLY

SECURITY CAMERA

PANIC BUTTON

1. ELECTRICAL CONTRACTOR SHALL PROVIDE 4" BACK BOX WITH 1" CONDUIT AT EACH DEVICE LOCATION TO SECURITY MANAGEMENT

2. EQUIPMENT, DEVICES AND ALL WIRING BY SYSTEM INTEGRATOR.

3. COORDINATE FINAL BACK-BOX SIZES WITH EQUIPMENT VENDOR PRIOR TO ROUGH IN.

EXISTING EQUIPMENT TO REMAIN

EXISTING EQUIPMENT

EXISTING EQUIPMENT TO BE REMOVED EXISTING EQUIPMENT TO BE RELOCATED NEW LOCATION OF RELOCATED EXISTING

EXISTING EQUIPMENT TO BE REPLACED WITH NEW

GENERAL NOTES

1. THIS IS A STANDARD SYMBOL LIST. ALL DEVICE SYMBOLS AND ABBREVIATIONS MAY NOT NECESSARILY APPEAR ON THE PLANS OR DETAIL SHEET. ONLY THOSE SYMBOLS INDICATED ON THE PLANS ARE USED AND OTHERS SHOULD BE DISREGARDED.

2. WHERE THE REQUIREMENTS OF THESE DRAWINGS CONFLICT WITH OTHER PARTS OF THESE CONTRACT DOCUMENTS, THE MORE STRINGENT REQUIREMENTS SHALL APPLY.

3. THESE CONTRACT DRAWINGS ARE DIAGRAMMATIC ONLY, INTENDING TO SHOW GENERAL RUNS AND LOCATIONS OF CONDUITS, DISTRIBUTION EQUIPMENT, LIGHTING FIXTURES, SYSTEMS EQUIPMENT, FTC.. AND NOT NECESSARILY SHOWING ALL DETAILS, ACCESSORIES AND EQUIPMENT TO BE CONNECTED. THE ELECTRICAL CONTRACTOR SHALL BE FULLY RESPONSIBLE FOR COORDINATING IN THE FIELD THE EXACT LOCATIONS. MOUNTING HEIGHTS OF EQUIPMENT AS WELL AS THE ROUTING OF RACEWAYS TO AVOID EXISTING FIELD CONDITIONS. ALL WORK SHALL BE ACCURATELY LAID OUT WITH OTHER TRADES TO AVOID CONFLICTS AND TO OBTAIN A NEAT AND WORKMANLIKE INSTALLATION WHICH WILL AFFORD MAXIMUM

ACCESSIBILITY FOR OPERATION, MAINTENANCE AND HEADROOM 4. THE ELECTRICAL CONTRACTOR SHALL VISIT THE SITE TO DETERMINE THE EXISTING CONDITIONS AND THE SCOPE OF WORK PRIOR TO

5. PERFORM INSTALLATION IN ACCORDANCE WITH CURRENT EDITION OF THE NATIONAL ELECTRICAL CODE THE OCCUPATIONAL SAFETY AND

6. EQUIPMENT SHALL BE LISTED BY A NATIONALLY RECOGNIZED TESTING LABORATORY (NRTL).

HEALTH ACT (OSHA), AND APPLICABLE DOE ORDERS.

7. FURNISH ALL LABOR, MATERIALS AND EQUIPMENT NECESSARY TO COMPLETE THE ELECTRICAL WORK AS SHOWN ON THE DRAWINGS. ALL MATERIAL AND EQUIPMENT SHALL BE NEW AND SHALL BE UL LISTED. "PROVIDE" SHALL MEAN "FURNISH AND INSTALL".

8. APPROVED EQUAL, EQUAL OR SIMILAR WORDING SHALL MEAN THAT THE USE OF ALL MATERIALS OR EQUIPMENT SHALL BE SUBMITTED TO THE ENGINEER FOR APPROVAL, AND SUCH APPROVAL SHALL BE THE SOLE DISCRETION OF THE ENGINEER.

ONE-LINE DIAGRAM

NON-FUSED DISCONNECT SWITCH

FUSED DISCONNECT SWITCH

MOTOR STARTER

PANELBOARD, MAIN LUG ONLY

AUTOMATIC TRANSFER SWITCH

AMMETER W/CONTROL TRANSFORMER

AMMETER W/SELECTOR SWITCH

VOLTMETER W/SELECTOR SWITCH

CIRCUIT BREAKER

GROUND CONNECTION

GENERATOR

PANELBOARD, MAIN CIRCUIT BREAKER

COMBINATION MOTOR STARTER/DISCONNECT

9. OPENINGS THROUGH FIRE RATED FLOORS AND WALLS SHALL BE SEALED WITH U.L. LISTED FIRE SEALS FOR THE SPECIFIC APPLICATION. THE FIRE SEALS SHALL BE INSTALLED IN ACCORDANCE WITH THE MANUFACTURER'S INSTRUCTIONS. ITS U.L LISTING AND THE M.E.C. WHILE MAINTAINING THE FULL FIRE RATING OF THE BARRIER IN WHICH IT IS INSTALLED.

10. ALL PLYWOOD MOUNTING BOARDS SHALL BE PAINTED WITH TWO COATS OF FIRE RETARDANT PAINT. (WHITE OR BLACK AS NOTED).

11. PROVIDE TEMPORARY LIGHTS IN THE AREA OF WORK TO PROVIDE ILLUMINATION DURING CONSTRUCTION TO MEET APPLICABLE CODES. TEMPORARY LIGHTING LEVELS SHALL BE AS REQUIRED BY OSHA, CODES, OR STANDARDS AND INSTALLED PER APPLICABLE REQUIREMENTS OF THE SAME.

12. LIGHTING FIXTURES SHALL BE SUPPORTED FROM BUILDING STRUCTURAL ELEMENTS INDEPENDENT OF FURRED OR SUSPENDED CEILINGS, SUPPORTS FOR FLUORESCENT FIXTURES SHALL BE BOW CHAIN OR ROD. MINIMUM OF 2 SUPPORTS PER 4 FT OF FIXTURE SHALL BE PROVIDED. RECESSED FIXTURES SHALL BE CONNECTED BY FLEXIBLE METALLIC CONDUIT TO JUNCTION BOX.

13. BRANCH CIRCUIT PHASE WIRES SHALL BE CONNECTED TO SEPARATE PHASES OF THE SUPPLY SOURCE TO ASSURE A BALANCED CONDITION IN THAT CIRCUIT AND PROPER LOAD BALANCE ON THE PANEL.

14. BOND RACEWAYS AND THE FRAMES AND ENCLOSURES OF MOTORS, BREAKERS, SWITCHES, AND OTHER ELECTRICAL EQUIPMENT TO THE BUILDING GROUNDING SYSTEM. INSTALL AN INSULATED EQUIPMENT GROUND CONDUCTOR IN EACH RACEWAY OR CONDUIT. SIZE EQUIPMENT GROUND CONDUCTOR IN ACCORDANCE WITH NEC.

15. UNLESS NOTED OTHERWISE; USE 12 AWG OR LARGER CONDUCTORS

CONTACTOR

COMBINATION VFD/DISCONNECT SWITCH

AUTOMATIC TRANSFER SWITCH WITH BYPASS

MANUAL TRANSFER SWITCH

FUSED MOTOR CIRCUIT

PROTECTED MOTOR CIRCUIT

TRANSFORMER (WYE/WYE)

TRANSFORMER (DELTA/WYE)

RACEWAY AND WIRING

CONTACT, NORMALLY OPEN

CONTACT, NORMALLY CLOSED

RACEWAY BREAK SYMBOL, INDICATES CONTINUATION OF

RACEWAY CAP SYMBOL, INDICATES CAPPED AND SEALED

16. UNLESS NOTED OTHERWISE; USE ONLY COPPER CONDUCTORS. 17. CONDUCTORS 10 AWG AND SMALLER SHALL BE SOLID CONDUCTORS

8 AWG AND LARGER SHALL BE STRANDED. XHHW INSULATION

SHALL BE USED FOR CONDUCTORS 1 AWG AND LARGER.

FOR POWER WIRING. USE 14 CONDUCTORS FOR CONTROL WIRING.

18. ALL PANELS (NEW OR EXISTING) WHICH ARE MODIFIED AS PART OF THE SCOPE PF THIS PROJECT SHALL BE PROVIDED WITH A TYPE WRITTEN 8 1/2" X 11" CIRCUIT DIRECTORY. THIS DIRECTORY SHALL BE AFFIXED TO THE INSIDE OF THE PANEL ENCLOSURE

DOOR AND SHALL CLEARLY IDENTIFY EXISTING AND NEW CIRCUITS. 19. THE ELECTRICAL CONTRACTOR SHALL PROVIDE EXPANSION FITTINGS

IN ALL RACEWAYS CROSSING CONSTRUCTION OR EXPANSION JOINTS.

20. WHEN INSTALLING A NEW CIRCUIT BREAKER IN AN EXISTING, PANELBOARD, SWITCHBOARD, SWITCHGEAR, ETC. THE ELECTRICAL CONTRACTOR SHALL BE RESPONSIBLE FOR PROVIDING ALL MATERIALS AND LABOR INCLUDING, BUT NOT NECESSARILY LIMITED TO: MOUNTING HARDWARE, BUS MODIFICATION KITS, CONTROLS, METERS, RELAYS, ETC. REQUIRED FOR A FULLY FUNCTIONAL OVER-CURRENT PROTECTION DEVICE.

21. WHEN PROVIDING NEW OVER CURRENT PROTECTIVE DEVICES, DISCONNECT SWITCHES, STARTERS, BUS PLUGS, CONTACTORS, ETC. IN EXISTING PANEL BOARDS, DISTRIBUTION PANELS, MOTOR CONTROL CENTERS, SWITCHBOARDS, SWITCHGEAR, ETC. THE ELECTRICAL CONTRACTOR SHALL BE RESPONSIBLE FOR MATCHING THE RATINGS AND CHARACTERISTICS OF THE EXISTING EQUIPMENT INCLUDING (BUT NOT NECESSARILY LIMITED TO) VOLTAGE, PHASING, AMPACITY, WITHSTAND RATING, BASIC IMPULSE LEVEL, INTERRUPTING RATING, ETC. ANY AND ALL COSTS ASSOCIATED WITH ANY WORK NECESSITATED BY THE FAILURE TO ADHERE TO THIS REQUIREMENT SHALL BE THE SOLE RESPONSIBILITY OF THE ELECTRICAL CONTRACTOR. THESE COSTS WILL NOT BE REIMBURSES BUY THE OWNER IN ANY MANNER.

ABBREVIATIONS

NEMA 3R RATING

NEMA 4X RATING ALTERNATING CURRENT AMERICANS WITH DISABILITIES ACT ABOVE FINISHED FLOOR ABOVE FINISHED GRADE AUTHORITY HAVING JURISDICTION AMPERE INTERRUPTING CAPACITY AUTOMATIC TRANSFER SWITCH AUTOMATIC TEMPERATURE CONTROL AMERICAN WIRE GAUGE BELOW FINISH GRADE CANDELA RATING CAMPUS DISTRIBUTION FACILITY CEILING DECIBEL DIRECT CURREN DIAMETER FNVIRONMENTAL ALARM SYSTEM ELECTRICAL CONTRACTOR FXHAUST FAN ELEV FI EVATION ELECTRICAL METALLIC TUBINO ELECTRIC WATER COOLER EXISTING FULL LOAD AMPERES FIBER OPTIC CABLE FLOAT SWITCH GENERAL CONTRACTOR GENERATOR GROUND-FAULT CIRCUIT INTERRUPTER GALVANIZED RIGID METALLIC CONDUIT INTERMEDIATE DISTRIBUTION FRAME ISOLATED GROUND INTERMEDIATE METAL CONDU KCMIL THOUSAND CIRCULAR MILS KILOVOLTAMPERES KII OWATTS LFMC LIQUID TIGHT FLEXIBLE META LIGHTING PANEL METAL CLAD CABLE MINIMUM CIRCUIT AMPACITY MAIN CIRCUIT BREAKER MOTOR CONTROL CENTER MAIN DISTRIBUTION FACILITY MAIN LUG ONLY MAXIMUM OVERCURRENT PROTECTION NORMALLY CLOSED NATIONAL FIRE PROTECTION ASSOCIATION

NATIONAL ELECTRICAL MANUFACTURES ASSOCIATION NEMA NOT IN CONTRACT NORMALLY OPEN NOT TO SCALE POWER PANEL POLYVINYL CHLORIDE RIGID METAL CONDUIT TYPICAL UNDERWRITERS LABORATORIES VARIABLE FREQUENCY DRIVE WEATHERPROOF

TRANSFORMER

KEY PLAN

GENERAL NOTES

KEY PLAN NOT TO SCALE

DRAWING TITLE

ELECTRICAL LEGEND AND NOTES

JOB NUMBER: 1680

JOB TITLE:

MISCELLANEOUS RENOVATIONS NEW FIRST FLOOR TOILET ROOM AND SHOWER ROOM UNION STATION WORCESTER, MA


CONSULTANT AN EMPLOYEE OWNED COMPAN 575 West Street, Suite 220

Mansfield, MA 02048


ARCHITECT

egNAULT ARCHITECTS, INC. 71 HOPE AVENUE WORCESTER, MA 01603 TEL: (508)755-6134 FAX: (508) 754-4661

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AS NOTED

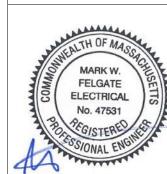

TYPICAL DEVICE MOUNTING HEIGHTS DETAIL

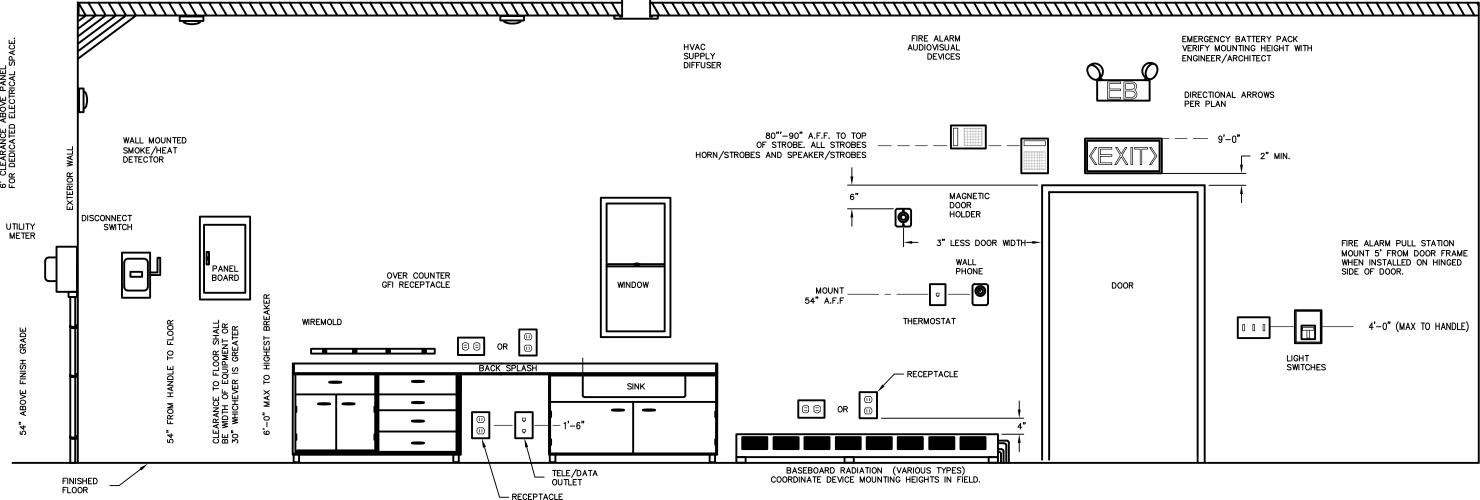1. ALL MOUNTING HEIGHTS SHALL BE MEASURED FROM FINISHED FLOOR TO CENTERLINE OF DEVICE, EXCEPT FIRE ALARM AUDIOVISUAL DEVICES AND EXIT SIGNS.

2. DEVICES SHALL BE INSTALLED ON A COMMON VERTICAL CENTERLINE WHEREVER POSSIBLE. 3. ALL DEVICES SHALL BE INSTALLED AT MOUNTING HEIGHTS INDICATED ON THIS DETAIL UNLESS NOTED

4. VERIFY ORIENTATION (HORIZONTAL OR VERTICAL) OF COUNTER RECEPTACLE WITH ENGINEER/ARCHITECT.

SCALE: NONE NOTES:

> OTHERWISE. COORDINATE FINAL LOCATIONS OF ALL DEVICES WITH MILLWORK AND ARCHITECTURAL DRAWINGS.


5. ARCHITECTURAL ELEVATIONS AND SECTIONS SHALL SUPERSEDE THIS DETAIL WHEN IN CONFLICT.


PROVISIONS FOR TELECOMMUNICATIONS AND A/V RECESSED CEILING MOUNTED COMBINATION BOX WITH POWER, TELECOMMUNICATIONS AND A/V WITH PROJECTOR MOUNT. WIREMOLD #ECB2SP, OR APPROVED EQUAL

HVAC AUTOMATIC TEMPERATURE CONTROL PANEL FURNISHED AND INSTALLED BY HVAC CONTRACTOR, WIRED BY ELECTRICAL CONTRACTOR MOTOR SENTINEL SWITCH

DRAWING NO.

JUNE, 2022

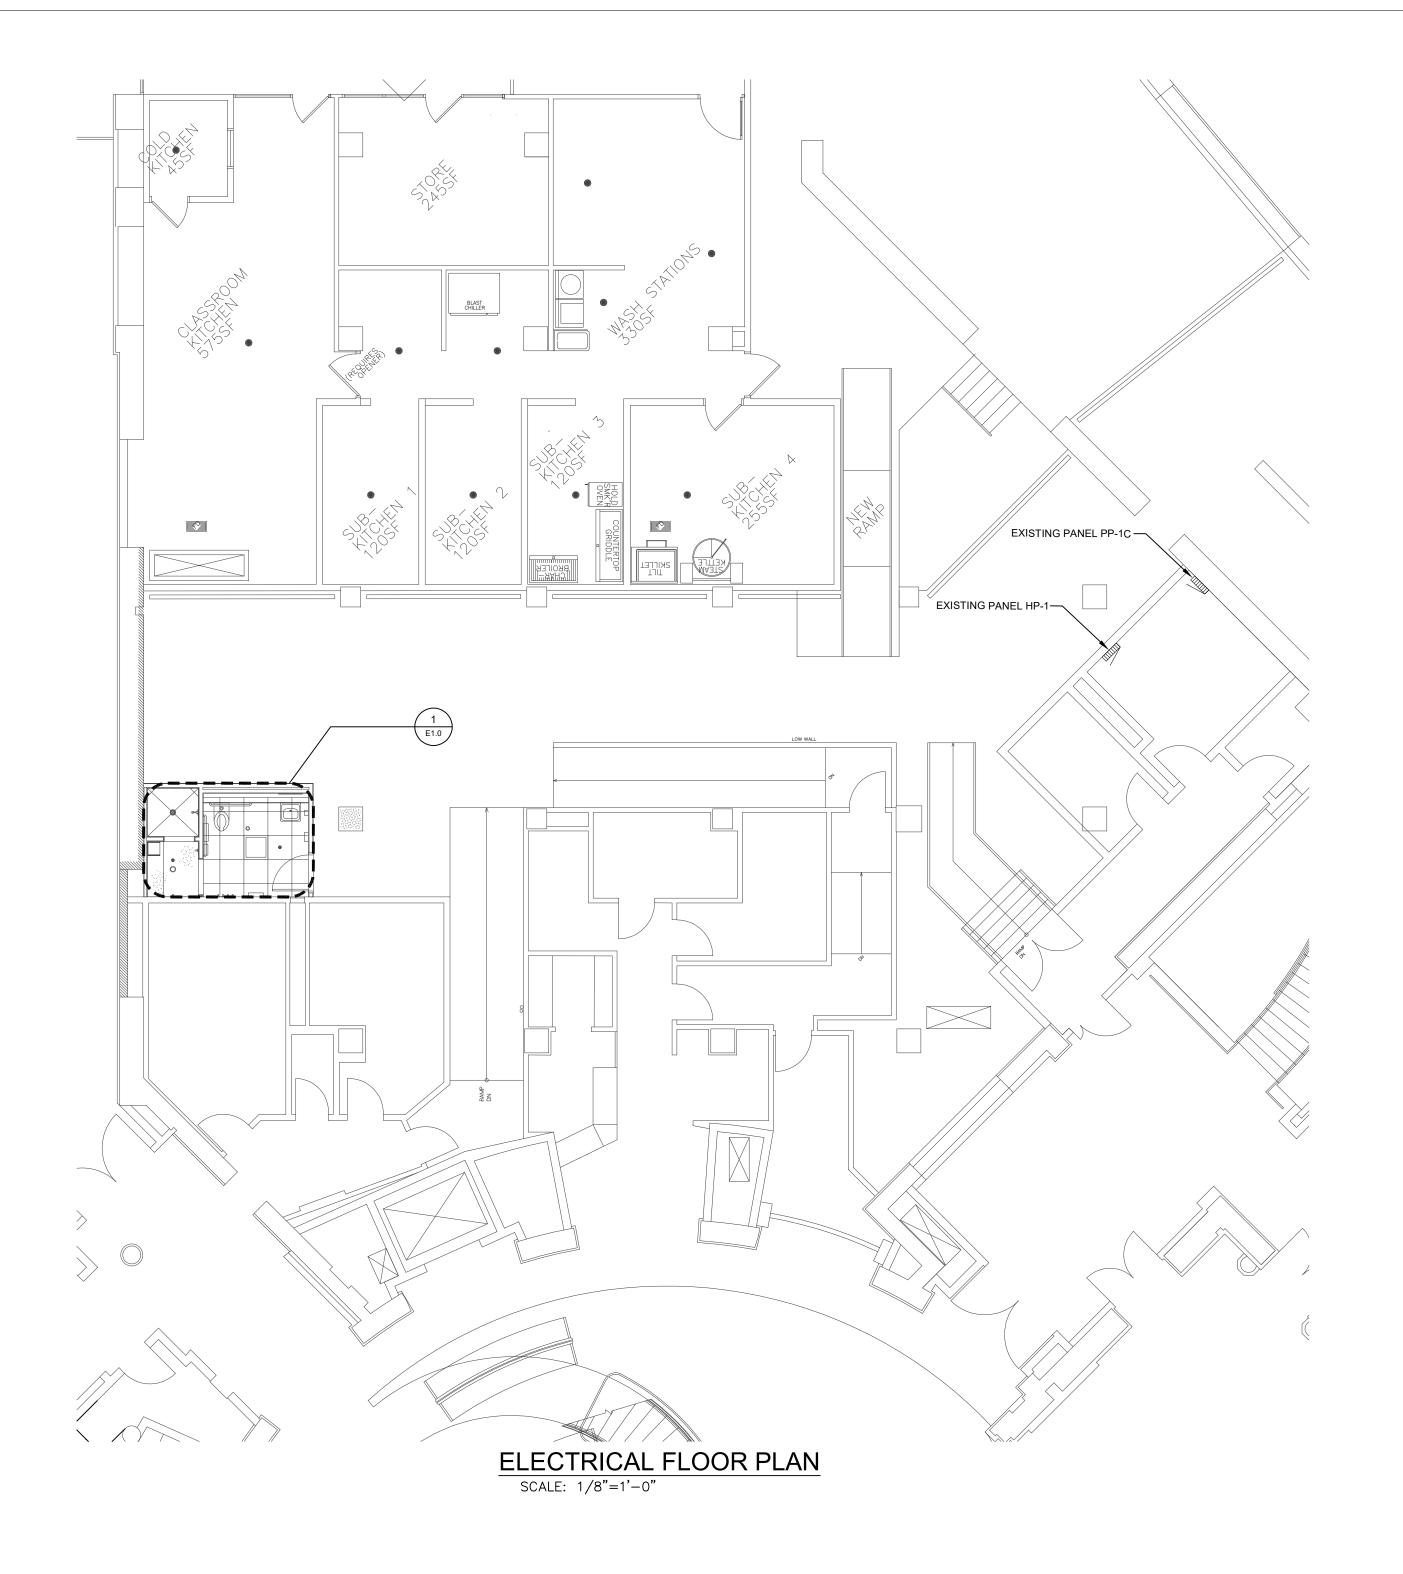

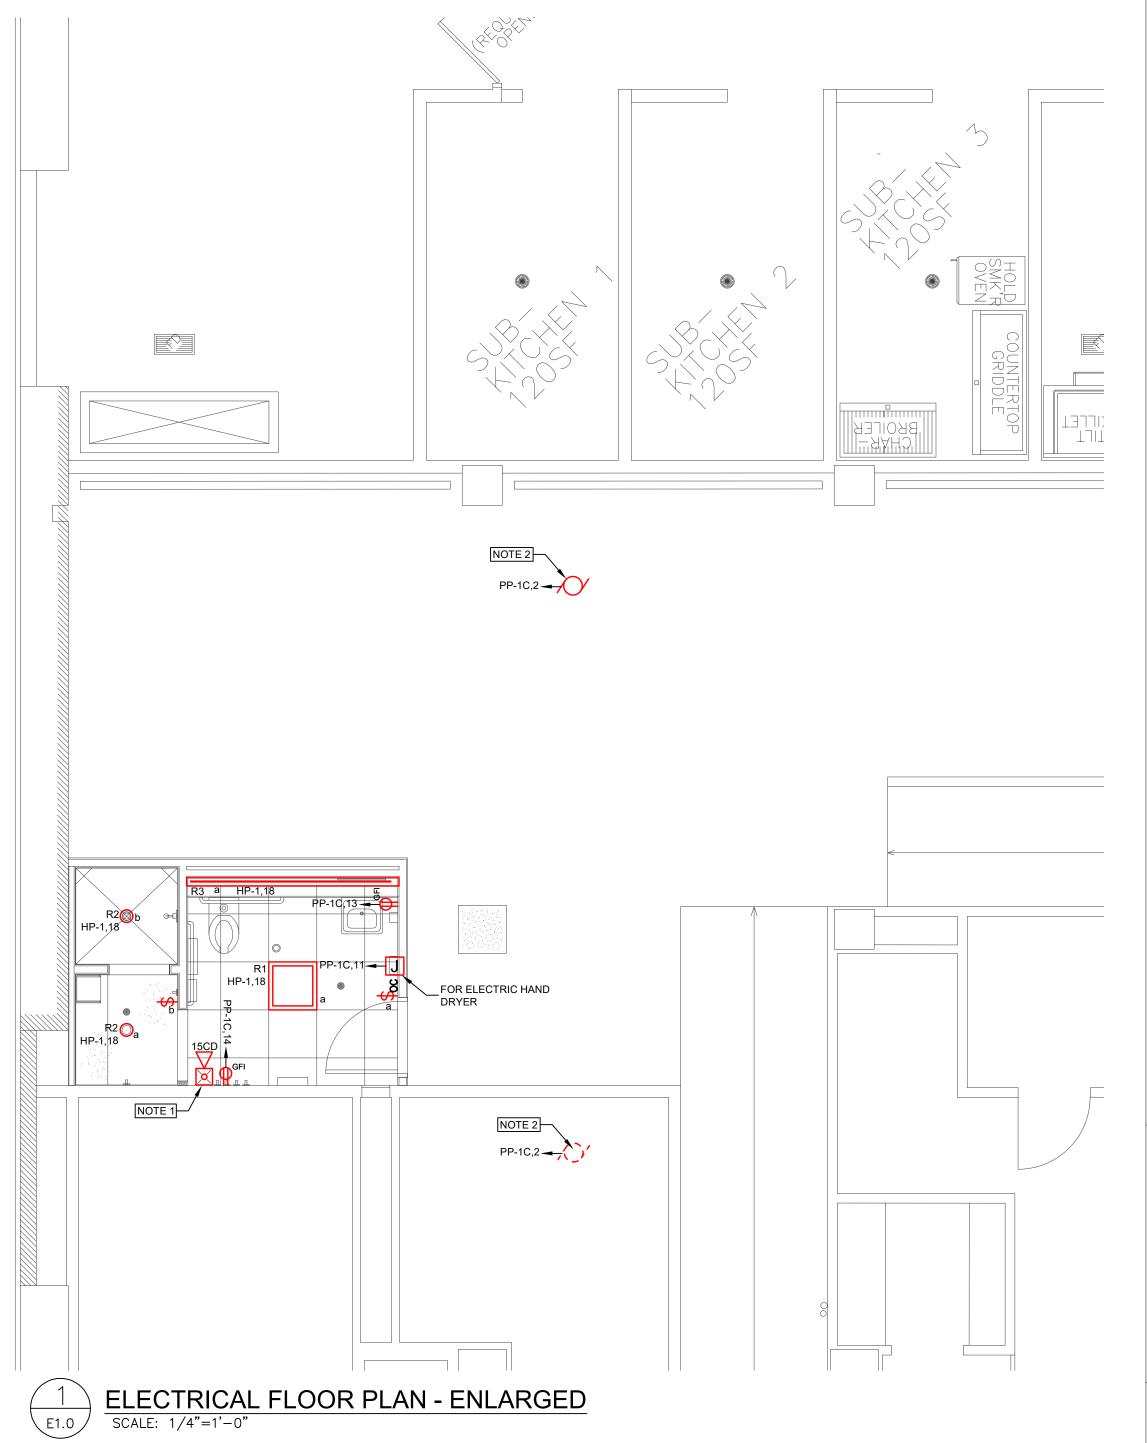

GENERAL NOTES

A. REFER TO ARCHITECTURAL FLOOR PLANS, ELEVATIONS AND REFLECTED CEILING PLANS FOR EXACT LOCATIONS OF LIGHT FIXTURES AND DEVICES.

KEYED NOTES

1. FIRE ALARM DEVICE SHALL BE CONNECTED TO THE EXISTING FIRE ALARM CIRCUIT IN THE AREA.

2. EXISTING FAN TO BE REMOVED AND RELOCATED BY OTHERS.

KEY PLAN

KEY PLAN NOT TO SCALE

DRAWING TITLE

ELECTRICAL FLOOR PLANS

JOB NUMBER: 1680 JOB TITLE:

MISCELLANEOUS RENOVATIONS NEW FIRST FLOOR TOILET ROOM AND SHOWER ROOM UNION STATION WORCESTER, MA

575 West Street, Suite 220 Mansfield, MA 02048 Tel: 508.821.9759 www.Hallam-ICS.com

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FELGATE ELECTRICAL No. 47531

AS NOTED

JUNE, 2022

DRAWING NO.

DESCRIPTION

LED 2X2 SCENE SCE RECESSED

P4R 4" ROUND DOWNLIGHT & WALL WASH FULL LENGTH, WALL TO WALL. 4.0" REGRESS. FIXTURE HAS HOUSING TO BE RECESSED MOUNTED UP IN CEILING. THE LENS IS 4" ABOVE THE CEILING GRID. GENERAL NOTES

				LIGH	T FIXTURE SCHEDU	JLE			
FIXTURE	MANUFACTURER	MANUFACTURER MODEL NUMBER	VOLTAGE	INPUT WATTS	LAMP TYPE	LUMEN OUTPUT	LAMP COLOR	DIMMING METHOD	MOUNTING
R1	METALUMEN	SCE-2L35K-22-SD-W-L61-T-4-N-N	277	43	LED	3581	3500K	NOT REQUIRED	RECESSED
R2	SIGNIFY	4RNU-P4RSL05835WH-Z10U-	277	7	LED	500	3500K	NOT REQUIRED	RECESSED
R3	FOCAL POINT	FSM4PR-ALH-FL4-275LF-35K-IC-UNV-WH-8FT10IN	277	24	LED	2236	3500K	NOT REQUIRED	RECESSED

- 1. DIMMERS SHALL BE COMPATIBLE WITH LIGHT FIXTURES, LINEAR SLIDE TYPE.
- 2. REFER TO SPECIFICATIONS FOR ADDITIONAL REQUIREMENTS FOR THE LIGHTING SYSTEM.
- 3. COORDINATE CEILING GRIDS & SIZE WITH ARCHITECT & MANUFACTURER.

29 20A-1P SPARE

EXISTING PANEL PP-1C LOCATION: FED FROM PP-1A 208Y/120 VOLTS, 3 - PHASE, 4 - WIRE 100A MAIN LUG ONLY MOUNTING: SURFACE MAIN BREAKER 100A BUS RATING 10,000 AIC BR. BREAKERS - BOLTED TOTAL LOAD: 0.0 KVA REMARKS: LOAD DESCRIPTION NO SIZE LOAD DESCRIPTION BRANCH CIRCUIT KVA PH NO SIZE BRANCH CIRCUIT KVA 1 20A-1P EXISTING 3 20A-1P EXISTING 5 20A-1P EXISTING A 2 25A-1P EXISTING B 4 20A-1P EXISTING EXISTING EXISTING EXISTING C 6 20A-1P EXISTING EXISTING A 8 20A-1P EXISTING B 10 20A-1P EXISTING 20A-1P EXISTING EXISTING 9 20A-1P EXISTING EXISTING 11 20A-1P BATHROOM HAND DRYER 13 20A-1P BATHROOM RECEPTACLE 2#12, 1#12G, 3/4"C. 2#12, 1#12G, 3/4"C. B 16 20A-1P SPARE C 18 20A-1P SPARE A 20 20A-1P SPARE B 22 20A-1P SPARE C 24 20A-1P SPARE A 26 20A-1P SPARE B 28 20A-1P SPARE C 30 20A-1P SPARE

			EXI	STINC	PAN	EL HI	P-1			
	480Y/277V	VOLTS, 3 - PHASE, 4 - WIRE				L	OCATION:			
		MAIN LUG ONLY				M	OUNTING:	SURFACE	*	
	125A	MAIN BREAKER						8		
	250A	BUS RATING					TYPE:			
			14,000	AIC			1 11			
	BR. BREAK	ERS - BOLTED				TOT	AL LOAD:	: 0.0 KVA		
	REMARKS:	£						_		
CIRC.						CIRC				
NO	SIZE	LOAD DESCRIPTION	BRANCH CIRCUIT	KVA	PH	. NO	SIZE	LOAD DESCRIPTION	BRANCH CIRCUIT	KVA
1	20A-1P	EXISTING	EXISTING		Α	2	25A-1P	EXISTING	EXISTING	
3	20A-1P	EXISTING	EXISTING		В	4	20A-1P	EXISTING	EXISTING	
5	20A-1P	EXISTING	EXISTING		С	6	20A-1P	EXISTING	EXISTING	
7	20A-1P	EXISTING	EXISTING		Α	8	20A-1P	EXISTING	EXISTING	
9	20A-1P	EXISTING	EXISTING		В	10	20A-1P	EXISTING	EXISTING	
11	20A-1P	EXISTING	EXISTING		С	12	20A-1P	EXISTING	EXISTING	
13	20A-1P	EXISTING	EXISTING		Α	14	20A-1P	EXISTING	EXISTING	
15	20A-1P	EXISTING	EXISTING		В	16	20A-1P	EXISTING	EXISTING	
17	20A-1P	EXISTING	EXISTING		C	18	20A-1P	BATHROOM LIGHTING	2#12, 1#12G, 3/4"C.	
19	20A-1P	EXISTING	EXISTING		Α	20	20A-1P	SPARE		
21	20A-1P	SPARE			В	22	20A-1P	SPARE		
23	20A-1P	SPARE			С	24	20A-1P	SPARE	3) ()	
25	20A-1P	SPARE		91	Α	26		I		
27	20A-1P	SPARE			В	28	125A-3P	EXISTING MAIN	EXISTING	
29	20A-1P	SPARE			C	30	I	1	1	


JOB NUMBER: 1680

JOB TITLE: MISCELLANEOUS RENOVATIONS NEW FIRST FLOOR TOILET ROOM AND SHOWER ROOM UNION STATION WORCESTER, MA

AN EMPLOYEE OWNED COMPANY 575 West Street, Suite 220

Mansfield, MA 02048 Tel: 508.821.9759 www.Hallam-ICS.com

NAULT ARCHITECTS, INC.

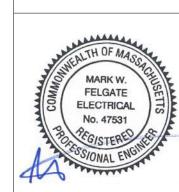

DRAWING NO.

AS NOTED

JUNE, 2022