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WORCESTER MEMORIAL AUDITORIUM



The City of
WORCESTER

1 LINCOLN SQUARE
WORCESTER, MA
01605

issued for: bid set
date: june 8, 2021
project no. : cow-5705

electrical engineer:

edm
1801 6th Avenue
Suite 200
troy, ny 12180

contact: Jeremy Barnes
(518) 272-0274
(413) 443-6057 fax
jbarnes@edm-ae.com

fire alarm legend:

<div>F</div> YY	MANUAL PULL STATION WP = WEATHERPROOF
<div>SD</div> YY	SMOKE DETECTOR WP = WEATHERPROOF
<div>HD</div> YY	HEAT DETECTOR WP = WEATHERPROOF
<div>FS</div>	FLOW SWITCH
<div>TS</div>	SPRINKLER TAMPER SWITCH
<div>☒</div>	FIRE ALARM NOTIFICATION STROBE WALL MOUNTED AT 80-90" AFF
<div>☒</div> XXX YY	FIRE ALARM NOTIFICATION HORN/STROBE WALL MOUNTED AT 80-90" AFF (XXX - 75 OR 135 AS NOTED), WP = WEATHERPROOF
<div>FACP</div>	FIRE ALARM CONTROL PANEL
<div>ANN</div>	FIRE ALARM ANNUNCIATOR PANEL
<div>☒</div>	FIRE ALARM NOTIFICATION STROBE - CEILING MOUNTED
<div>☒</div>	FIRE ALARM NOTIFICATION HORN/STROBE - CEILING MOUNTED

fire alarm abbreviations

AFF	ABOVE FINISHED FLOOR	HP	HORSEPOWER
AV	AUDIO/VISUAL	KEC	KITCHEN EQUIPMENT CONTRACTOR
C/B	CIRCUIT BREAKER	MC	MECHANICAL CONTRACTOR
CKT	CIRCUIT	MH	MOUNTING HEIGHT
CLG	CEILING	NTS	NOT TO SCALE
DWG	DRAWING	TYP	TYPICAL
EC	ELECTRICAL CONTRACTOR	UON	UNLESS OTHERWISE NOTED
EM	EMERGENCY	WP	WEATHER PROOF
FAC	FIRE ALARM CONTRACTOR		
FLR	FLOOR		


demolition notes

1. THE FIRE ALARM CONTRACTOR SHALL BE RESPONSIBLE FOR VERIFYING THE INTEGRITY AND CONDITION OF THE EXISTING WIRING WHICH IS TO BE REUSED FOR NEW EQUIPMENT CIRCUITING ACCORDING TO THE NATIONAL ELECTRIC CODE. ALL DAMAGED WIRING OR WIRING FOUND TO BE NONFUNCTIONAL SHALL BE REPLACED.
2. EXISTING WIRING SHALL BE EXTENDED AND CONNECTED TO ALL EXISTING RELOCATED EQUIPMENT, AS REQUIRED FOR A COMPLETE WORKING SYSTEM.
3. RECONNECT ALL EXISTING WIRING WHICH ORIGINATES OR PASSES THROUGH THE RENOVATED AREAS BUT SERVES OTHER AREAS NOT BEING RENOVATED. EXTEND THESE CIRCUITS AS NECESSARY TO THE HEAD END EQUIPMENT.
4. DEMOLITION WORK SHALL BE DONE BY THE FIRE ALARM CONTRACTOR. THE FIRE ALARM CONTRACTOR SHALL COORDINATE ALL WORK CONCERNING EXISTING EQUIPMENT AND SERVICES REMAINING IN THE BUILDING.
5. THE FIRE ALARM CONTRACTOR SHALL COORDINATE THE REMOVAL OF ALL EQUIPMENT AND DEVICES WITH THE OWNER AS IT PERTAINS TO RETAINING OF EQUIPMENT FOR FUTURE USE.
6. THE FIRE ALARM DEMOLITION PLANS INDICATE GENERAL INTENT AND ARE NOT INTENDED TO SHOW ALL COMPONENTS AND ITEMS TO BE REMOVED OR RETAINED. THE FIRE ALARM CONTRACTOR SHALL VISIT THE SITE PRIOR TO SUBMISSION OF THEIR BID TO BECOME FAMILIAR WITH THE ACTUAL WORKING CONDITIONS AND EXTENT OF WORK. DEVICES AND EQUIPMENT LOCATED ON WALLS AND/OR CEILINGS DESIGNATED TO BE REMOVED SHALL BE DISCONNECTED AND MADE SAFE. THE FIRE ALARM CONTRACTOR SHALL IMMEDIATELY NOTIFY THE OWNERS REPRESENTATIVE AND ARCHITECT OF ANY UNANTICIPATED OR HIDDEN CONDITIONS ENCOUNTERED DURING DEMOLITION.
7. THE FIRE ALARM CONTRACTOR SHALL CIRCUIT TRACE AND LABEL ALL WIRING WITHIN OR ASSOCIATED WITH THE DEMOLITION SCOPE, PRIOR TO DE-ENERGIZING AND DISCONNECTION. ALL DEVICES AND ASSOCIATED WIRING IDENTIFIED FOR REMOVAL SHALL BE TRACED AND FIELD LABELED TO ENSURE THAT NO AREA OUTSIDE THE DEMOLITION SCOPE IS AFFECTED.
8. THE FIRE ALARM CONTRACTOR SHALL IDENTIFY ALL DEVICES AND ASSOCIATED WIRING WHICH ARE TO REMAIN WITHIN THE AREA OF DEMOLITION SCOPE. THERE SHALL BE NO INTERRUPTION OF SERVICE TO ANY AREA OUTSIDE THE SCOPE LIMITS WITHOUT WRITTEN APPROVAL FROM THE OWNERS REPRESENTATIVE. EXISTING EQUIPMENT TO REMAIN SHALL BE LEFT IN A CODE COMPLIANT CONDITION.
9. THE FIRE ALARM CONTRACTOR SHALL DE-ENERGIZE AND REMOVE ALL CONDUCTORS AND RACEWAYS WITHIN THE AREA OF DEMOLITION SCOPE TO THEIR POINT OF ORIGIN. ITEMS IDENTIFIED FOR DEMOLITION SHALL NOT BE ABANDONED IN PLACE. RACEWAYS THAT ENTER MASONRY WALLS AND FLOORS SHALL BE CUT FLUSH AT THE SURFACE FOR PATCHING BY OTHERS.
10. THE FIRE ALARM CONTRACTOR SHALL TEMPORARILY SUPPORT ALL ITEMS TO REMAIN THAT ARE AFFECTED BY THE DEMOLITION OF BUILDING STRUCTURAL COMPONENTS (WALLS, CEILINGS, PARTITIONS, ETC.). CONTRACTOR SHALL TEMPORARILY SUPPORT ITEMS AND SHALL PROVIDE PERMANENT SUPPORTS WHEN FINALIZED STRUCTURES ARE IN PLACE.
11. SCOPE OF DEMO WORK IS TO REMOVE THE EXISTING FIRE ALARM SYSTEM IN THE BASEMENT WHICH INCLUDES REMOVAL OF EXISTING EQUIPMENT, DEVICES, ASSOCIATED CABLING AND CONDUIT, AND BACKBOXES.

demolition legend

<div></div>	<div></div>	<div></div>	<div></div>	LIGHT SOLID LINE DENOTES EXISTING EQUIPMENT.
<div></div>	<div></div>	<div></div>	<div></div>	DARK DASHED LINE DENOTES DEMOLITION EQUIPMENT.


- X. EXISTING EQUIPMENT TO BE REMOVED AND DELIVERED TO OWNER. CIRCUIT SHALL BE PULLED BACK FROM NEXT ACTIVE OUTLET/BACK TO PANEL. REMOVE JUNCTION BOXES, AND PATCH WALL. BLANK PLATES NOT PERMITTED.
- XM. EXISTING EQUIPMENT TO REMAIN.
- XN. EXISTING EQUIPMENT TO BE REMOVED AND NEW EQUIPMENT AS SPECIFIED INSTALLED ON EXISTING CIRCUIT IN ORIGINAL LOCATION.
- XE. EXISTING DEVICE TO BE REMOVED, OUTLET BLANKED AND CIRCUIT EXTENDED TO NEW EQUIPMENT AS SHOWN.
- XR. EXISTING EQUIPMENT TO BE REMOVED AND RELOCATED. REMOVE JUNCTION BOXES, AND PATCH WALL. BLANK PLATES NOT PERMITTED.
- XL. NEW LOCATION OF RELOCATED EXISTING EQUIPMENT.

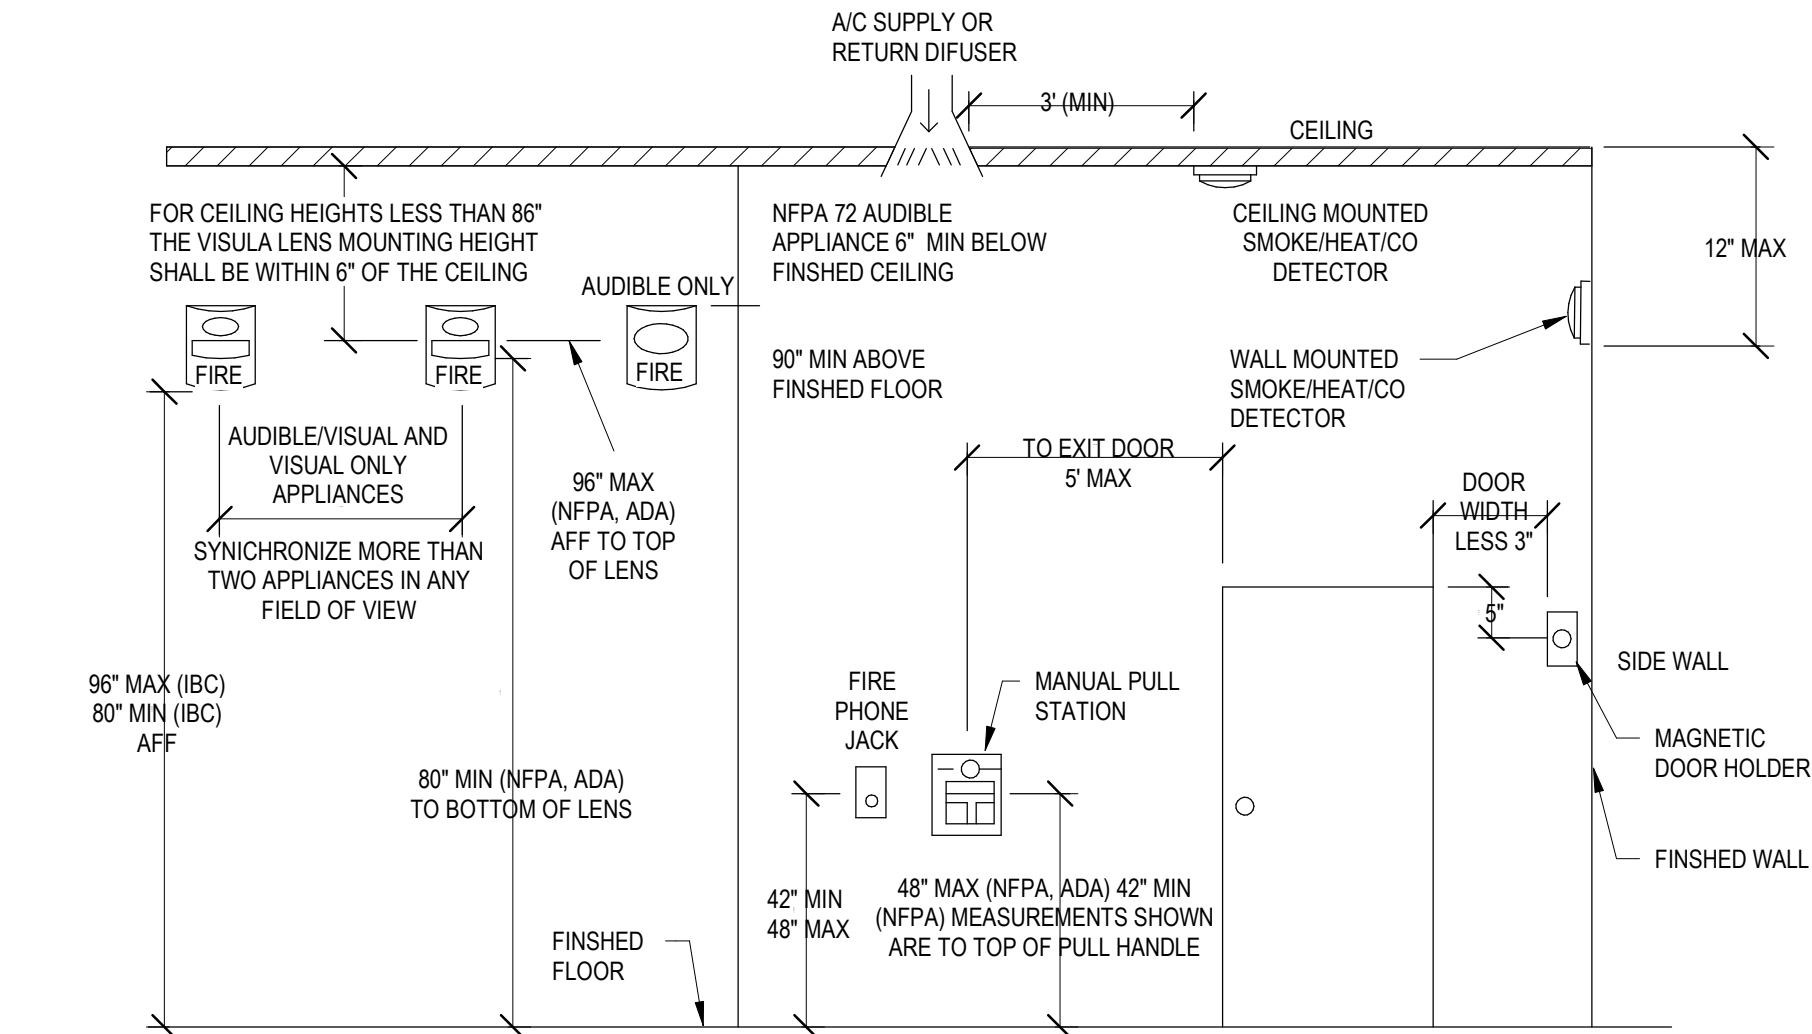

NOTE: REFER TO PROPER
INSTALLATION INSTRUCTIONS FOR
BACKBOX MOUNTING HEIGHT.

- NOTES:
1. HEIGHT GIVEN FOR THIS DEVICE IS THE MAXIMUM HEIGHT TO THE HIGHEST OPERABLE PART OF THE DEVICE.
 2. REFER TO THE DRAWINGS FOR SPECIFIC DEVICE HEIGHTS

1 typical fire alarm device location
3/4" = 1'-0"

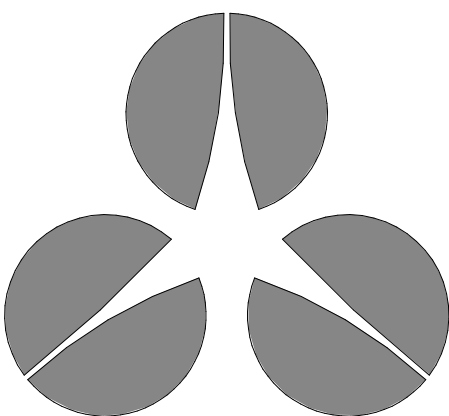

architecture
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engineering
•
management

pittsfield, ma
unionville, ct
troy, ny

(888) 336-6500
team@edm-ae.com

consultants:



design by:
EJM

drawn by:
TST

checked by:
EJM

approved by:
EJM

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1 LINCOLN SQUARE
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keyplan:

issue / rev.:	date:	issued for:	by:


general fire alarm notes and
legend

date:
june 8, 2021
project number:
cow-5705
scale:
As indicated
drawing number:

FAN-001



1. TIE IN (2) WATER FLOW SWITCHES AND (3) TAMPER SWITCHES LOCATED IN THE SPRINKLER ROOM TO THE NEW FIRE ALARM CONTROL PANEL..
2. SMOKE DETECTOR LOCATED AT 1ST FLOOR LANDING.
3. 135 CANDELA RATED STROBE.

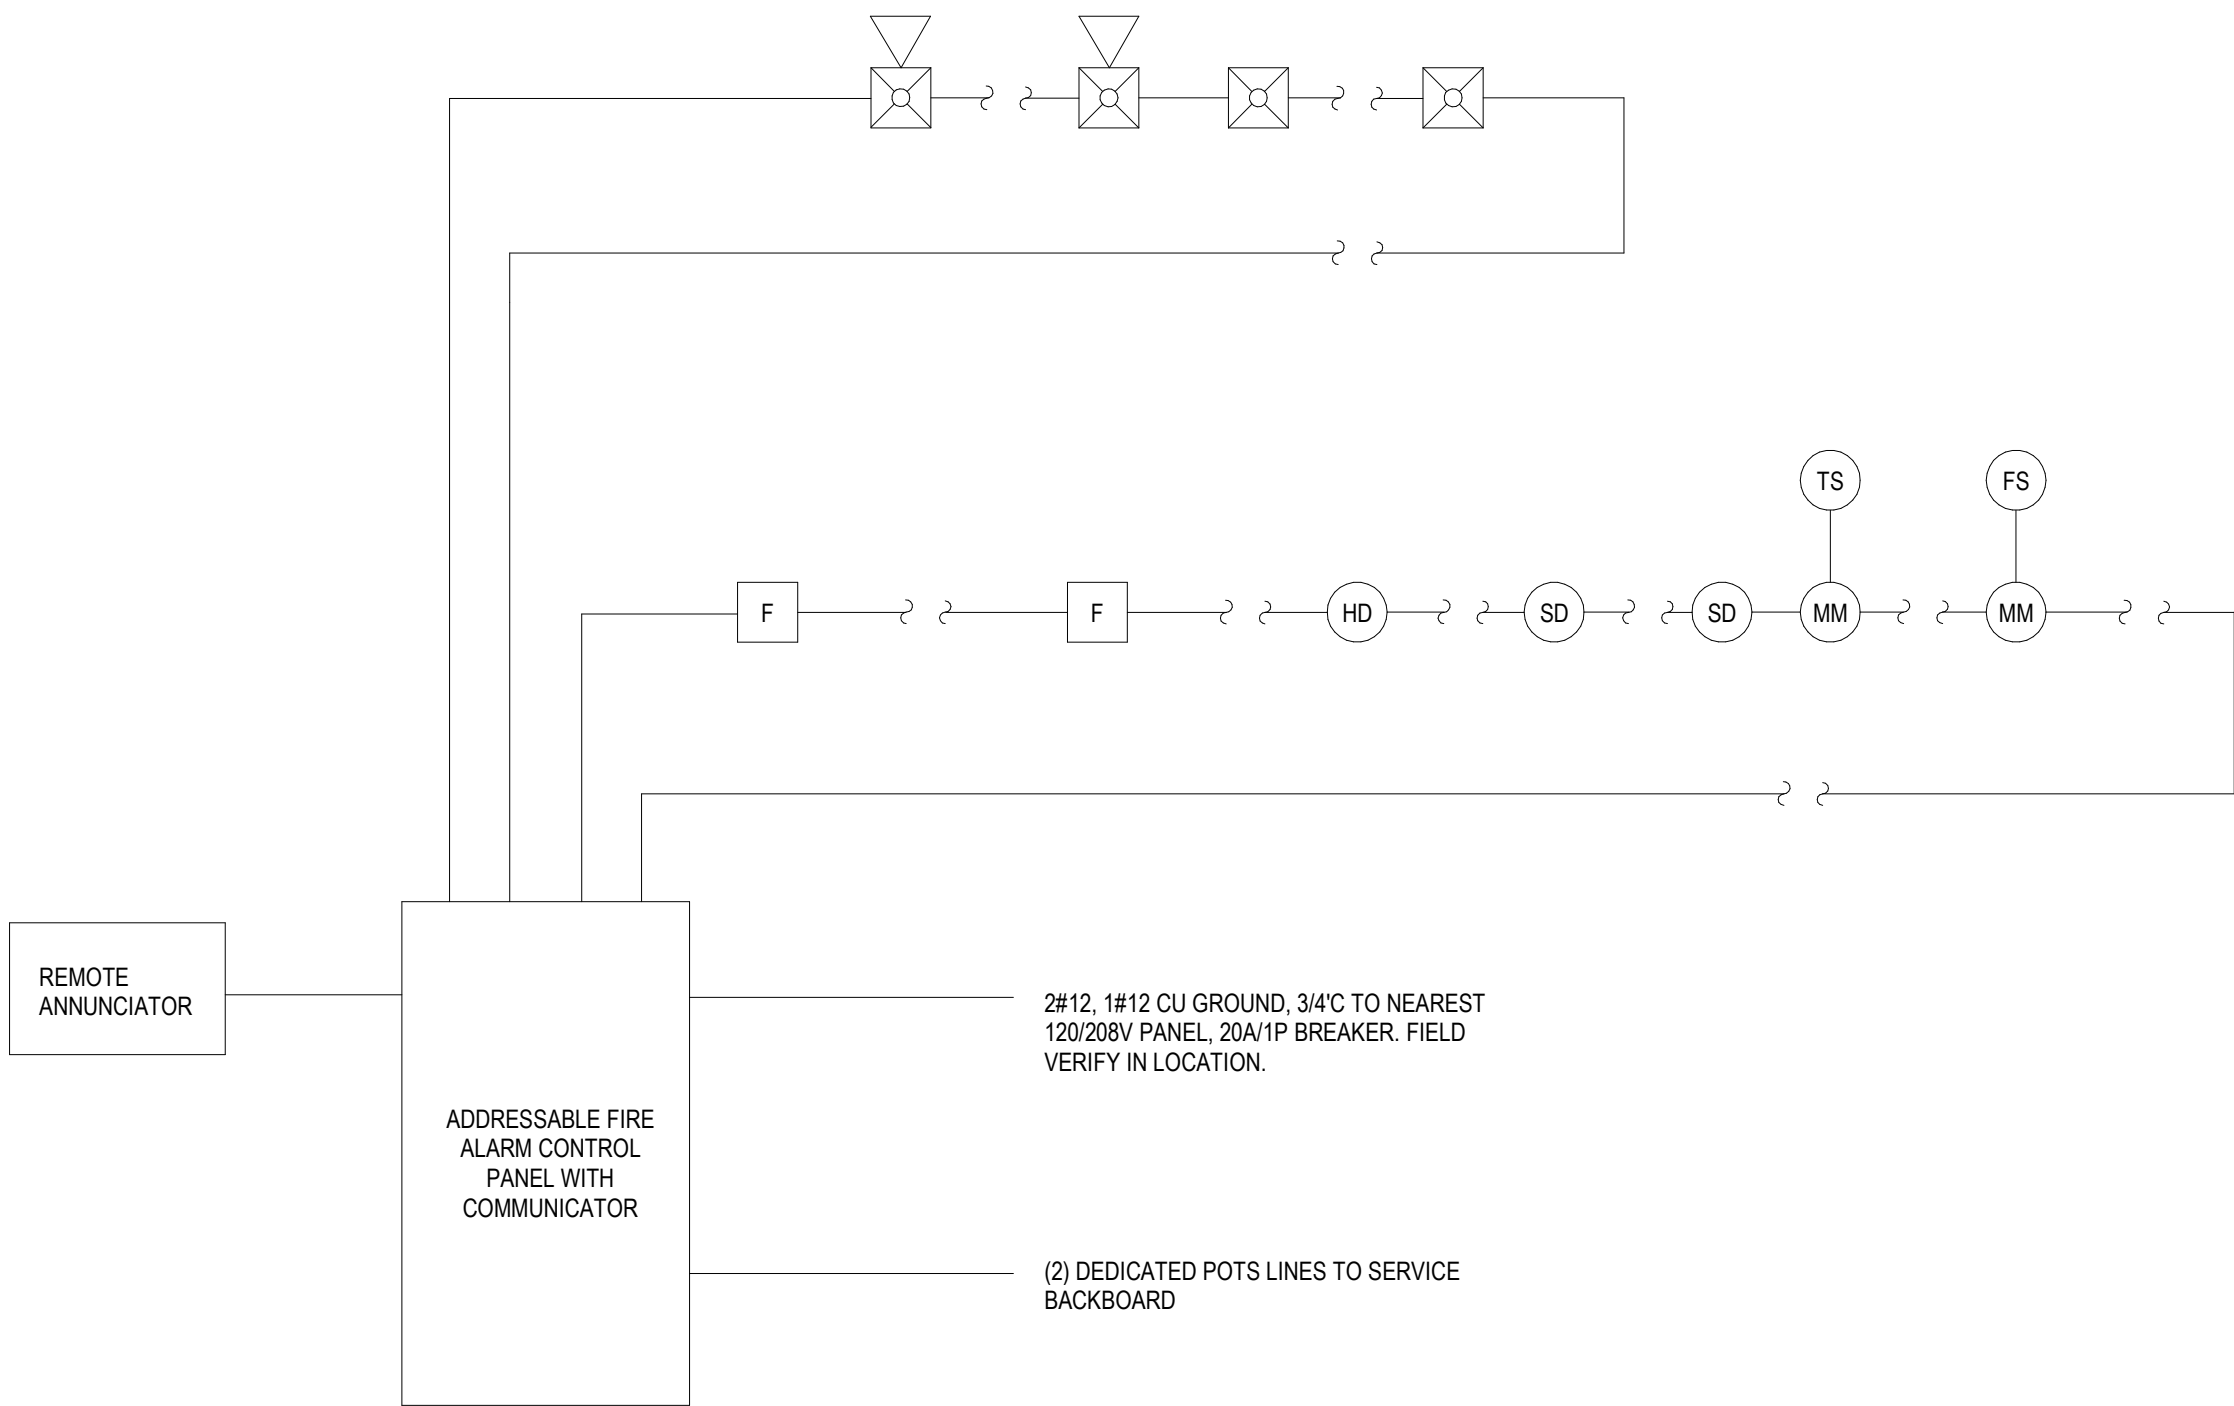


1 fire alarm riser diagram
3/4" = 1'-0"

fire alarm device schedule			
SYMBOL	DESCRIPTION	MANUFACTURER	NOTES
[FACP]	FIRE ALARM CONTROL PANEL - ADDRESSABLE WITH COMMUNICATOR	FIRE LITE #FL-ES200X	
[ANN]	ANNUNCIATOR - 80 CHARACTER DISPLAY	FIRELITE #ANN-80	
(SD)	SMOKE DETECTOR, ADDRESSABLE	FIRELITE #SD355	
(HD)	HEAT DETECTOR, ADDRESSABLE	FIRELITE #HD355	
[F]	MANUAL PULL STATION, DUAL ACTION, ADDRESSABLE	FIRELITE #BG-12LX	
[Horn/Strobe] XXX	HORN/STROBE COMBINATION	FIRELITE #SR-P-75 CANDELA #SRH-P-135 CANDELA	
[Strobe]	STROBE LIGHT, WALL MOUNT	FIRELITE #P2R	
NOTES: 1. REFER TO FIRE ALARM LEGEND DRAWING FAN-001 FOR ANY DEVICES NOT INDICATED ON THIS SCHEDULE			

fire alarm riser notes

- FIRE ALARM PARTIAL RISER DIAGRAM IS DIAGRAMMATIC - THE ELECTRICAL CONTRACTOR SHALL REFER TO PROJECT DRAWINGS FOR QUANTITY AND LOCATION OF DEVICES.
- REFER TO SYMBOL LEGEND FOR FIRE ALARM DEVICE INFORMATION.
- SECONDARY POWER SHALL BE PROVIDED IN ACCORDANCE WITH NFPA 72 TO PROVIDE POWER FOR A MINIMUM OF 24 HOURS STAND-BY AND 5 MINUTES ALARM.
- ALL INSTALLATION WORK SHALL CONFORM WITH THE REQUIREMENTS OF THE NATIONAL FIRE PROTECTION ASSOCIATION, NFPA 72, NATIONAL FIRE ALARM CODE AND THE 2015 INTERNATIONAL BUILDING CODE.
- ALL INITIATING DEVICES, CONTROL MODULES, MONITOR MODULES, NOTIFICATION APPLIANCES AND ALL OTHER EQUIPMENT SHALL BE INSTALLED ON STANDARD ELECTRICAL NBACK BOXES THAT ARE SECURED TO THE BUILDING STRUCTURE.
- AUDIBLE AND/OR VISUAL NOTIFICATION APPLIANCES SHALL HAVE THE SAME STYLE ACK BOX AND BE INTERCHANGEABLE.
- FIRE ALARM LAYOUT SHOWN ON CONTRACT DOCUMENTS IS TO SHOW DESIGN INTENT ONLY.
- ALL INITIATING DEVICES AND NOTIFICATION APPLIANCES SHALL BE UL/FM LISTED FOR THEIR INTENDED USE AND SHALL BE COMAPATIBLE WITH THE FIRE ALARM CONTROL PANEL.
- FIRE ALARM SIGNALING SYSTEM NOTIFYING AUDIO STROBE COVERAGE IS PER NFPA-72 PUBLIC MODE, THE AMERICANS WITH DISABILITIES ACT(ADA) AND FIRE CODE FOR SPACING , CANDELA AND AUDIO ALARM AMPLITUDE.
- WHEN FIRE ALARM SYSTEM IS ACTIVATED, ALL AUDIO STROBES SHALL COOPERATE IN A SYNCHRONIZED MANNER. ALARM FOR BUILDING EVACUATION AS DESCRIBED PER MASSACHUSSETTS BUILDING AND FIRE CODES, AND NFPA-72. ALL AUDIO/STROBES SHALL BE ADA APPROVED AND SYNCHRONIZED.
- CLASS A WIRING IS REQUIRED FOR ALL DETECTION DEVICES AND NOTIFICATION APPLIANCES.
- SYSTEM SHALL BE INSTALLED AND PROGRAMMED SO THAT UPON ACTIVATIONOF AN ALARM, TROUBLE OR SUPERVISORY SIGNAL AT THE FIRE ALARM CONTROL PANEL, A CORRESPONDING SIGNAL SHALL BE REPORTED TO A LISTED CENTRAL STATION MONITORING SERVICE OR THE MUNICIPLE FIRE DEPARTMENT.
- REMOTE ANNUNCIATOR FUNCTIONS SHALL MATCH THOSE OF FIRE-ALARM CONTROL UNIT FOR ALARM, SUPERVISORY, AND TROUBLE INDICATIONS. MANUAL SWITCHING FUNCTIONS SHALL MATCH THOSE OF FIRE-ALARM CONTROL UNIT, INCLUDING ACKNOWLEDGING, SILENCING, RESETTNG, AND TESTING. DISPLAY TYPE AND FUNCTIONAL PERFORMANCE: ALPHANUMERIC DISPLAY AND LED INDICATING LIGHTS SHALL MATCH THOSE OF FIRE-ALARM CONTROL UNIT. PROVIDE CONTROLS TO ACKNOWLEDGE, SILENCE, RESET, AND TEST FUNCTIONS FOR ALARM, SUPERVISORY, AND TROUBLE SIGNALS.

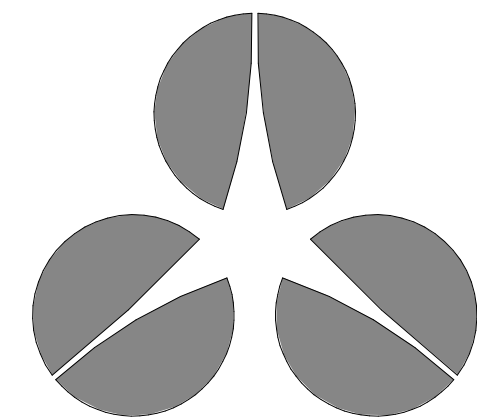


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consultants:



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fire alarm riser diagram

date:
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project number:
cow-5705
scale:
As indicated
drawing number:

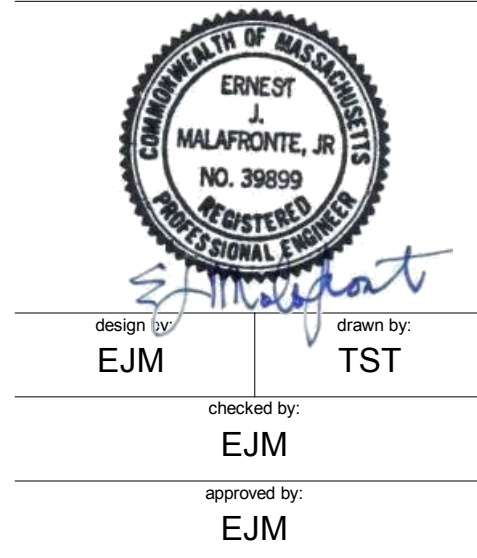FA-401