EMERGENCY GENERATOR REPLACEMENT 18-20 AND 76 EAST WORCESTER STREET


DEPARTMENT OF PUBLIC WORKS
WORCESTER, MASSACHUSETTS
BID DOCUMENTS
NOVEMBER 4, 2025
BID NO: 8486-M6

PREPARED FOR:


ERIC D. BATISTA, CITY MANAGER
JOHN K. WESTERLING, COMMISSIONER OF PUBLIC WORKS

PREPARED BY:

FITZMEYER & TOCCI ASSOCIATES INC 300 UNICORN PARK DRIVE, 5TH FLOOR WOBURN, MA 01801

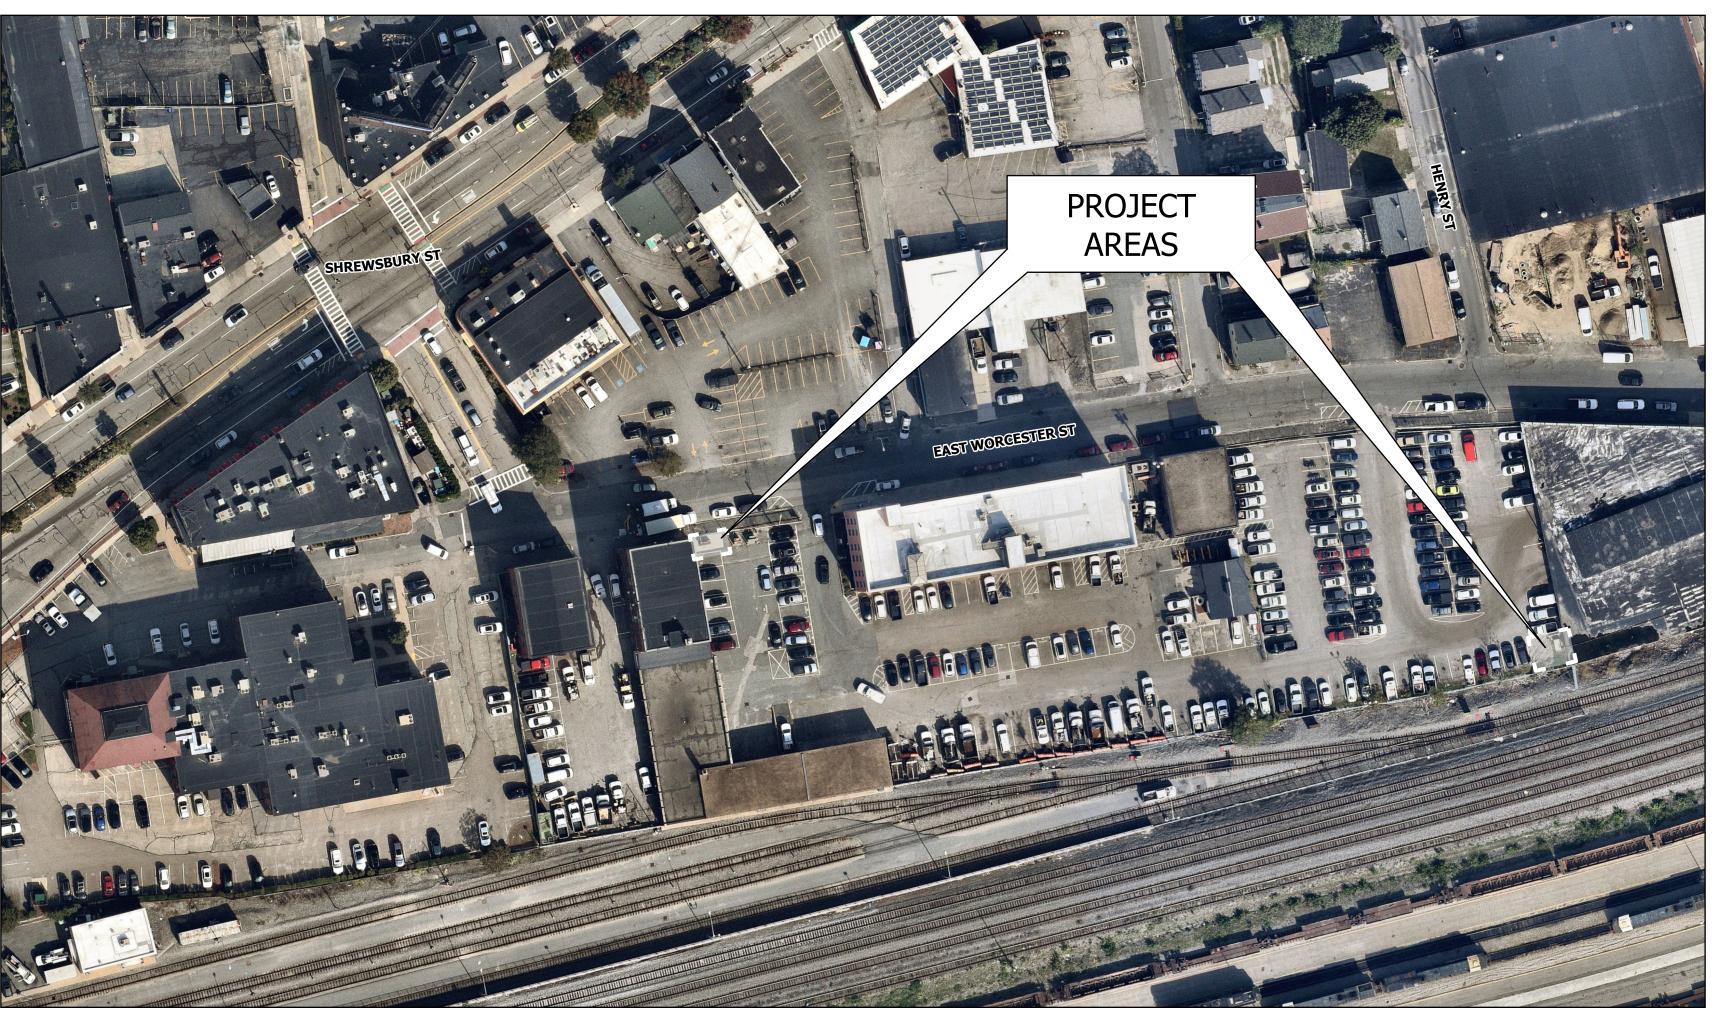

LOCUS MAP SCALE 1:1000

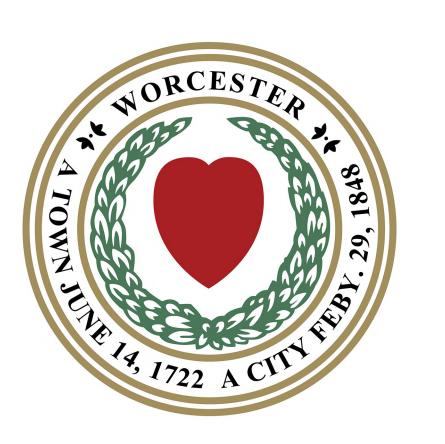


DRAWING INDEX 18-20 E. WORCESTER STREET

E000 ELECTRICAL LEGEND
E001 ELECTRICAL LEGEND, NOTES AND ABBREVIATIONS
E110 ELECTRICAL SITE POWER DEMOLITION PLAN
E111 ELECTRICAL SITE POWER PLAN
E700 EXISTING ELECTRICAL RISER DIAGRAM
E900 ELECTRICAL SCHEDULES AND DETAILS

76 E. WORCESTER STREET

E000 ELECTRICAL LEGEND
E111 ELECTRICAL LEVEL 1 POWER DEMOLITION PLAN
E311 ELECTRICAL LEVEL 1 POWER PLAN
E700 ELECTRICAL SCHEDULES AND RISER DIAGRAM
E900 ELECTRICAL DETAILS
P000 PLUMBING LEGEND, NOTES AND ABBREVIATIONS
P101 PLUMBING GAS DEMOLITION PLANS

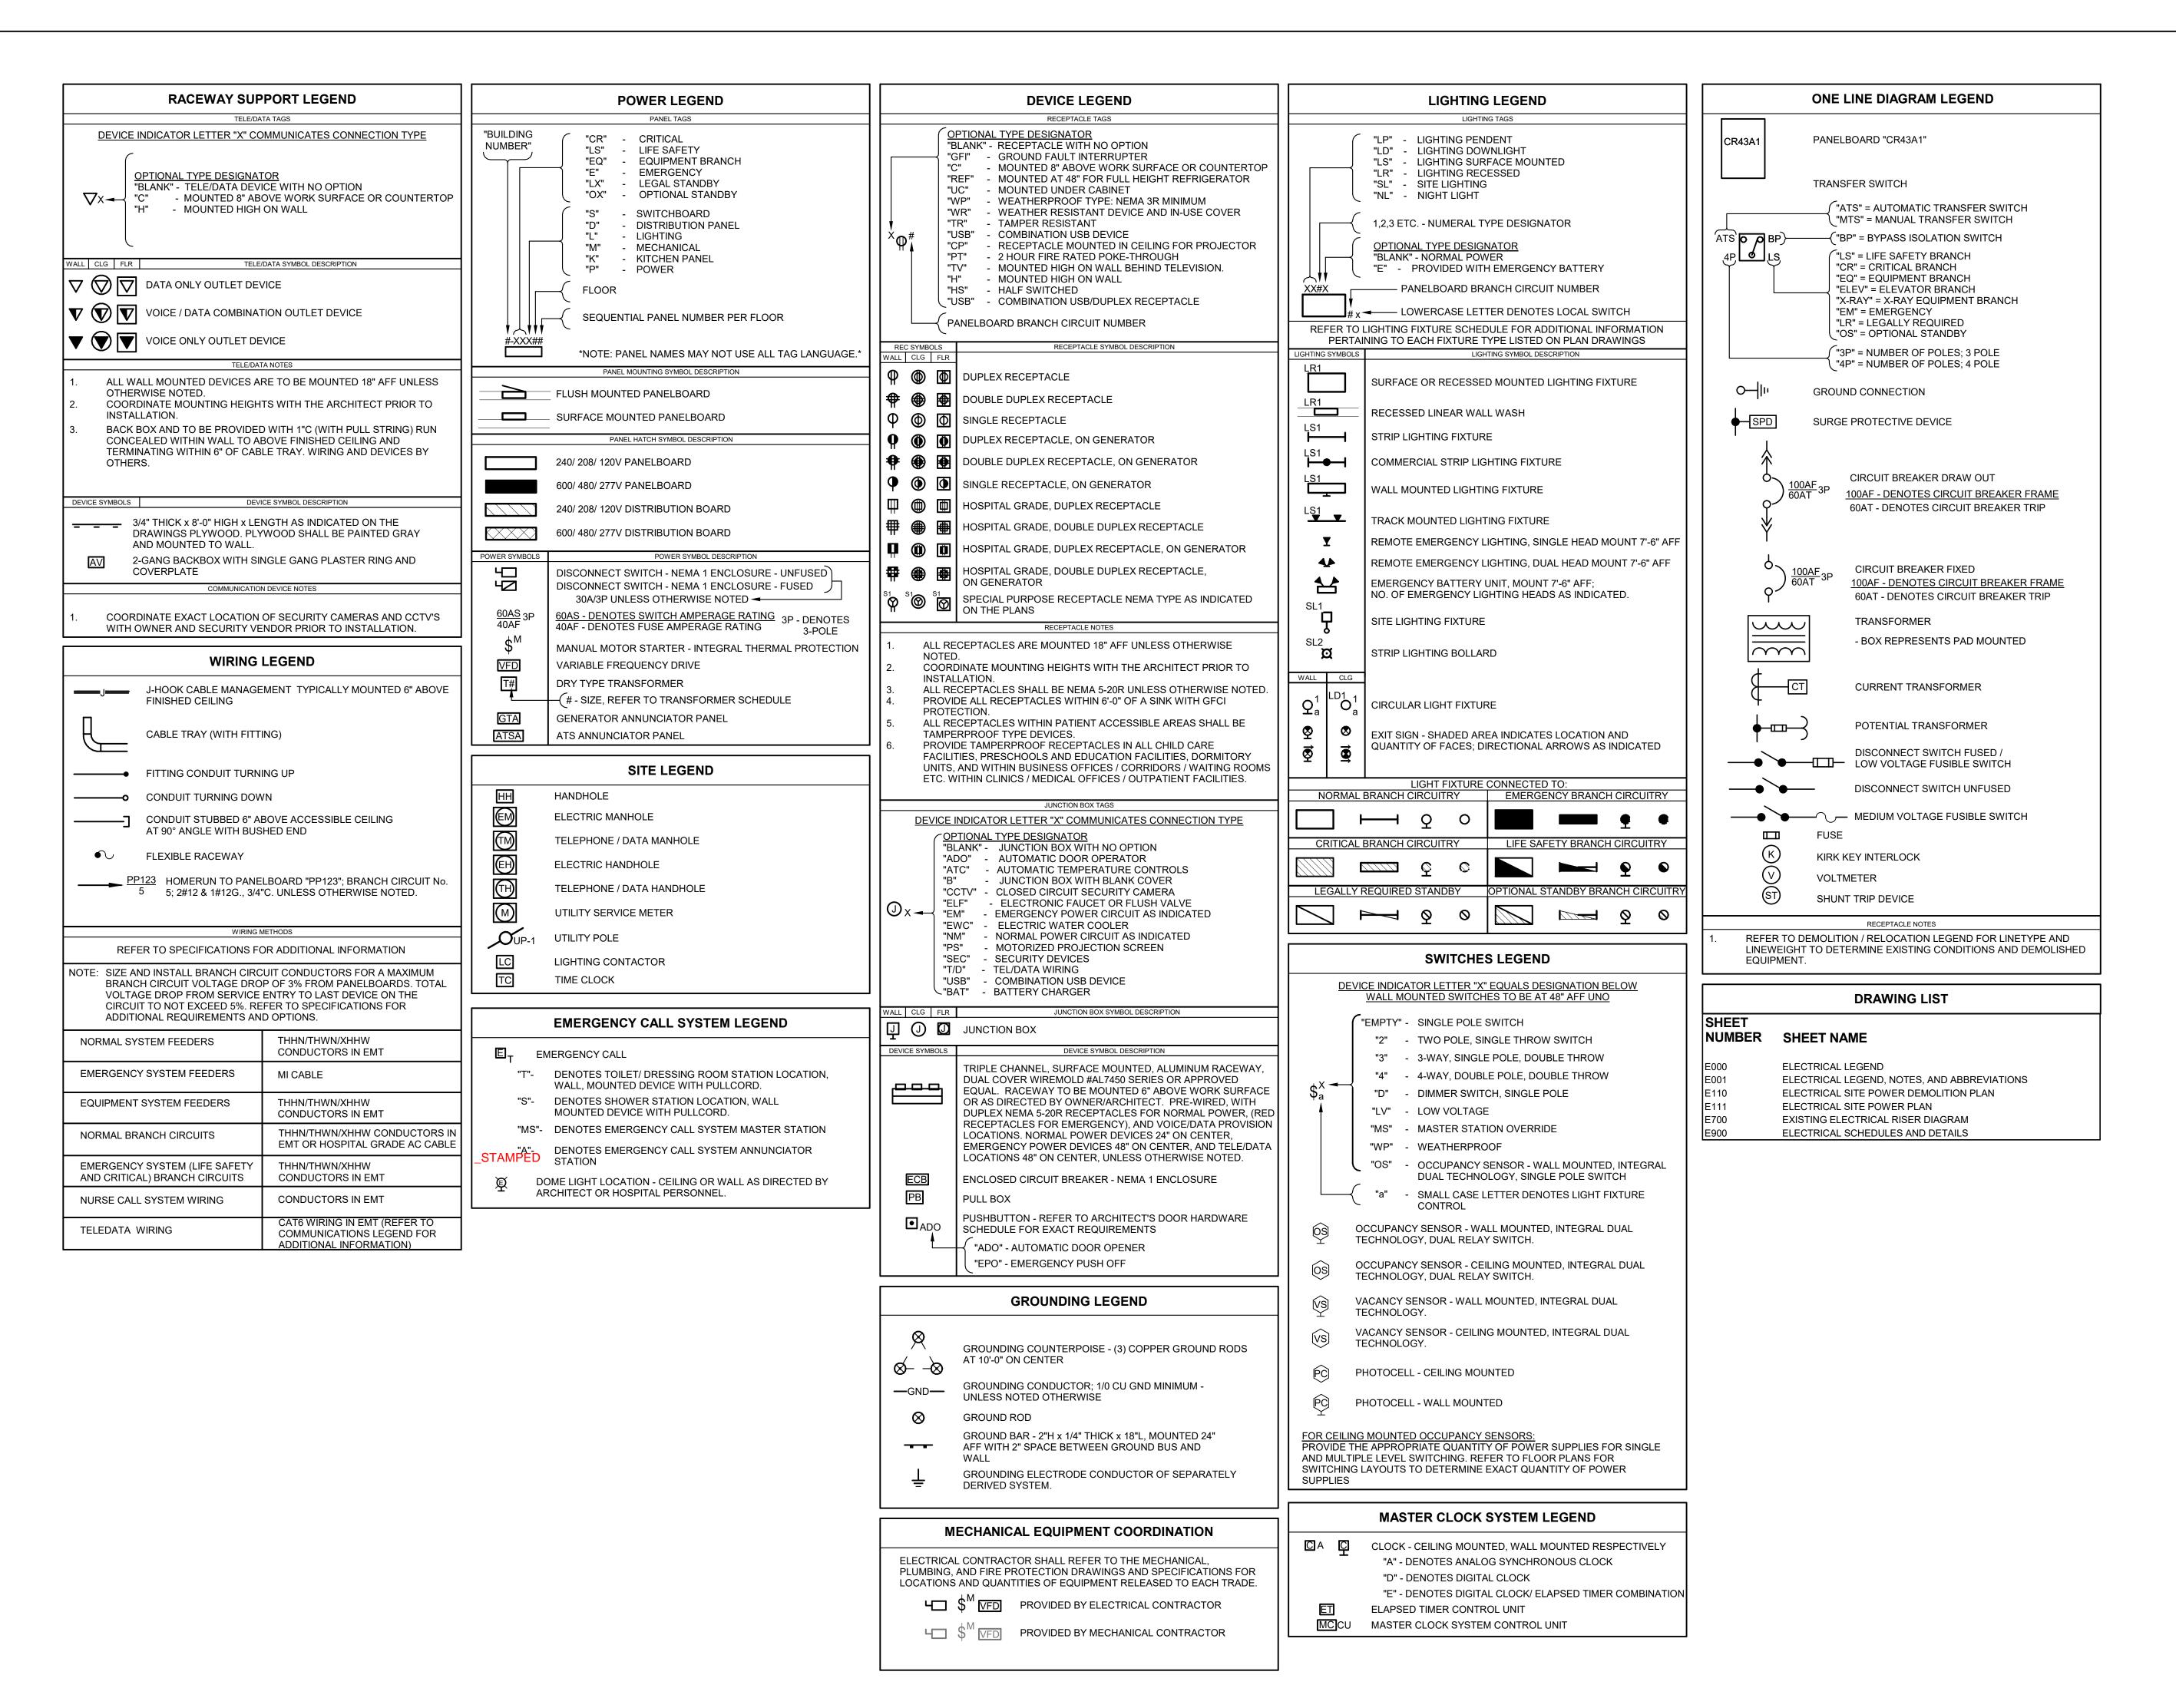

THIS IS A STANDARD SYMBOL LIST. ALL DEVICE SYMBOLS AND ABBREVIATIONS MAY NOT NECESSARILY APPEAR ON THE DESIGN PLANS OR DETAIL SHEETS. ONLY THOSE SYMBOLS INDICATED ON THE DESIGN PLANS ARE USED AND OTHERS SHOULD BE DISREGARDED.

300 Unicorn Park Drive, 5th Floor Woburn, Ma 01801 (P) 781.481.0210 (F) 781.481.0203 Key Plan: CITY OF WORCESTER Project Name: Worcester-MA 18-20 E **Worcester St - Gen** Worcester, MA Rev. Description Drawing Title: ELECTRICAL LEGEND 03/28/2025 Date Scale Drawn By Checked By 210538.13 Project Number Drawing No.

AFFECTED. ARE IN PLACE.

DEMOLITION GENERAL NOTES PROJECT GENERAL NOTES **ABBREVIATIONS** REFER TO THE ARCHITECTURAL DRAWINGS FOR THE FULL EXTENT OF FURNISH LABOR, MATERIALS, TOOLS, AND OTHER EQUIPMENT THE SCOPE OF DEMOLITION. DISCONNECT AND MAKE SAFE ALL REQUIRED TO INSTALL THE WORK SHOWN AND SPECIFIED. FURNISH ELECTRICAL EQUIPMENT IDENTIFIED FOR REMOVAL ON THE ACOUSTICAL CEILING TILE AND INSTALL ITEMS NECESSARY FOR A COMPLETE ELECTRICAL ARCHITECTURAL, HVAC, PLUMBING AND FIRE PROTECTION PLANS. AMPERE FRAME SYSTEM. MATERIALS SHALL BE NEW AND BEAR THE REGISTERED UL ARC-FAULT CIRCUIT INTERRUPTER THE ELECTRICAL SCOPE MAY EXTEND BEYOND THE AREA DEFINED BY MARK. WORK SHALL CONFORM WITH THE NATIONAL FIRE PROTECTION ABOVE FINISHED FLOOR THE ARCHITECTURAL DEMOLITION LIMITS TO FULLY COMPLY WITH ASSOCIATION STANDARD 70 (NEC), AND APPLICABLE FEDERAL, STATE ABOVE FINISHED GRADE THE VARIOUS REQUIREMENTS DEFINED BY THESE NOTES. AND LOCAL CODES. SECURE PERMITS AND PAY THE FEES REQUIRED ARC FAULT REDUCTION TO CARRY OUT THE WORK. FURNISH COPIES OF CERTIFICATES AND AMPERE INTERRUPTING CAPACITY THE ELECTRICAL DEMOLITION PLANS INDICATE THE GENERAL INTENT PERMITS TO THE ARCHITECT. ARC-FAULT CIRCUIT INTERRUPTER AND ARE NOT INTENDED TO SHOW ALL COMPONENTS AND ITEMS TO ABOVE FINISHED FLOOR BE REMOVED OR RETAINED. THE ELECTRICAL CONTRACTOR SHALL ABOVE FINISHED GRADE THE DRAWINGS AND SPECIFICATIONS INDICATE THE INTENT OF THE VISIT THE SITE PRIOR TO SUBMISSION OF THEIR BID TO BECOME ARCH ARCHITECTURE DESIGN AND ARE CONSIDERED AS DIAGRAMMATIC ONLY. DETERMINE FAMILIAR WITH THE ACTUAL WORKING CONDITIONS AND EXTENT OF AMPERE TRIP EXACT LOCATIONS FOR OUTLETS AND EQUIPMENT ON SITE AS WORK WORK, DISCONNECT AND MAKE SAFE DEVICES AND EQUIPMENT AUTOMATIC TEMPERATURE CONTROL PROGRESSES. CHECK AND VERIFY DIMENSIONS AND CONDITIONS ON LOCATED ON WALLS AND/OR CEILINGS DESIGNATED TO BE REMOVED. AUTOMATIC TRANSFER SWITCH SITE. DOCUMENT FINAL WORK ON AS-BUILT RECORD DRAWINGS. THE ELECTRICAL CONTRACTOR SHALL IMMEDIATELY NOTIFY THE AMERICAN WIRE GAUGE AWG CIRCUIT NUMBERS ARE FOR DESCRIPTIVE PURPOSES ONLY. EXACT OWNER'S REPRESENTATIVE OF ANY UNANTICIPATED OR HIDDEN NUMBERS TO BE DETERMINED IN THE FIELD AND NOTED ON THE BUILDING CONDITIONS ENCOUNTERED DURING DEMOLITION. CONTRACTOR AS BUILTS. BONDING JUMPER BRANCH THE ELECTRICAL CONTRACTOR SHALL BE RESPONSIBLE FOR THE COORDINATE AND MAINTAIN THE CLEARANCES REQUIRED BY REPAIR OF ALL SYSTEMS OR BUILDING COMPONENTS DAMAGED APPLICABLE FEDERAL, STATE AND LOCAL CODES FOR ALL PIPING, CONDUIT - RACEWAY DURING THE EXECUTION OF THE WORK. DAMAGE SHALL INCLUDE, CONDUITS AND EQUIPMENT OF ALL TRADES. CATALOG BUT NOT BE LIMITED TO, THE DESTRUCTION OR DISPOSAL OF ITEMS CIRCUIT BREAKER INTENDED TO REMAIN OR BE SALVAGED. CONDUIT RUNS CROSSING EXPANSION JOINTS SHALL HAVE CANDELA EXPANSION OR EXPANSION DEFLECTION TYPE FITTINGS AS REQUIRED. TRACE AND LABEL ALL EXISTING BRANCH CIRCUITS AND FEEDERS CABLE MANAGEMENT SYSTEM VERIFY EXISTING JOINTS BY FIELD MEASUREMENTS. WITHIN OR ASSOCIATED WITH THE AREA OF DEMOLITION SCOPE CEILING PRIOR TO DE-ENERGIZING AND DISCONNECTION. TRACE AND LABEL RUN RACEWAYS AND CABLES CONCEALED IN FINISHED SPACES COLUMN ALL CIRCUITS WITHIN PANELBOARDS IDENTIFIED FOR REMOVAL TO CONCRETE MASONRY UNIT UNLESS OTHERWISE NOTED. ENSURE THAT NO AREA OUTSIDE THE DEMOLITION SCOPE LIMIT IS CURRENT TRANSFORMER OR CABLE TRAY PROVIDE PANELBOARDS WITH DEDICATED SPACE EXTENDING FROM CWS CONDUIT WALL SEAL THE FLOOR TO THE STRUCTURAL CEILING WITH A WIDTH AND DEPTH IDENTIFY ALL BRANCH CIRCUITS, FEEDERS AND SYSTEM OF THE EQUIPMENT, INCLUDING ANY ADDITIONAL SPACE DESCRIBED IN COMPONENTS WHICH ARE TO REMAIN WITHIN THE AREA OF DUAL ELEMENT TIME DELAY THE NEC. NO PIPING, DUCTS OR EQUIPMENT FOREIGN TO THE DEMOLITION SCOPE. THERE SHALL BE NO INTERRUPTION OF SERVICE ELECTRICAL EQUIPMENT OR ARCHITECTURAL APPURTENANCES SHALL TO ANY AREA OUTSIDE THE SCOPE LIMITS WITHOUT APPROVAL FROM DISTRIBUTION PANEL BE PERMITTED TO BE INSTALLED IN, ENTER OR PASS THROUGH SUCH THE OWNER'S REPRESENTATIVE. LEAVE EXISTING EQUIPMENT TO DRAWING REMAIN IN A CODE COMPLIANT CONDITION. MOUNT PANELBOARD SO THAT THE DISTANCE FROM THE TOP CIRCUIT ELECTRICAL CONTRACTOR DE-ENERGIZE AND REMOVE ALL CONDUCTORS AND RACEWAYS TO BREAKER OPERATING HANDLE TO THE FLOOR SHALL NOT EXCEED EQUIPMENT GROUND CONTRACTOR THEIR POINTS OF ORIGIN WITHIN THE AREA OF DEMOLITION SCOPE. ELECTRICAL DO NOT ABANDON IN PLACE ITEMS IDENTIFIED FOR DEMOLITION ELEVATOR RACEWAYS THAT ENTER MASONRY WALLS AND FLOORS SHALL BE ALL BRANCH CIRCUITS SHALL HAVE A DEDICATED NEUTRAL **EMERGENCY** CUT FLUSH AT THE SURFACE FOR PATCHING BY OTHERS. DE-**ENERGY MANAGEMENT SYSTEM** CONDUCTOR. COMMON NEUTRALS WILL NOT BE ALLOWED. ENERGIZE AND LABEL ALL CIRCUIT BREAKERS ASSOCIATED WITH THE ELECTRICAL METALLIC TUBING DEMOLITION AS SPARE. OUTDOOR ELECTRICAL EQUIPMENT SHALL BE NEMA 3R TYPE, UNLESS ELECTRICALLY OPERATED ENVIRONMENTAL PROTECTION AGENCY OTHERWISE NOTED. TEMPORARILY SUPPORT ALL ITEMS TO REMAIN THAT ARE AFFECTED **EQUIPMENT** BY THE DEMOLITION OF BUILDING STRUCTURAL COMPONENTS ELECTRIC WATER COOLER FURNISH GROUNDING/ BONDING BUSHINGS ONTO ALL CONDUIT (WALLS, CEILINGS, ETC.). PERMANENTLY SUPPORT AND INSTALL EXPLOSION PROOF ENTERING/LEAVING BOXES. TEMPORARILY SUPPORTED ITEMS WHEN FINALIZED STRUCTURES FIRE ALARM FIRE ALARM ANNUNCIATOR WHERE PANELS ARE INDICATED TO BE RELOCATED, TRACE OUT EACH FLOUR FLUORESCENT CIRCUIT TO DETERMINE WHAT CIRCUITS FEED AREAS OUTSIDE THE 3. LEGALLY DISPOSE OF ALL REMOVED ITEMS UNLESS IDENTIFIED FOR FACILITIES MANAGEMENT SYSTEM SCOPE OF WORK. RE-ROUTE CIRCUITS WHICH MUST BE MAINTAINED REUSE. THE OWNER'S REPRESENTATIVE SHALL INSPECT ALL TO THE NEW PANEL LOCATION BY PROVIDING AN ADEQUATELY SIZED RETAINED ITEMS PRIOR TO PLACEMENT IN THE IDENTIFIED STORAGE FUSE PULL BOX AND SPLICING AND EXTENDING THE CONDUCTORS. LOCATION BY THE ELECTRICAL CONTRACTOR. GROUND CURRENT CARRYING MATERIAL USED SHALL BE COPPER, INCLUDING . INCLUDE IN THIS CONTRACT ALL DEMOLITION SCOPE ASSOCIATED PANELBOARD BUS MATERIALS AND TRANSFORMER WINDINGS. WITH LOW VOLTAGE SYSTEMS INCLUDING BUT NOT LIMITED TO GENERAL CONTRACTOR GENERATOR TELEPHONE, DATA, SECURITY, PAGING, CCTV, ETC... GROUND FAULT GROUND FAULT INTERRUPTER 10. RECYCLE, BY A FACILITY APPROVED BY THE OWNER'S GROUND FAULT CIRCUIT INTERRUPTER REPRESENTATIVE, REMOVED FLUORESCENT AND HID LAMPS AND GROUND BATTERIES. PREPARE A UNIFORM HAZARDOUS WASTE MANIFEST FOR GYPSUM WALL BOARD ALL DISPOSALS AND RETURN WITH ALL APPLICABLE SIGN-OFFS PRIOR TO APPLICATION FOR FINAL PAYMENT. HIGH INTENSITY DISCHARGE HAND-OFF-AUTO 11. VERIFY ALL BALLASTS IN LIGHTING FIXTURES TO BE DISPOSED OF ARE HORSE POWER PCB FREE. CONSIDER ALL BALLASTS MANUFACTURED PRIOR TO 1979 AND NOT LABELED AS PCB FREE TO CONTAIN PCBs. PROVIDE HEATER WRITTEN REPRESENTATION TO THE OWNER'S REPRESENTATIVE HVAC HEATING, VENTILATION & AIR CONDITIONING THAT CONFIRMS PCB FREE WASTE. WHERE PCB FREE WASTE CANNOT BE VERIFIED, BALLASTS SHALL BE RECYCLED BY A FACILITY APPROVED BY THE OWNER'S REPRESENTATIVE, WITH PCB INTERRUPTING CAPACITY COMPONENTS ELIMINATED BY A HIGH TEMPERATURE INCINERATION. INCANDESCENT PREPARE A UNIFORM HAZARDOUS WASTE MANIFEST FOR ALL INTERMEDIATE METAL CONDUIT DISPOSALS AND RETURN WITH ALL APPLICABLE SIGNOFFS PRIOR TO JUNCTION BOX APPLICATION FOR FINAL PAYMENT. ALL HANDLING SHALL CONFORM TO EPA REQUIREMENTS. THOUSAND AMPERES INTERRUPTING CAPACITY KCMIL THOUSAND CIRCULAR MILS 12. WORK MAY BE REQUIRED OUTSIDE OF THE PROJECT'S AREA OF KITCHEN EQUIPMENT CONTRACTOR RENOVATION. CONTRACTOR SHALL NOT ASSUME THAT AREA OF KILOVOLTS RENOVATION IS CONSIDERED THE SCOPE OF WORK AREA. KILOVOLT AMPERES kVAR KILOVOLT AMPERES REACTIVE KILOWATTS kWH KILOWATTS HOURS DEMOLITION / RELOCATION LEGEND LONG TIME, SHORT TIME, INSTANTANEOUS, GROUND MAX MAXIMUM EXISTING ELECTRICAL EQUIPMENT, DEVICE AND/OR FIXTURE METAL CLAD CABLE TO REMAIN MAIN CIRCUIT BREAKER MOTOR CONTROL CENTER MCP EXISTING ELECTRICAL EQUIPMENT, DEVICE AND/OR FIXTURE TO MOTOR CIRCUIT PROTECTOR MCSW MOLDED CASE SWITCH BE SELECTIVELY DEMOLISHED MAIN DISTRIBUTION PANEL MDP MECH MECHANICAL MEP MECHANICAL/ELECTRICAL/PLUMBING EXISTING ELECTRICAL EQUIPMENT DEVICE AND/OR FIXTURE TO BE REMOVED AND TURNED OVER TO OWNER FOR RE-USE MISCELLANEOUS MOUNTED EXISTING ELECTRICAL EQUIPMENT, DEVICE AND/OR FIXTURE MOUNTING MEDIUM VOLTAGE TO BE REMOVED, STORED AND RE-LOCATED. MAIN LUGS ONLY NEUTRAL (GROUNDED CONDUCTOR) EXISTING ELECTRICAL EQUIPMENT, DEVICE AND/OR FIXTURE NOT APPLICABLE INDICATED IN NEW LOCATION NORMALLY CLOSED NATIONAL ELECTRICAL CODE NEMA NATIONAL ELECTRICAL MANUFACTURERS ASSOCIATION EXISTING ELECTRICAL EQUIPMENT, DEVICE SHALL BE REMOVED NFPA NATIONAL FIRE PROTECTION ASSOCIATION AND REPLACED WITH NEW; MAINTAIN EXISTING BOX, RACEWAY NOT IN CONTRACT AND WIRING. NIGHT LIGHT NORMALLY OPEN DEMOLITION / RELOCATION NOTES NTS NOT TO SCALE PHASE LABELS SHOWN ABOVE ARE APPLIED IN SELECT AREAS AND MAY NOT OCPD OVER CURRENT PROTECTION DEVICE ALWAYS BE PRESENT. REFER TO LINETYPE AND LINEWEIGHT TO DETERMINE EXISTING CONDITIONS AND DEMOLISHED EQUIPMENT. PNLBD PANEL BOARD PROVIDE UNDER OTHER SECTIONS POTENTIAL TRANSFORMER POLYVINYL CHLORIDE RACEWAY GALVANIZED RIGID STEEL CONDUIT RIGID METAL CONDUIT RIGID NON-METAL CONDUIT RIGID STEEL CONDUIT SATS STANDBY AUTOMATIC TRANSFER SWITCH SERVICE ENTRANCE SWITCH SWITCHBOARD SWGR SWITCH GEAR TELEPHONE TWIST LOCK TWISTED PAIR

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TRANS

TRANSFORMER

WEATHERPROOF

VOLT WITH

DELTA WYE

TWISTED SHIELDED PAIR

FITZEMEYER & TOCCI ASSOCIATES, INC. 300 Unicorn Park Drive, 5th Floor Woburn, Ma 01801 (P) 781.481.0210 (F) 781.481.0203					
Key Plan:					
Owner: CITY OF WORCESTER					
Project Name: Worcester-MA 18-20 E Worcester St - Gen Worcester, MA					
North Arrow Stamp: MICHAEL Y. PANG ELECTRICAL NO. 48461 03/28/2025					
Rev. Description Date					
Scale Bar:					
Drawing Title:					
ELECTRICAL LEGEND, NOTES, AND ABBREVIATIONS					

Scale

Drawn By


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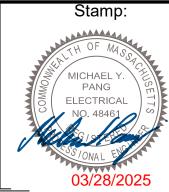
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Project Number


03/28/2025


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Date	03/28/2025
Scale	AS NOTED
Drawn By	НК
Checked By	MP
Proiect Number	210520 12



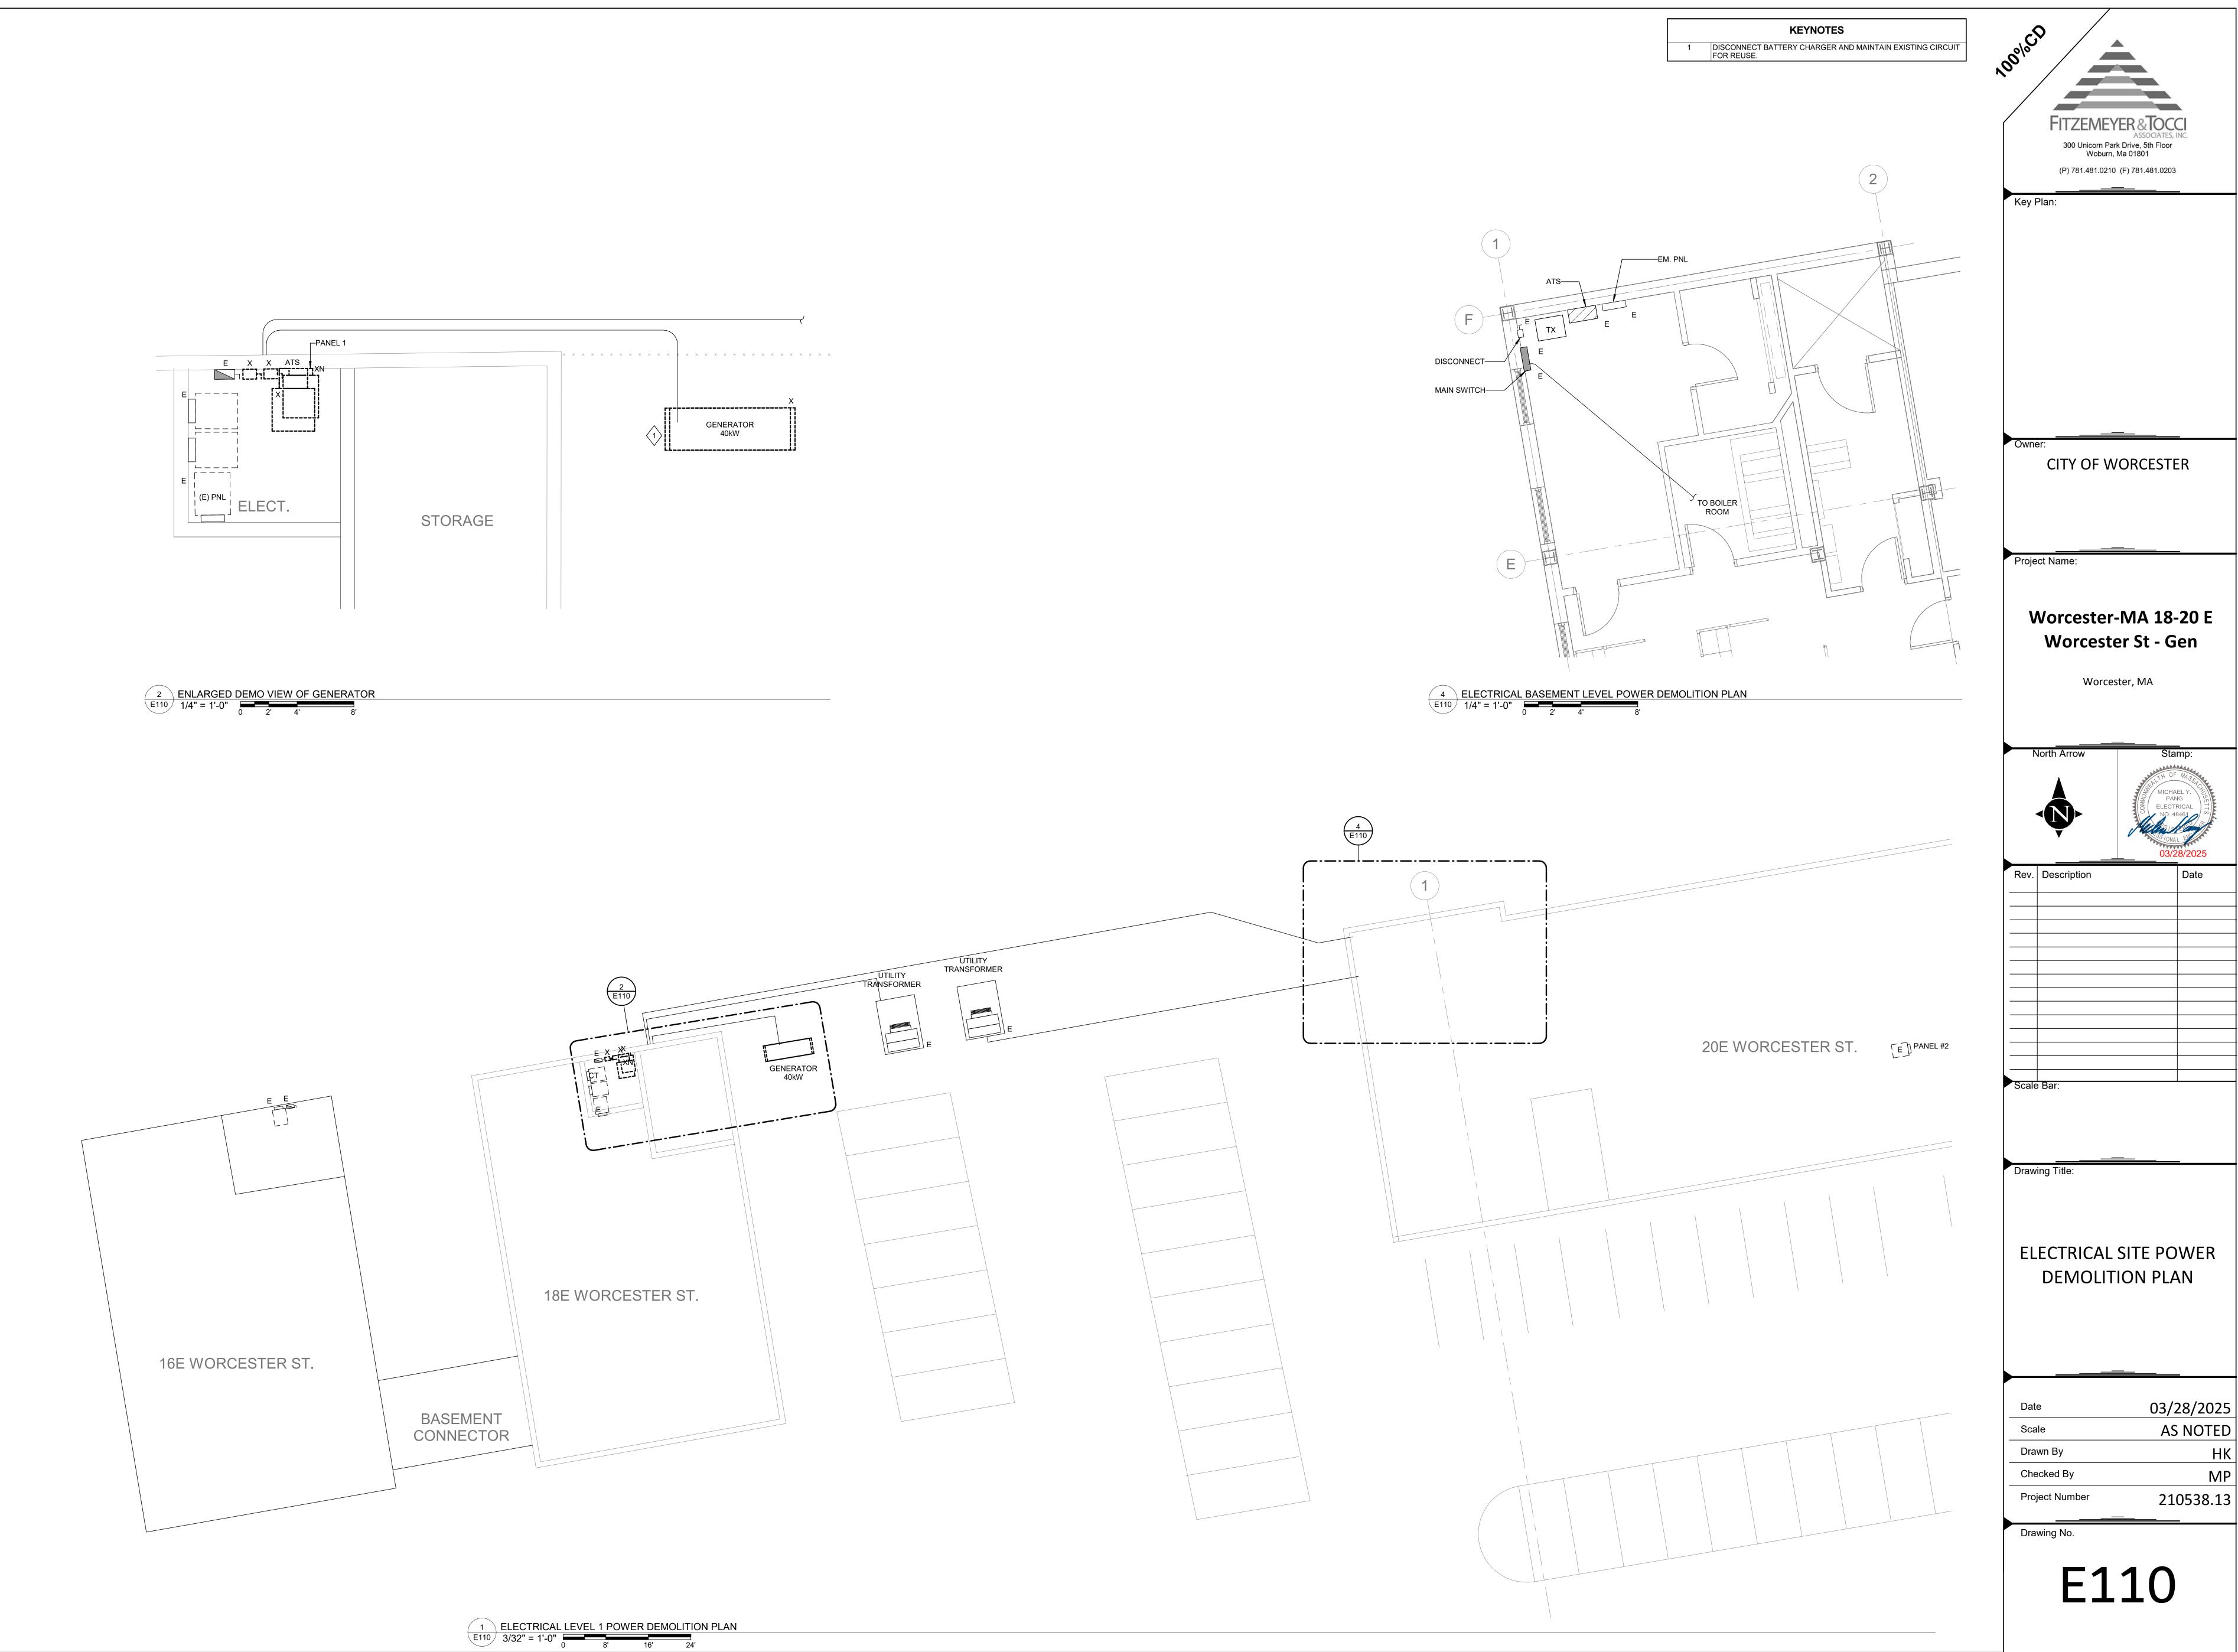

LEGEND OF FEEDER SIZES

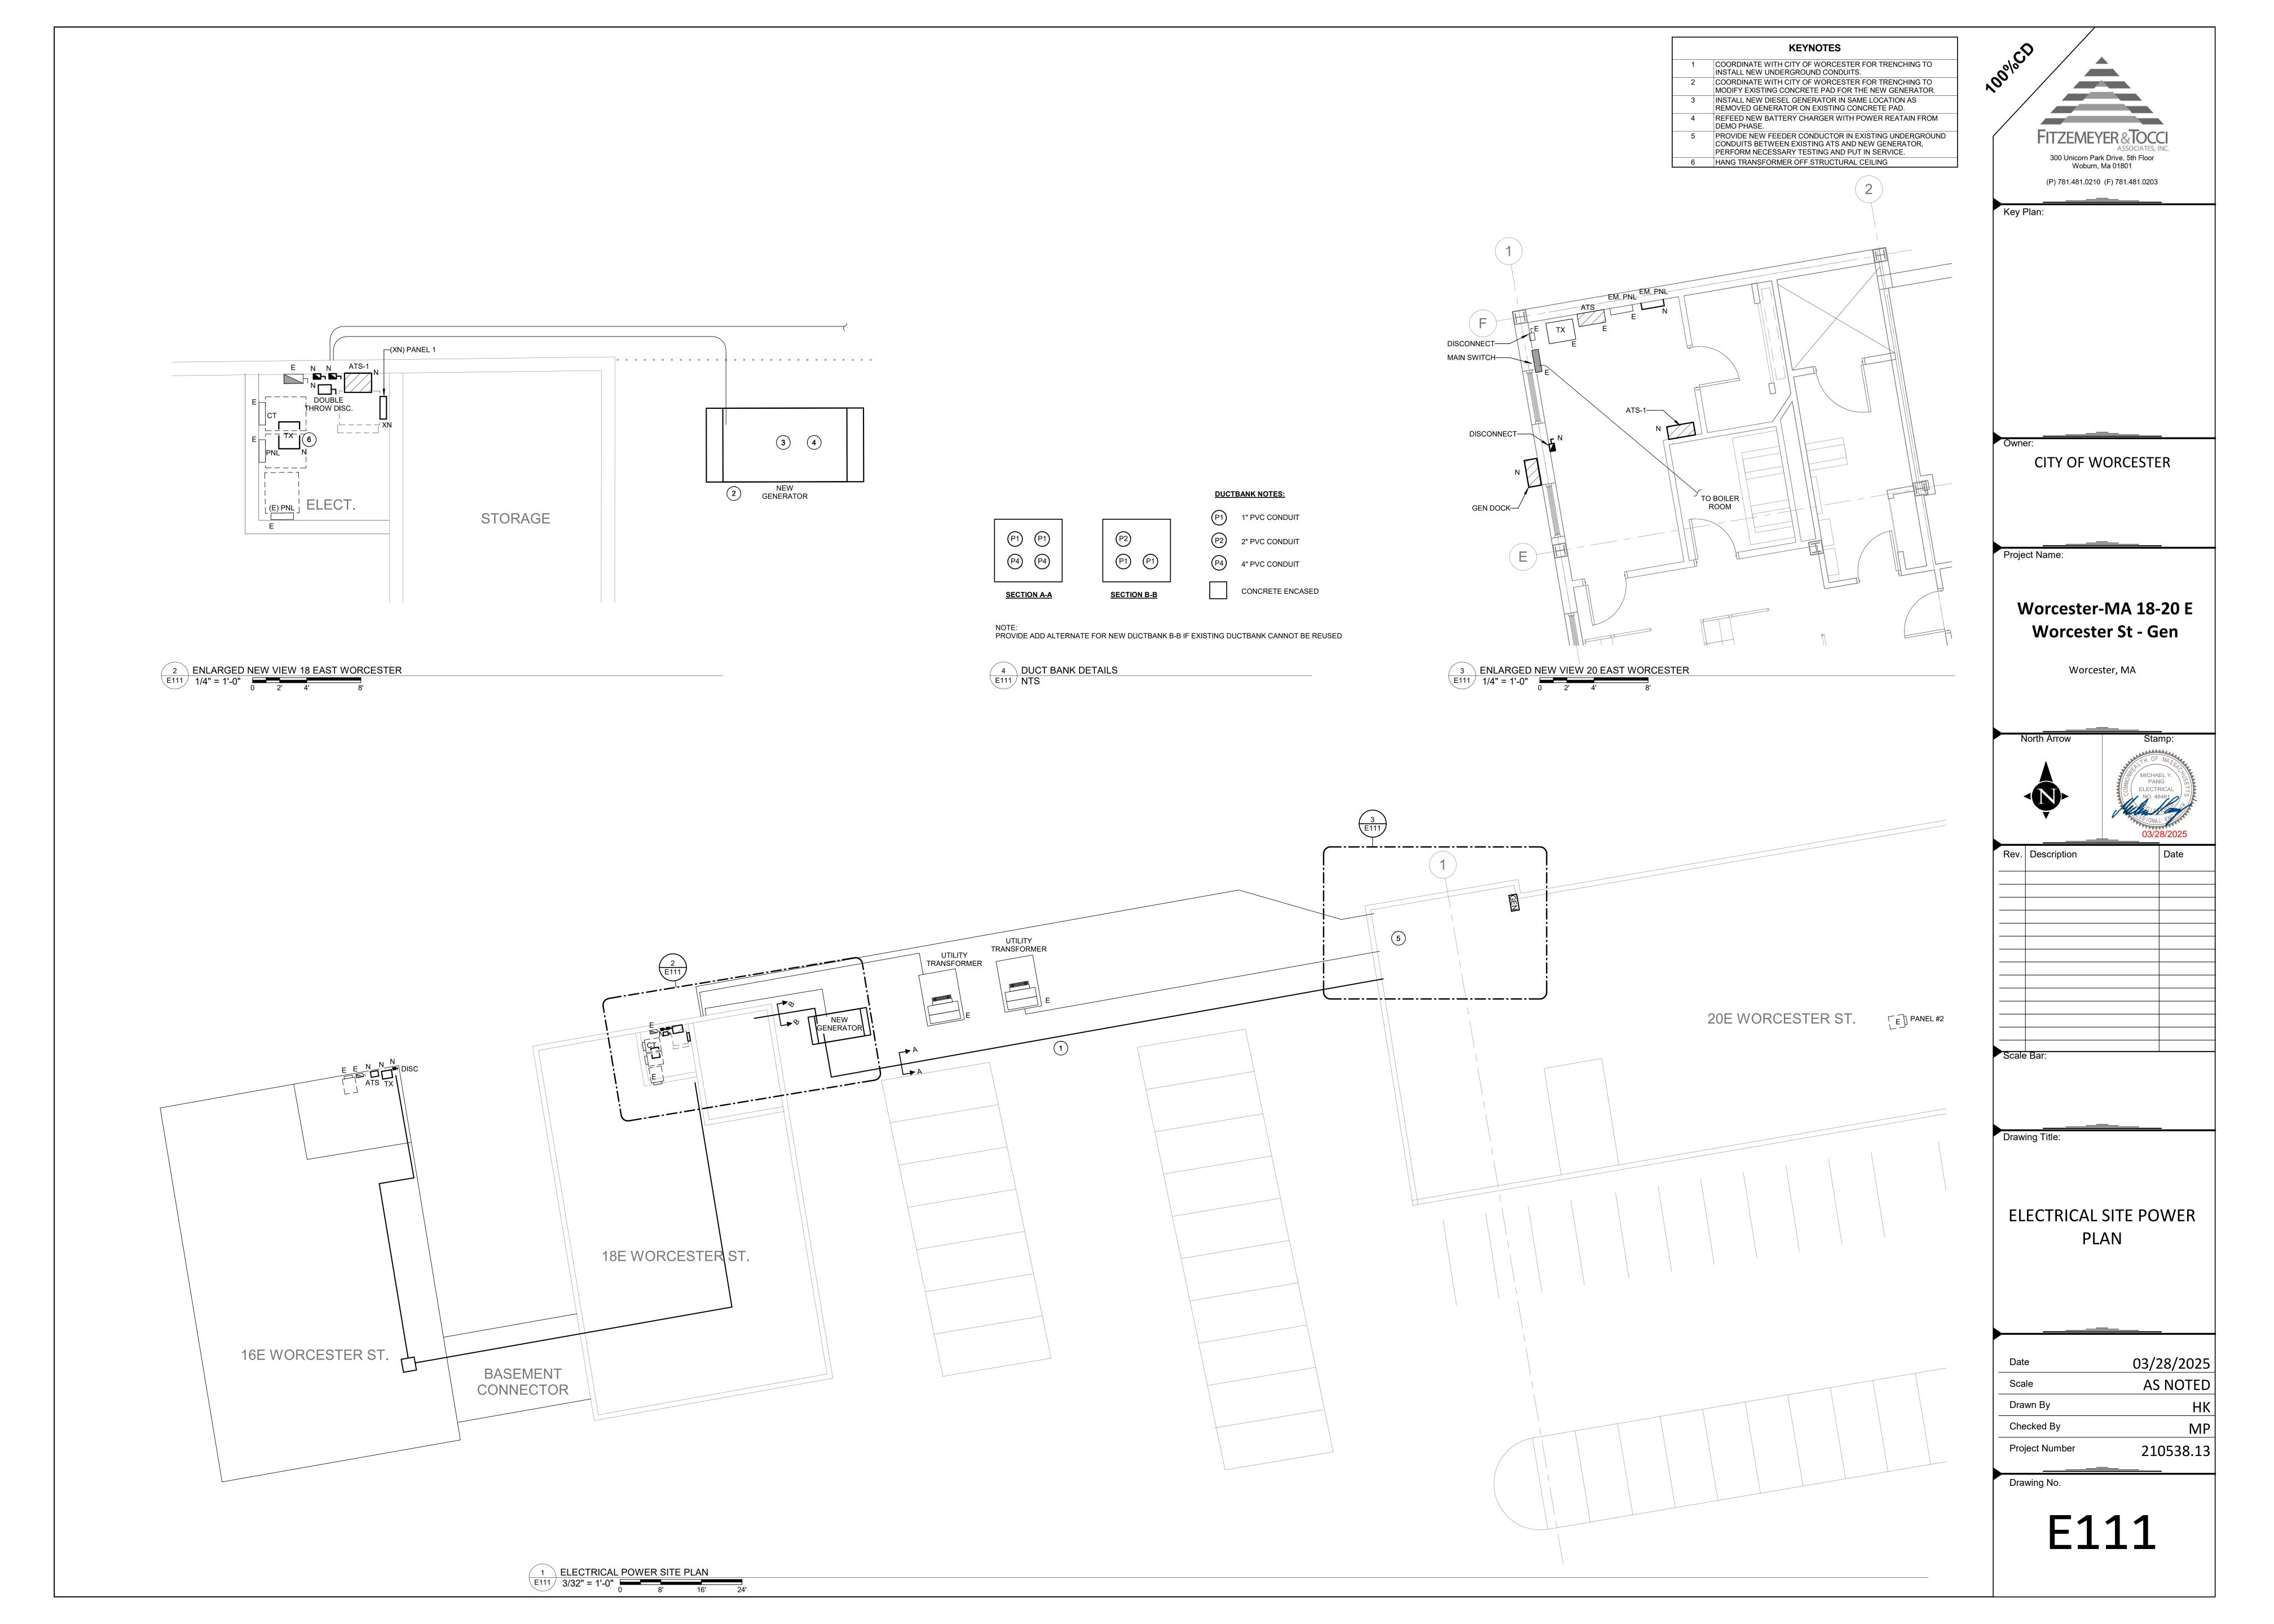COPPER CONDUCTORS

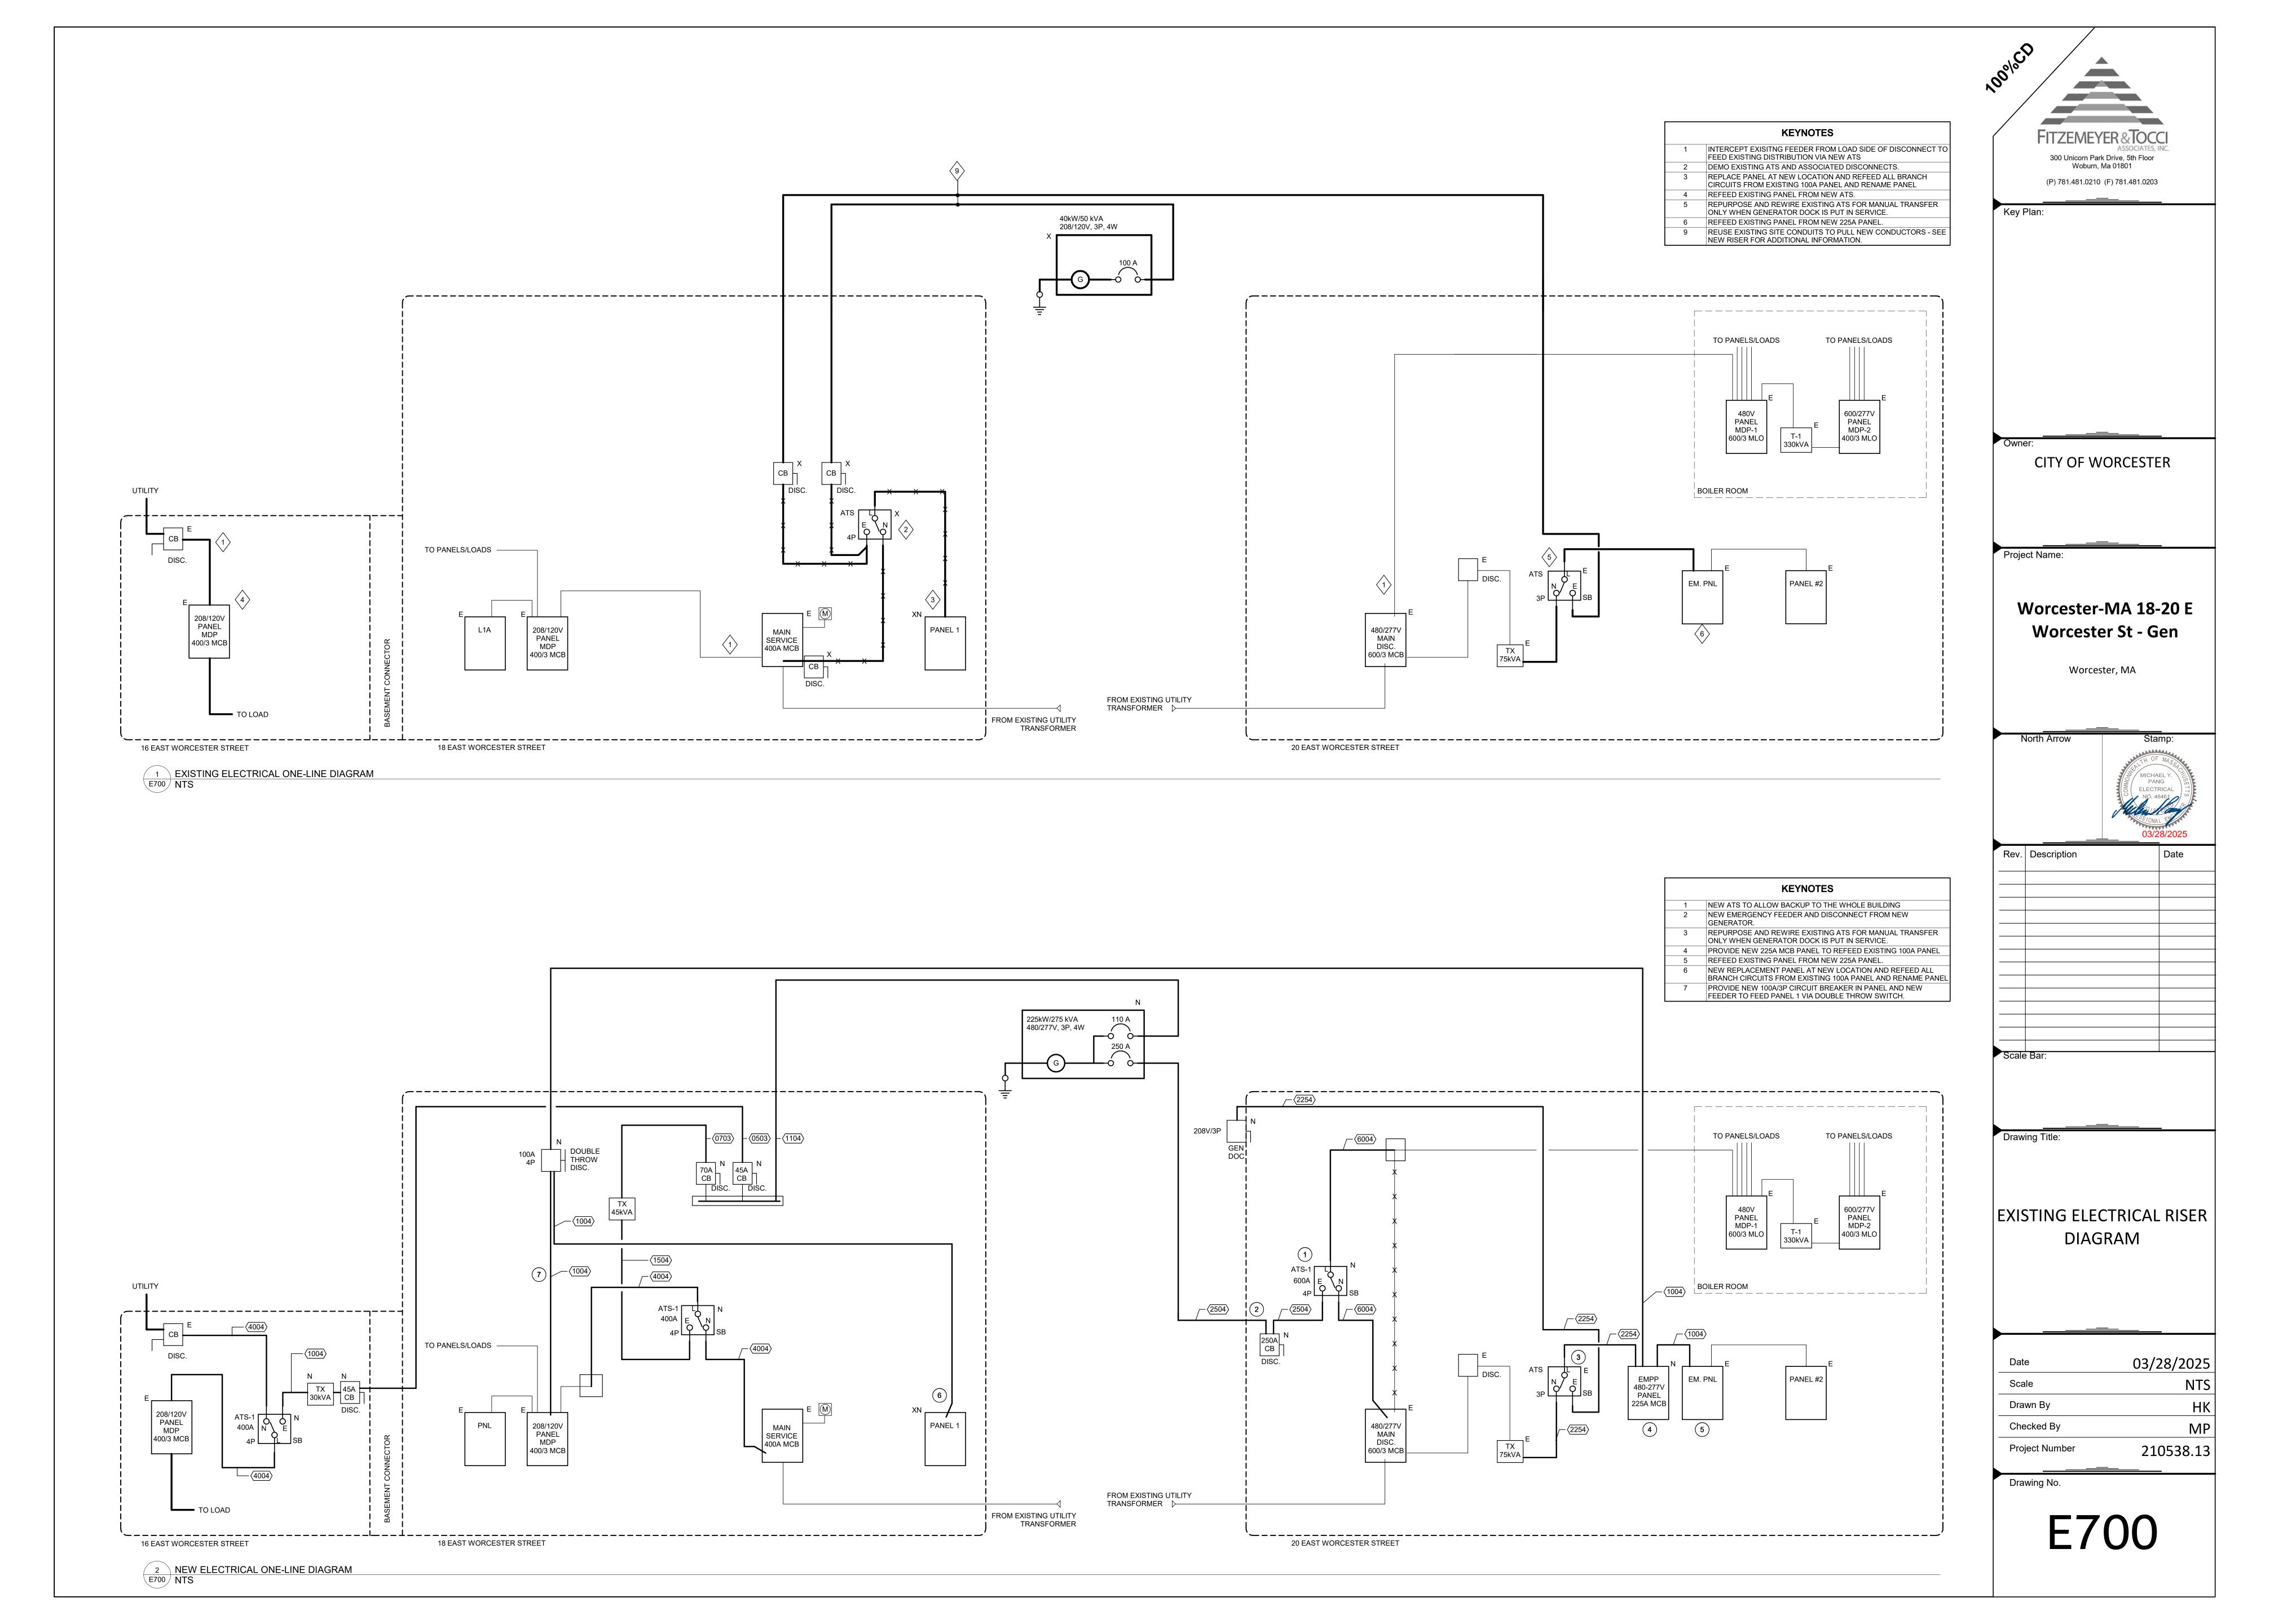
1. ALL CONDUCTOR SIZES ARE FOR COPPER CONDUCTORS NEC TABLE 310.16(2020); 75 DEGREE C.

ANNEX C.
3. 600 KCMIL FEEDERS SHALL BE PROVIDED WITH MAC ADAPTERS AS REQUIRED TO COORDINATE WITH BREAKER LUG

4.SEE SPECIFICATIONS FOR ACCEPTABLE CONDUCTOR TYPES.
5.CONTRACTOR SHALL PROVIDE PRICING INFORMATION FOR USE OF ALUMINUM FEEDERS AS ADD ALTERNATE #.

FEEDER SYMBOL	CONDUCTORS (3PH, 3W) WITH GROUND	RACEWAY SIZE	CONDUCTORS (3PH, 4W) WITH GROUND	RACEWAY SIZE	NOMINA AMPERI	
(TX)	ı	REFER TO DRY T	YPE TRANSFORMER SCHEDU	LE	_ I	
(0703)	3#4 & 1#8G	1"			70	
(0704)			4#4 & 1#8G	1 1/4"	70	
(0803)	3#4 & 1#8G	1"			90	
(0804)			4#4 & 1#8G	1 1/4"	80	
(0903)	3#3 & 1#8G	1 1/4"			90	
(0904)			4#3 & 1#8G	1 1/4"	7 90	
(1003)	3#3 & 1#8G	1 1/4"			100	
⟨1004⟩			4#3 & 1#8G	1 1/4"		
(1103)	3#2 & 1#6G	1 1/4"			110	
⟨1104 ⟩			4#2 & 1#6G	1 1/4"		
(1253)	3#1 & 1#6G	1 1/4"			125	
(1254)			4#1 & 1#6G	1 1/2"	7 125	
(1503)	3#1/0 & 1#6G	1 1/2"			150	
(1504)			4#1/0 & 1#6G	2"		
(1753)	3#2/0 & 1#6G	2"			175	
(1754)			4#2/0 & 1#6G	2"		
(2003)	3#3/0 & 1#6G	2"			200	
(2004)			4#3/0 & 1#6G	2"	7 200	
(2253)	3#4/0 & 1#4G	2"			225	
(2254)			4#4/0 & 1#4G	2 1/2"	223	
(2503)	3#250 KCMIL & 1#4G	2 1/2"			250	
\(\) 2504\(\)			4#250 KCMIL & 1#4G	2 1/2"	230	
(3003)	3#350 KCMIL & 1#4G	3"			300	
⟨3004⟩			4#350 KCMIL & 1#4G	3"	7 300	
(3503)	3#500 KCMIL & 1#3G	3"			350	
(3504)			4#500 KCMIL & 1#3G	3 1/2"	330	
4003	3#500 KCMIL & 1#3G	3"			400	
\(4004 \)			4#500 KCMIL & 1#3G	3 1/2"	+00	
\(4503 \)	6#4/0 & 2#2G	(2) 2"			450	
\(4504 \)			8#4/0 & 2#2G	(2) 2 1/2"	430	
(5003)	6#250KCMIL & 2#2G	(2) 2 1/2"			500	
(5004)			8#250 KCMIL & 2#2G	(2) 2 1/2"		
(6003)	6#350KCMIL & 2#1G	(2) 3"			600	
(6004)			8#350 KCMIL & 2#1G	(2) 3"		
(8003)	6#500KCMIL & 2#1/0G	(2) 3"			800	
(8004)			8#500 KCMIL & 2#1/0G	(2) 3 1/2"	7 800	

BRANCH CIRCUIT WIRING LEGEND				
NOTES: 1. ALL CONDUCTOR SIZES ARE FOR COPPER CONDUCTORS NEC (2020); 75 DEGREE C. 2. CONDUIT SIZES ARE FOR COPPER CONDUCTORS WITH THHN/THWN INSULATION IN RMC. 3. CONDUIT AND CABLE SIZES SHALL BE PER TABLE BELOW UNLESS NOTED OTHERWISE ON THE FLOOR PLANS AND DRAWINGS. 4. SEE SPECIFICATIONS FOR ACCEPTABLE CONDUCTOR TYPES.				
CIRCUIT SYMBOL	CONDUCTORS	CIRCUIT BREAKER		
	120 & 277V 1PH, 2W CKTS	•		
(201)	2#12 & 1#12G - 3/4"C	20/1		
(301)	2#10 & 1#10G - 3/4"C	30/1		
401	2#8 & 1#10G - 3/4"C	40/1		
(501)	2#8 & 1#10G - 3/4"C	50/1		
(601)	2#6 & 1#10G - 3/4"C	60/1		
	208 & 480V 1PH, 2W CKTS	•		
(202)	2#12 & 1#12G - 3/4"C	20/2		
(302)	2#10 & 1#10G - 3/4"C	30/2		
402	2#8 & 1#10G - 3/4"C	40/2		
(502)	2#8 & 1#10G - 3/4"C	50/2		
(602)	2#6 & 1#10G - 3/4"C	60/2		
208 & 480V 3PH, 3W CKTS				
(203)	3#12 & 1#12G - 3/4"C	20/3		
(303)	3#10 & 1#10G - 3/4"C	30/3		
403	3#8 & 1#10G - 3/4"C	40/3		
(503)	3#8 & 1#10G - 3/4"C	50/3		
⟨603⟩	3#6 & 1#10G - 3/4"C	60/3		

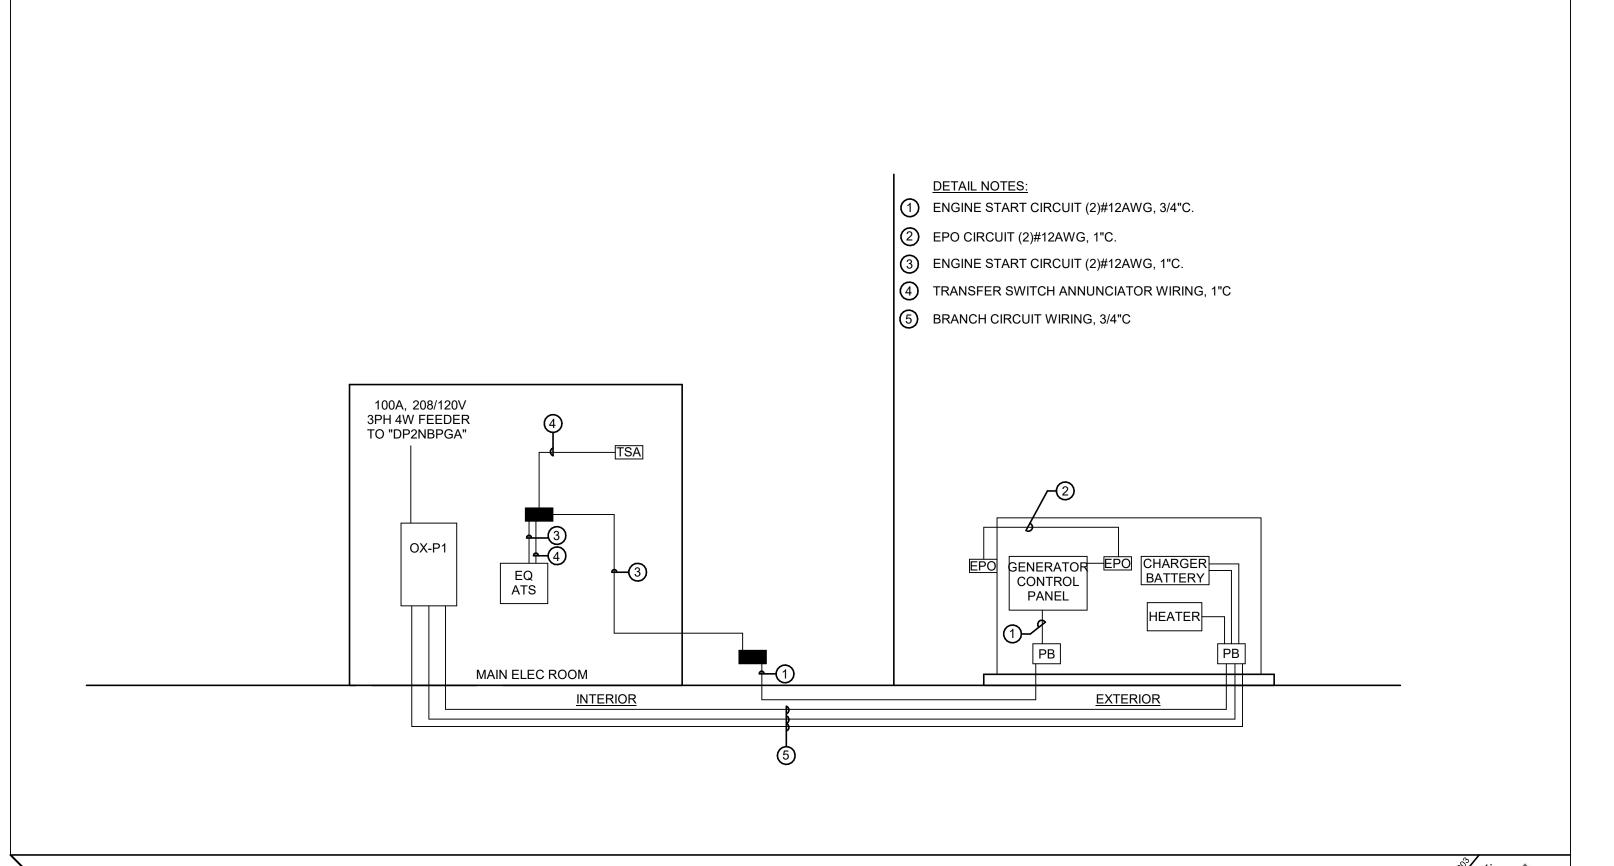

TYPICAL GENERATOR SYSTEM WIRING DETAIL

____ 5/32" HOLE

1/8" LETTERS

FITZEMEYER&TOCCI

Branch Panel: (XN) PANEL 1

Location:

Supply From: (E) PNL

3 1/8"

2 3/4"

LIGHTING PANEL

LP1

480/277V-3PH-4W_

1. NAMEPLATE TO BE CONSTRUCTED OF 1/16" THICK WHITE

TYPICAL NAMEPLATE DETAIL


SURFACE WITH LETTER ENGRAVED INTO BLACK

2. ALL NAMEPLATES SHALL BE SECURED BY MACHINE

3. NO NAMEPLATES SHALL BE PASTED ON.

LAMINATIONS.

SCREWS.

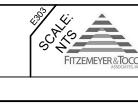

FITZEMEYER & TOCCO

- FINISHED GRADE/PAVEMENT - 12" RED (PER SHOP PROVIDE #4 REBAR IF DRAWINGS) WARNING TAPE SHALL RUN THE DUCTBANK IS LOCATED LENGTH OF DUCTBANK, UNDER LOCATED 12"B.F.G. (TYPICAL) — COMPACT NATIVE BACKFILL VOID OF OBJECTS OVER TWO 6" MIN INCHES IN DIAMETER AND VOID OF DECOMPOSED CONCRETE **ENCASEMENT SHALL** BE 3 INCHES MINIMUM ALL AROUND CONDUITS - UNDISTURBED EARTH OR COMPACTED FILL — PLASTIC SPACERS

TYPICAL DUCT BANK DETAIL

TYPICAL PANELBOARD NOTES

1. FURNISH ALL PANELBOARDS FULLY POPULATED WITH BRANCH CIRCUIT BREAKERS, THAT IS, ALL SPACES SHALL HAVE A 20AMP, 1 POLE CIRCUIT BREAKER INSTALLED.

2. PANEL FACE PLATES SHALL BE ATTACHED TO

BACK BOX WITH FULL-LENGTH PIANO HINGE AND PROVIDED WITH LOCKING DOOR IN DOOR.
PANELBOARDS CONTAINING MAIN SERVICE DISCONNECT MUST BE LISTED FOR THE USE.

A.I.C. Rating: 10,000 AMPS SYMMETRICAL

Mains Type: MAIN CB

Total Est. Demand: 0.00 kVA

Total Conn.: 0 A

Total Est. Demand: 0 A


3. PANELBOARDS CONTAINING MAIN SERVICE
DISCONNECT MUST BE LISTED FOR THE USE.
4. ALL CIRCUIT BREAKERS SHALL BE BOLT-ON
TYPE AND HACR RATED.

Volts: 208Y/120

Phases: 3

Mounting: SURFACE Wires: 4 Mains Rating: 100 A MCB Rating: 100 A Enclosure: NEMA1 CKT **Circuit Description Circuit Description** 0.00... 0.00... 3 (E) HWCP#1 VIA VFD 7 (E) GENERATOR HEATER 9 (E) PANEL QUAD 11 (E) BOILER #1 13 SPARE 15 SPARE 17 SPARE 19 SPARE 21 SPARE 23 SPARE 25 SPARE 31 SPARE 33 SPARE 35 SPARE 37 SPARE 39 SPARE 41 SPARE
 Total Load:
 0.00 kVA
 0.00 kVA
 0.00 kVA

 Total Amps:
 0 A
 0 A
 0 A
 Load Classification Demand Factor Estimated Demand Panel Totals Connected Load Total Conn. Load: 0.00 kVA

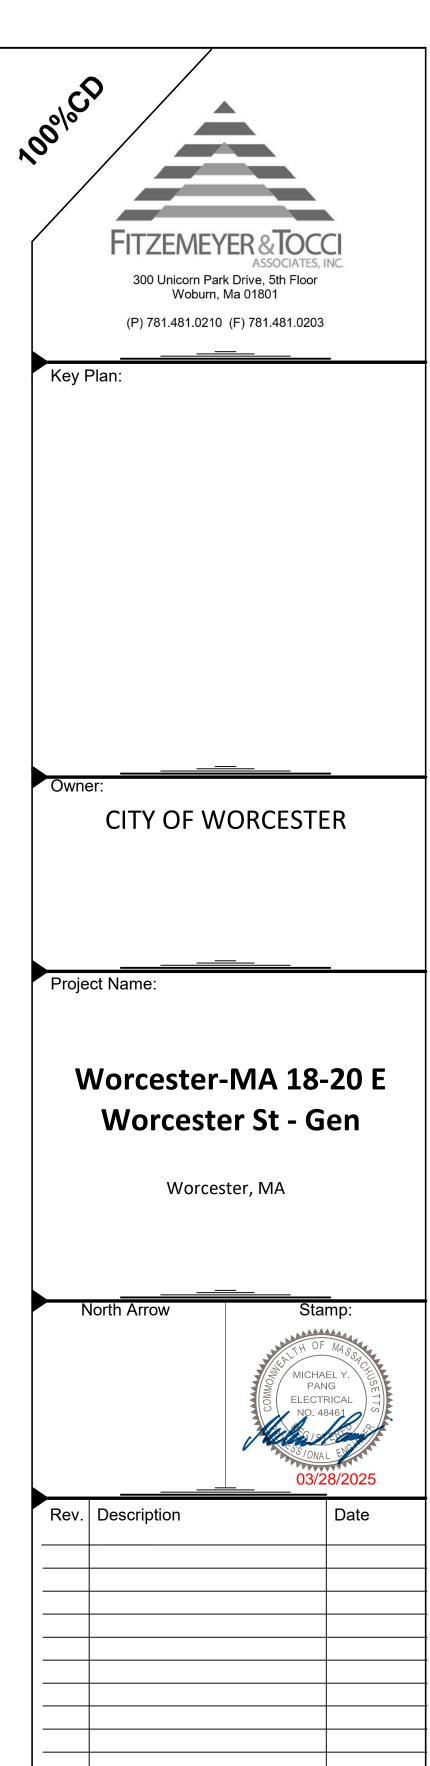


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Draw	ing Title:	=

ELECTRICAL SCHEDULES
AND DETAILS


Date	03/28/2025
Scale	NTS
Drawn By	Hk
Checked By	MF
Project Numb	per 210538.13

Drawing No.

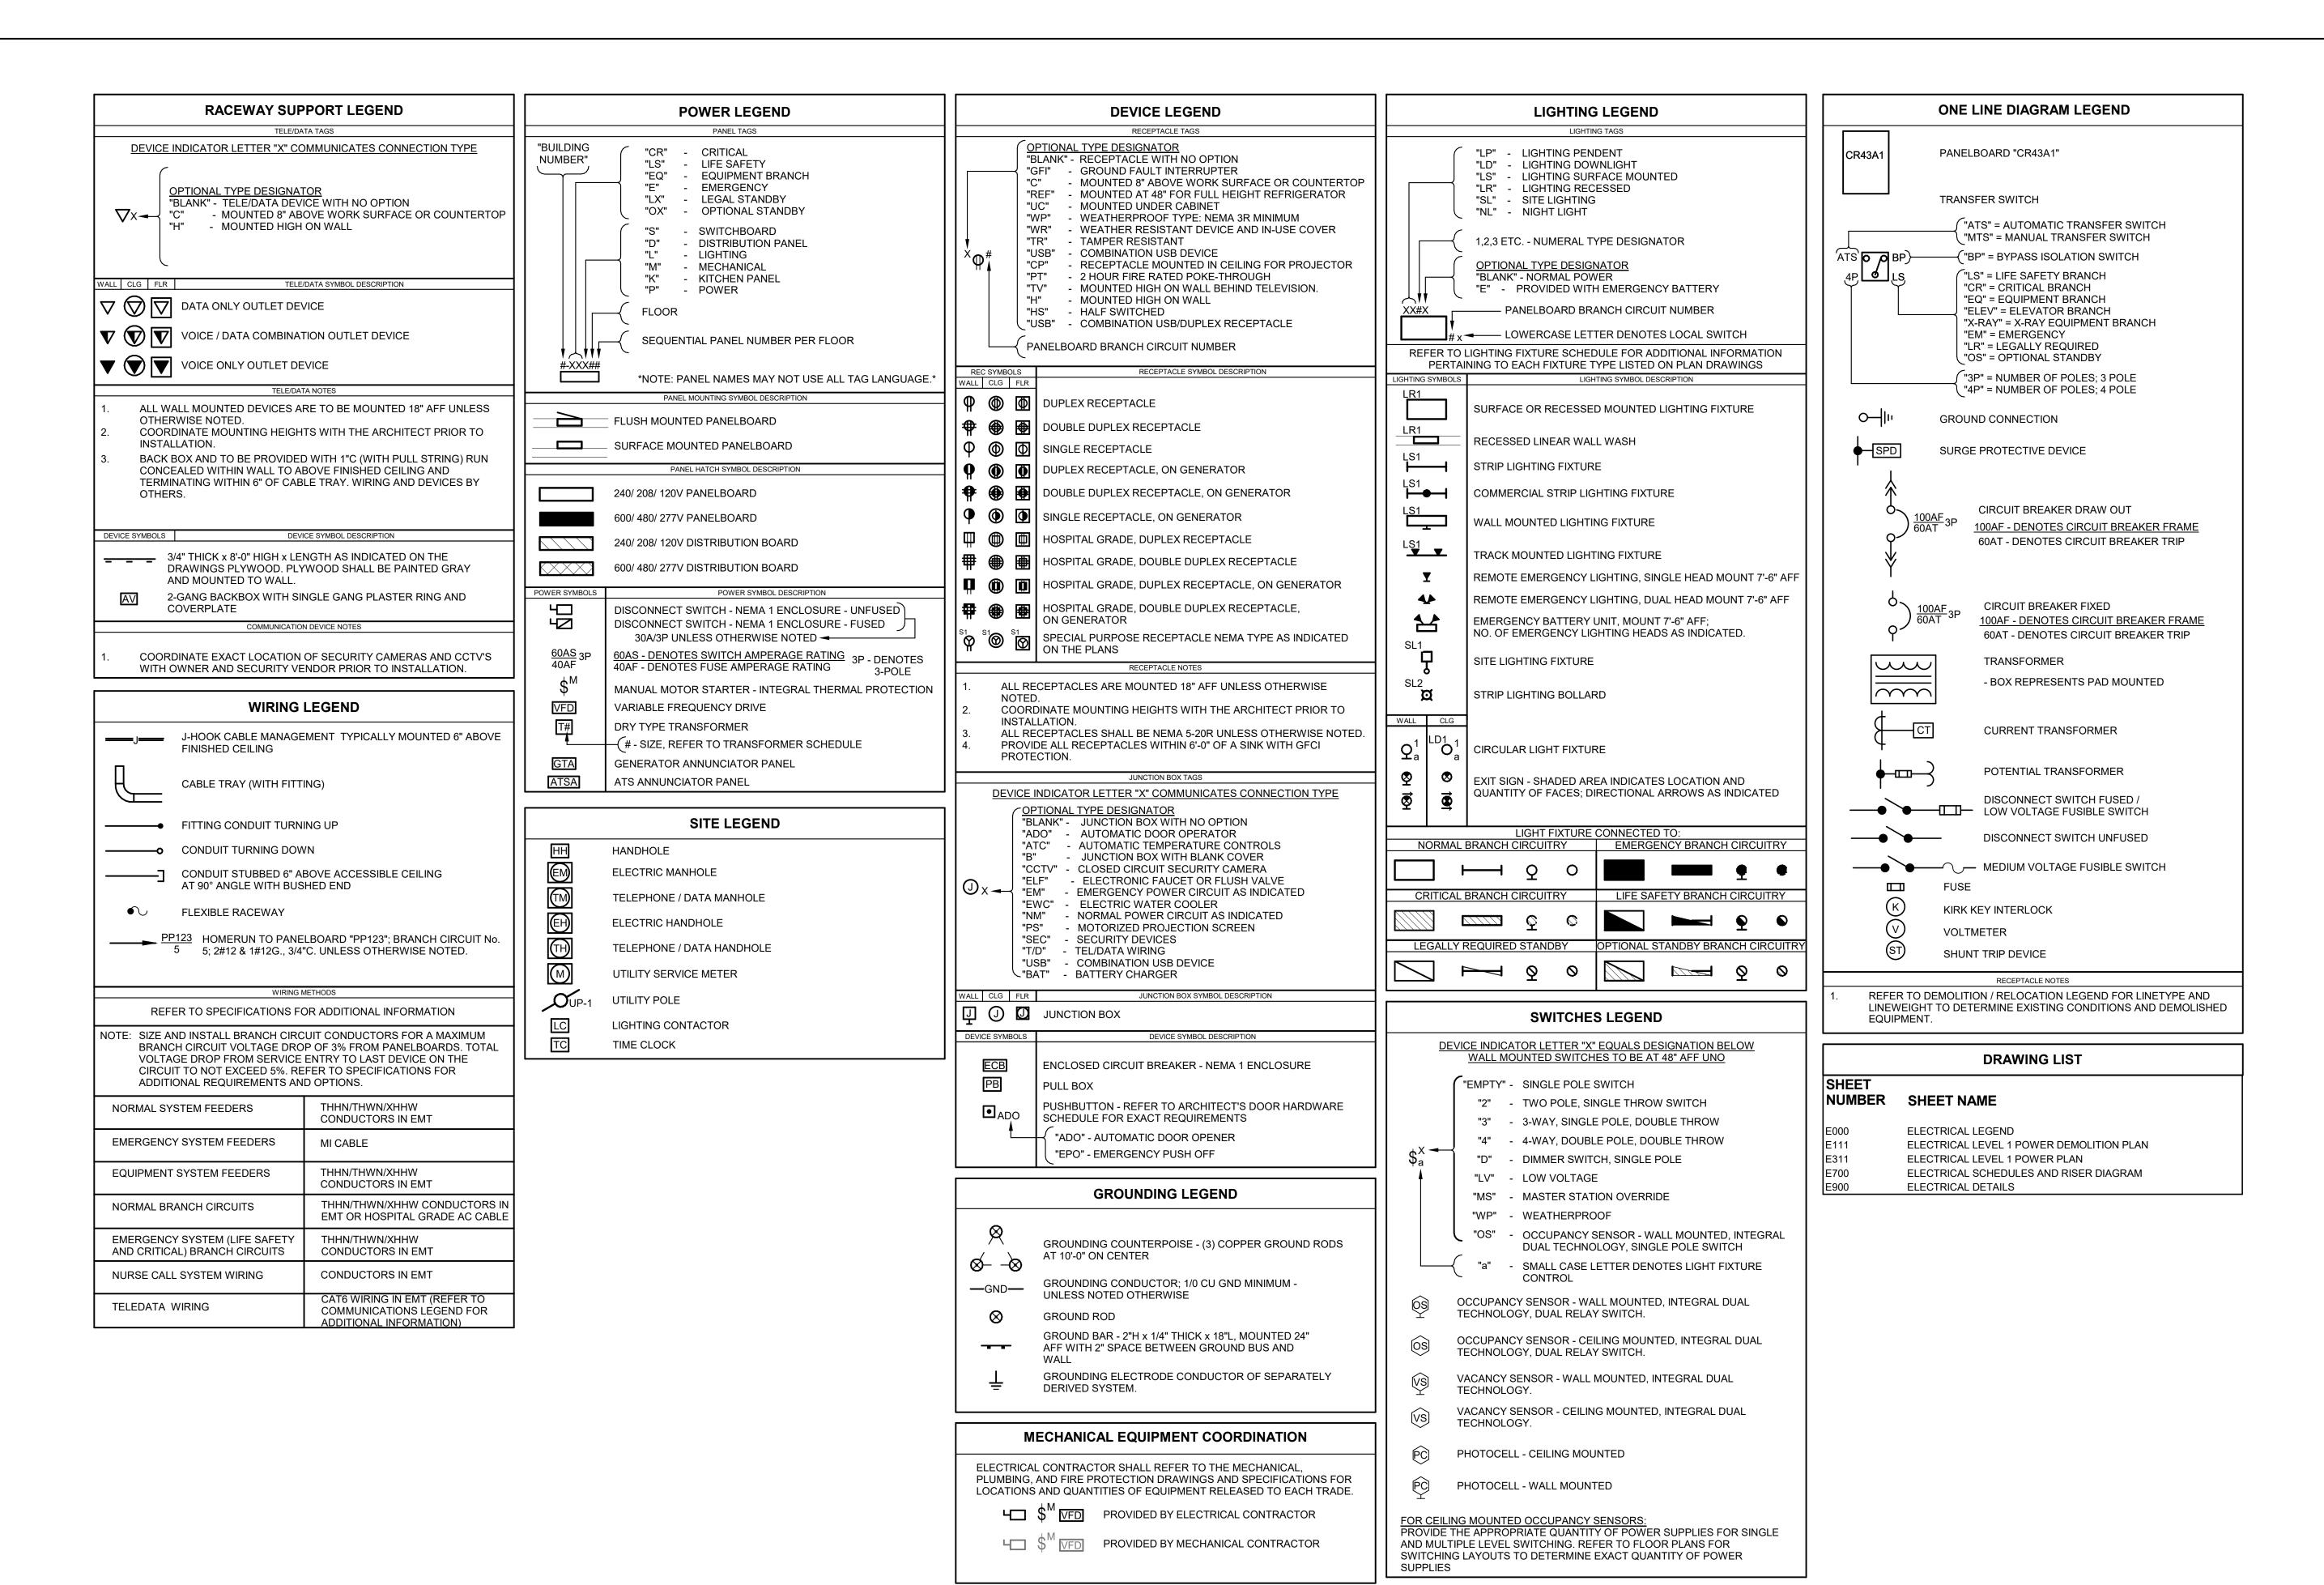



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As indicated



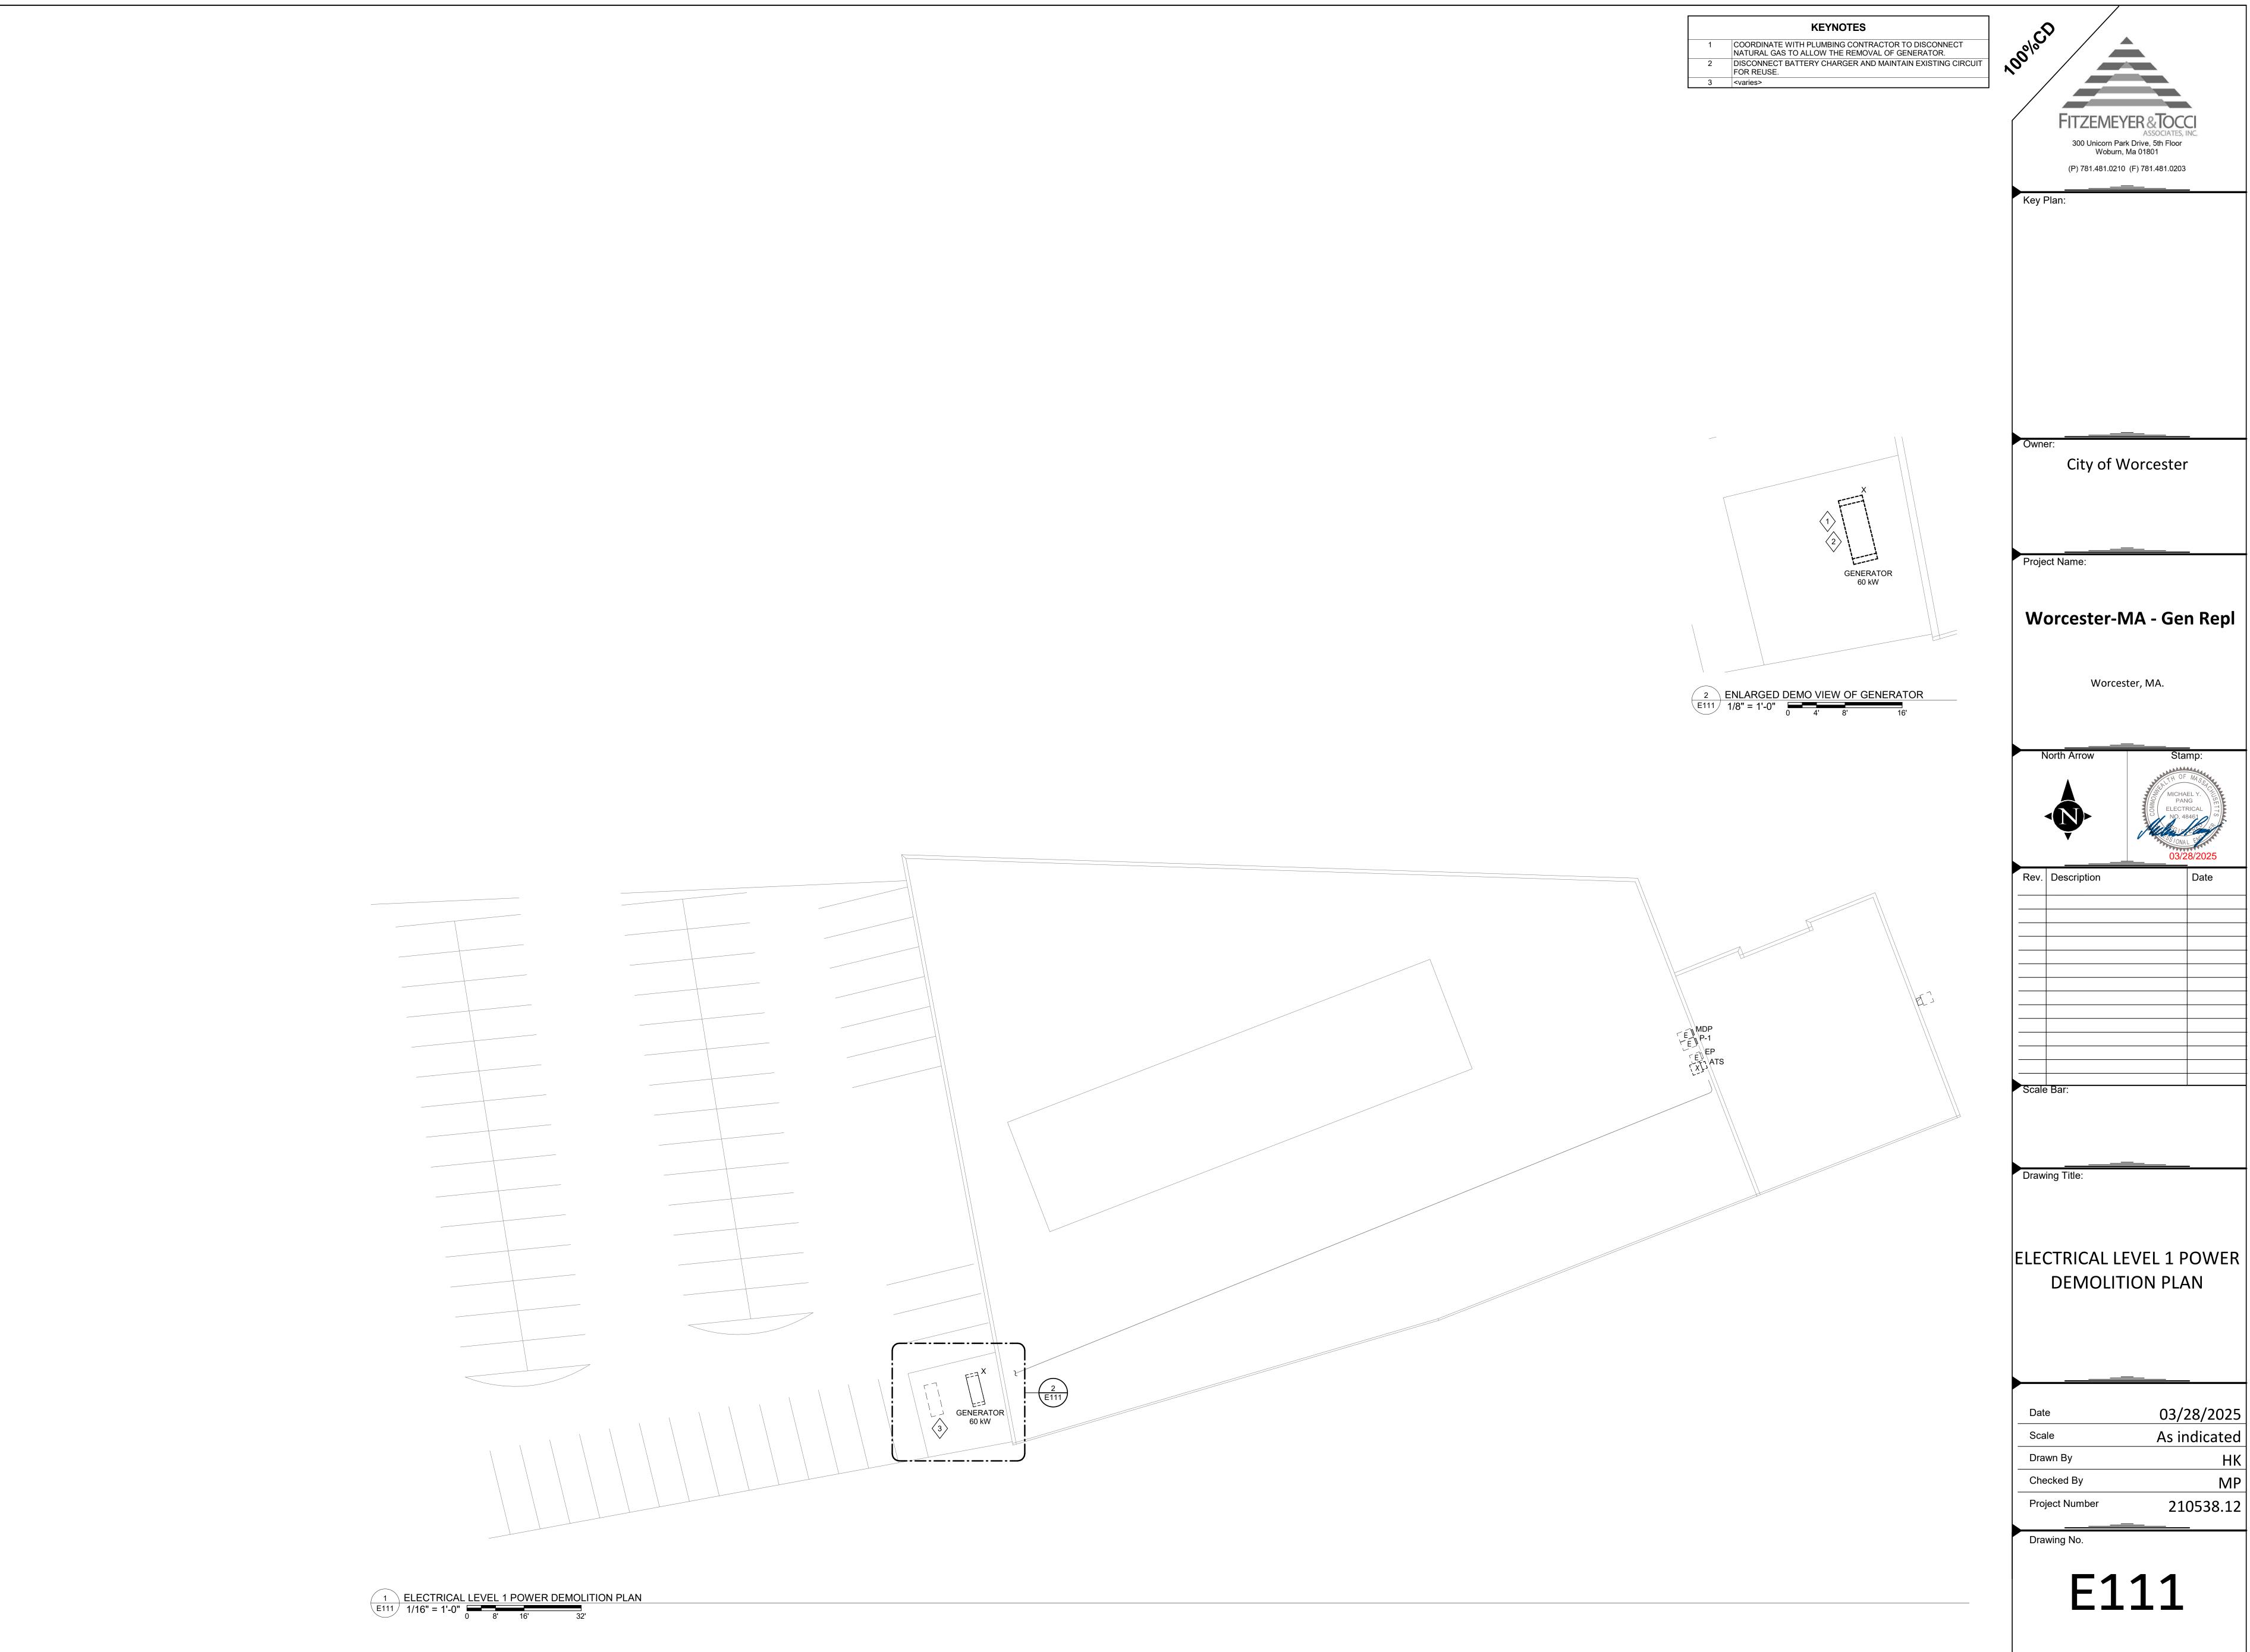

As indicated

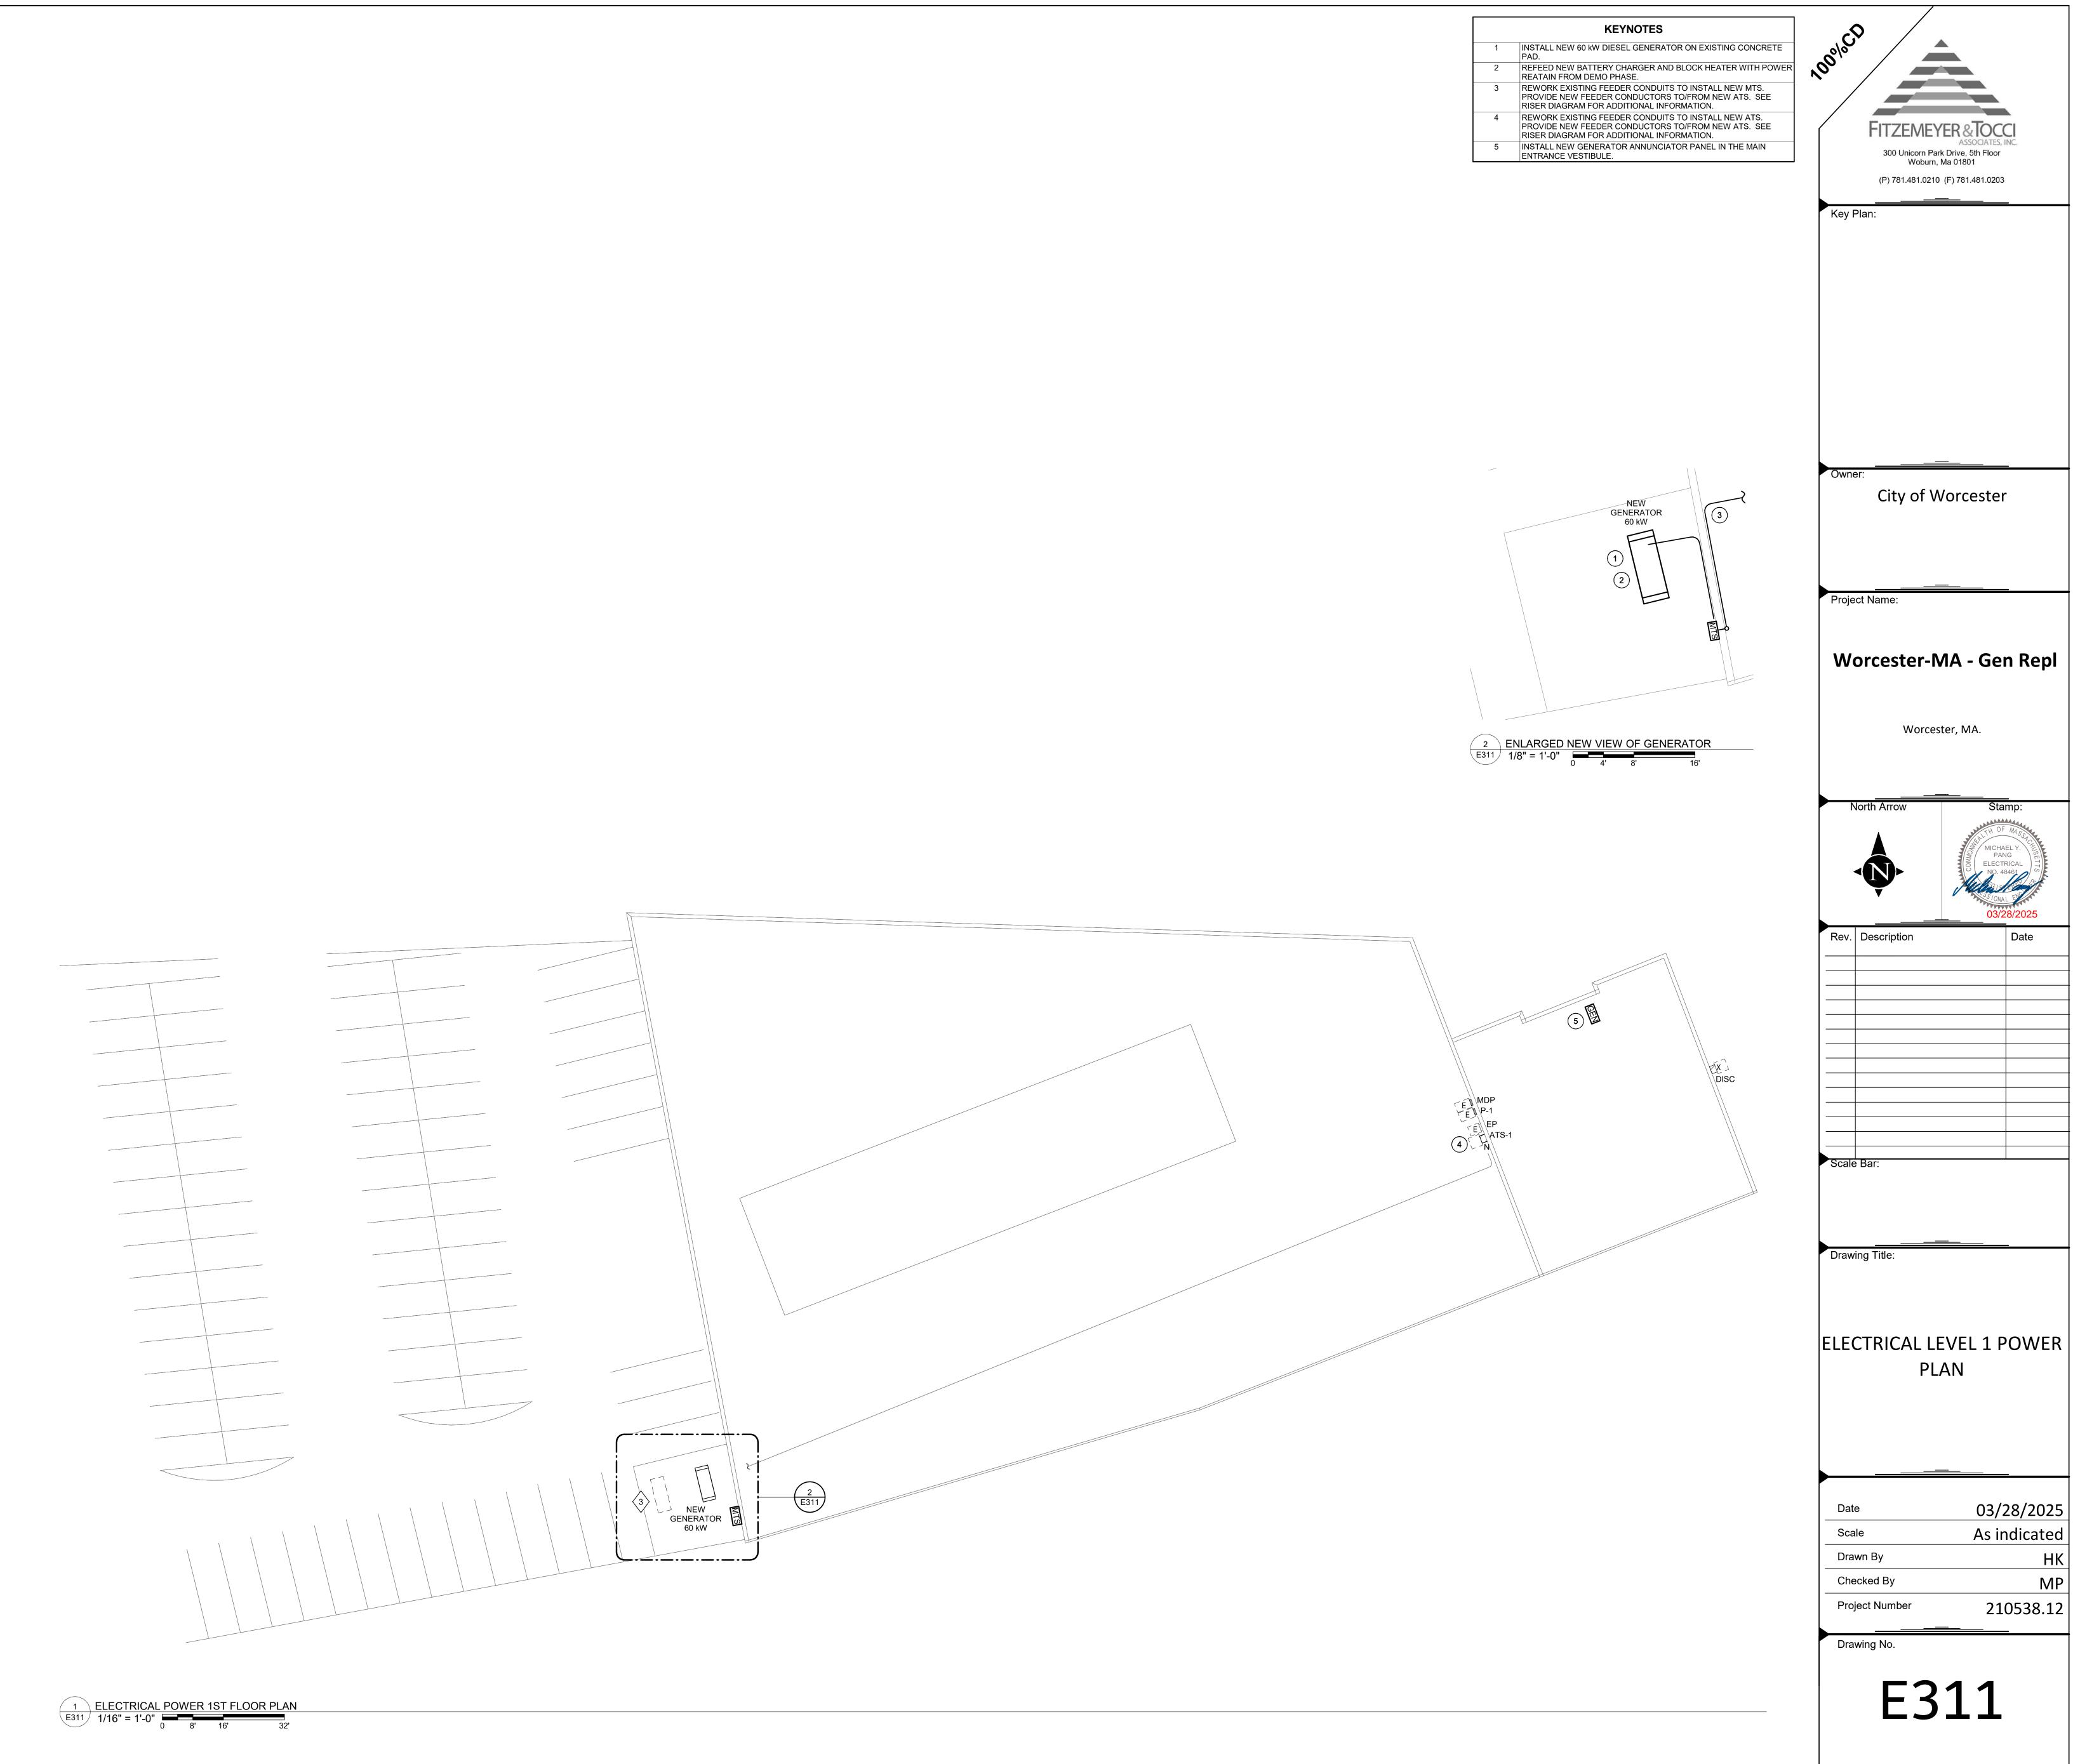3. 600 KCMIL FEEDERS SHALL BE PROVIDED WITH MAC ADAPTERS AS REQUIRED TO COORDINATE WITH BREAKER LUG 4.SEE SPECIFICATIONS FOR ACCEPTABLE CONDUCTOR TYPES. 5.CONTRACTOR SHALL PROVIDE PRICING INFORMATION FOR USE OF ALUMINUM FEEDERS AS ADD ALTERNATE #. FEEDER CONDUCTORS (3PH, 3W) RACEWAY CONDUCTORS (3PH, 4W) RACEWAY NOMINAL SYMBOL WITH GROUND WITH GROUND SIZE **AMPERE** REFER TO DRY TYPE TRANSFORMER SCHEDULE 3#4 & 1#8G 4#4 & 1#8G 1 1/4" 3#4 & 1#8G 4#4 & 1#8G 1 1/4" 3#3 & 1#8G 1 1/4" 4#3 & 1#8G 1 1/4" 3#3 & 1#8G 1 1/4" 4#3 & 1#8G 1 1/4" 3#2 & 1#6G 1 1/4" 4#2 & 1#6G 1 1/4" 3#1 & 1#6G 1 1/4" 4#1 & 1#6G 1 1/2" 3#1/0 & 1#6G 1 1/2" 150 4#1/0 & 1#6G 2" 3#2/0 & 1#6G 2" 175 4#2/0 & 1#6G 2" 3#3/0 & 1#6G 2" 200 4#3/0 & 1#6G 2" 3#4/0 & 1#4G 225 4#4/0 & 1#4G 2 1/2" 3#250 KCMIL & 1#4G 2 1/2" 4#250 KCMIL & 1#4G 2 1/2" 3#350 KCMIL & 1#4G 300 4#350 KCMIL & 1#4G 3" 3#500 KCMIL & 1#3G 350 4#500 KCMIL & 1#3G 3 1/2" 3#500 KCMIL & 1#3G 4#500 KCMIL & 1#3G 3 1/2" 6#4/0 & 2#2G (2) 2" 450 8#4/0 & 2#2G (2) 2 1/2" 6#250KCMIL & 2#2G (2) 2 1/2" 8#250 KCMIL & 2#2G (2) 2 1/2"

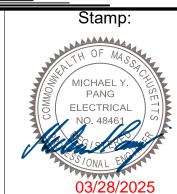(2) 3"

(2) 3"

BRANCH CIRCUIT WIRING LEGEND

8#350 KCMIL & 2#1G

8#500 KCMIL & 2#1/0G

(2) 3"

6#350KCMIL & 2#1G

6#500KCMIL & 2#1/0G

LEGEND OF FEEDER SIZES

2. CONDUIT SIZES ARE FOR COPPER CONDUCTORS WITH THHN/THWN INSULATION IN RMC PER NEC TABLE C.9 IN


1. ALL CONDUCTOR SIZES ARE FOR COPPER CONDUCTORS NEC TABLE 310.16(2020); 75 DEGREE C.

TYPICAL PANELBOARD NOTES

- PANEL FACE PLATES SHALL BE ATTACHED TO BACK BOX WITH FULL-LENGTH PIANO HINGE AND PROVIDED WITH LOCKING DOOR IN DOOR.
 ALL CIRCUIT BREAKERS SHALL BE BOLT-ON TYPE AND HACE BATES.
- TYPE AND HACR RATED.

 NEW CIRCUIT BREAKERS TO BE INSTALLED IN EXISTING PANELBOARDS SHALL MATCH EXISTING PANELBOARD IN ALL RESPECTS INCLUDING SHORT CIRCUIT RATING (KAIC).

	ARE FOR COPPER CONDUCTORS NEC (2020); 75 DEGI	
	R COPPER CONDUCTORS WITH THHN/THWN INSULATI ZES SHALL BE PER TABLE BELOW UNLESS NOTED OTI	
	OR ACCEPTABLE CONDUCTOR TYPES.	
CIRCUIT SYMBOL	CONDUCTORS	CIRCUIT BREAKER
	120 & 277V 1PH, 2W CKTS	
⟨201⟩	2#12 & 1#12G - 3/4"C	20/1
⟨301⟩	2#10 & 1#10G - 3/4"C	30/1
401	2#8 & 1#10G - 3/4"C	40/1
(501)	2#8 & 1#10G - 3/4"C	50/1
(601)	2#6 & 1#10G - 3/4"C	60/1
·	208 & 480V 1PH, 2W CKTS	·
(202)	2#12 & 1#12G - 3/4"C	20/2
⟨302⟩	2#10 & 1#10G - 3/4"C	30/2
(402)	2#8 & 1#10G - 3/4"C	40/2
(502)	2#8 & 1#10G - 3/4"C	50/2
(602)	2#6 & 1#10G - 3/4"C	60/2
·	208 & 480V 3PH, 3W CKTS	·
(203)	3#12 & 1#12G - 3/4"C	20/3
(303)	3#10 & 1#10G - 3/4"C	30/3
(403)	3#8 & 1#10G - 3/4"C	40/3
(503)	3#8 & 1#10G - 3/4"C	50/3
(603)	3#6 & 1#10G - 3/4"C	60/3

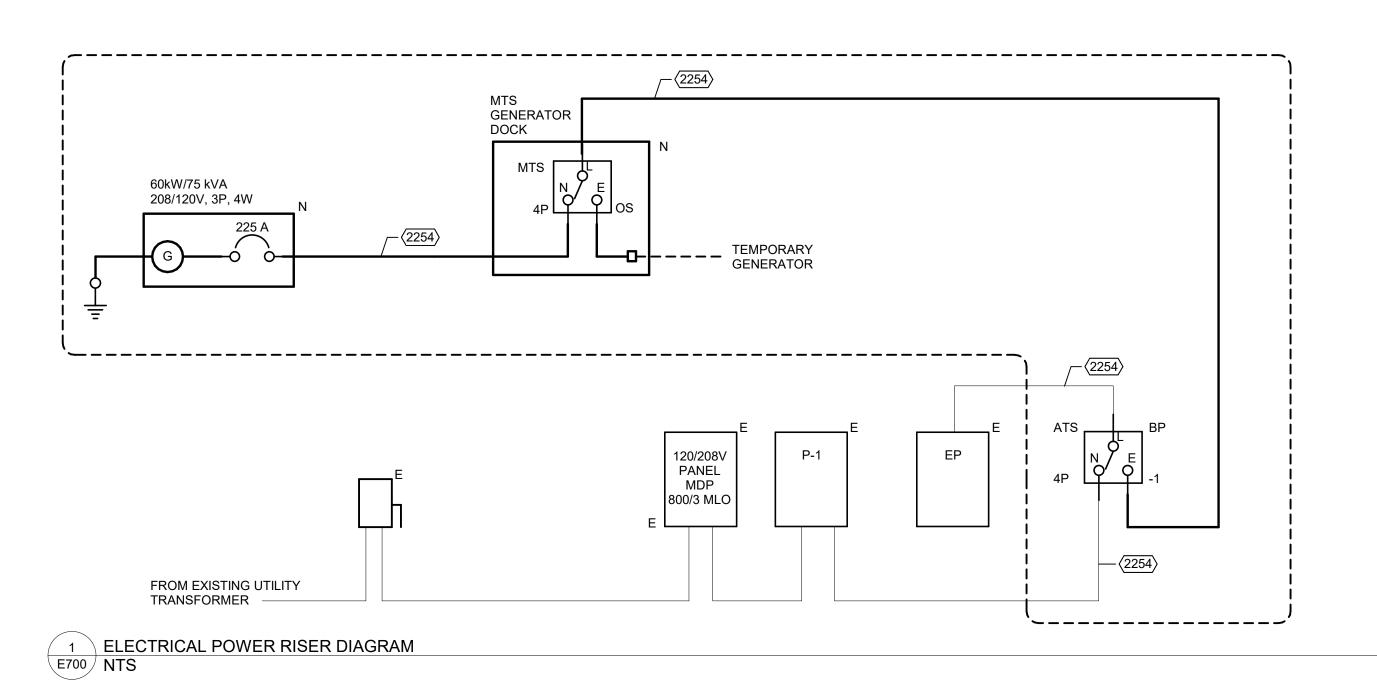

FITZEMEYER & TOCCI ASSOCIATES, INC. 300 Unicorn Park Drive, 5th Floor Woburn, Ma 01801 (P) 781.481.0210 (F) 781.481.0203

Key Plan:

City of Worcester

Project Name:

Worcester-MA - Gen Repl

Worcester, MA.

North Arrow

Stamp:

MICHAEL Y.
PANG
ELECTRICAL
NO. 48461

Rev.	Description	Date
Scale	Bar:	

ELECTRICAL SCHEDULES
AND RISER DIAGRAM

 Date
 03/28/2025


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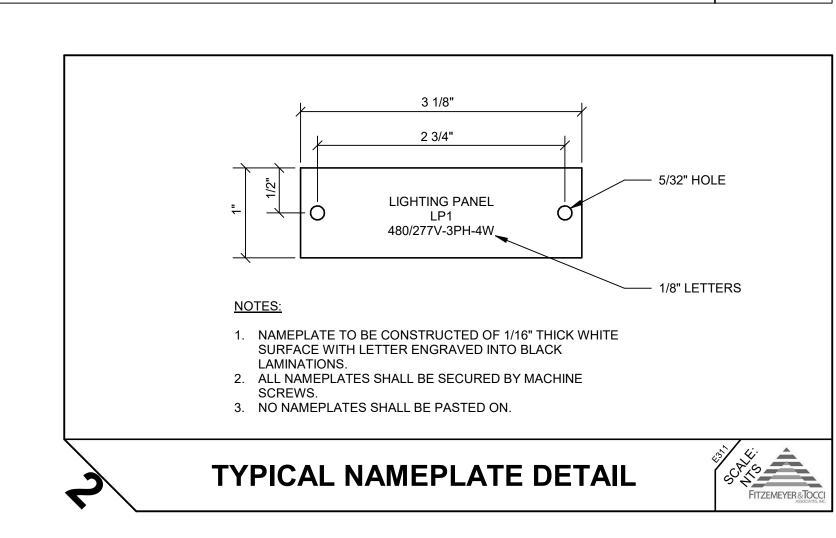
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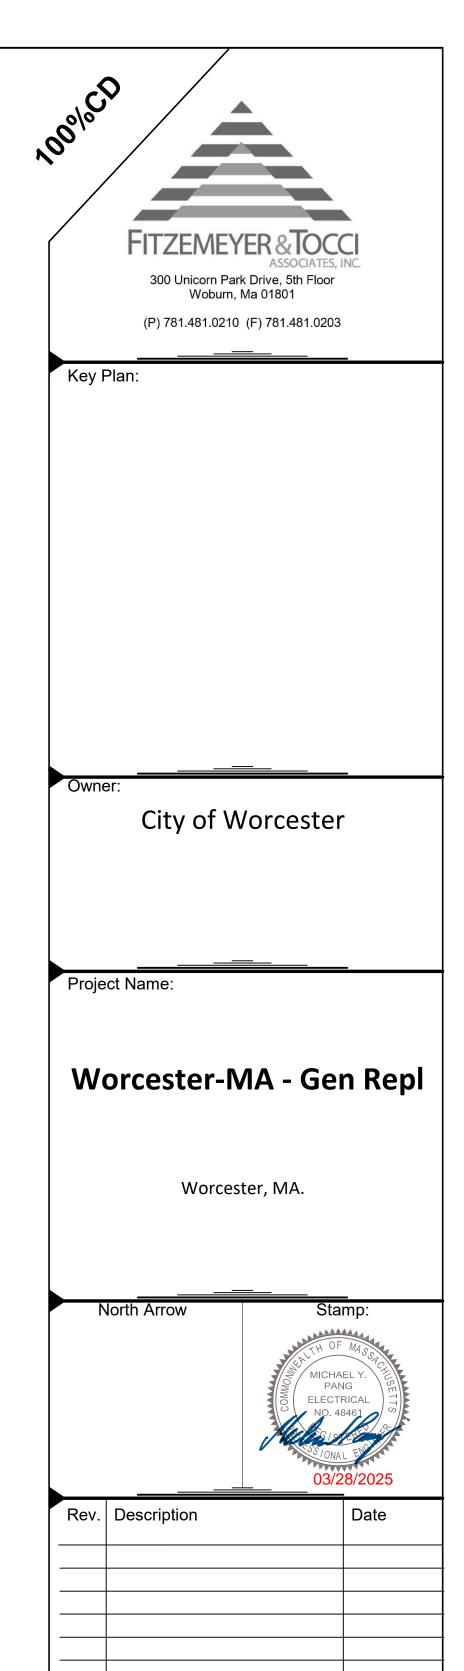
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 Project Number
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Drawing No.







ELECTRICAL DETAILS

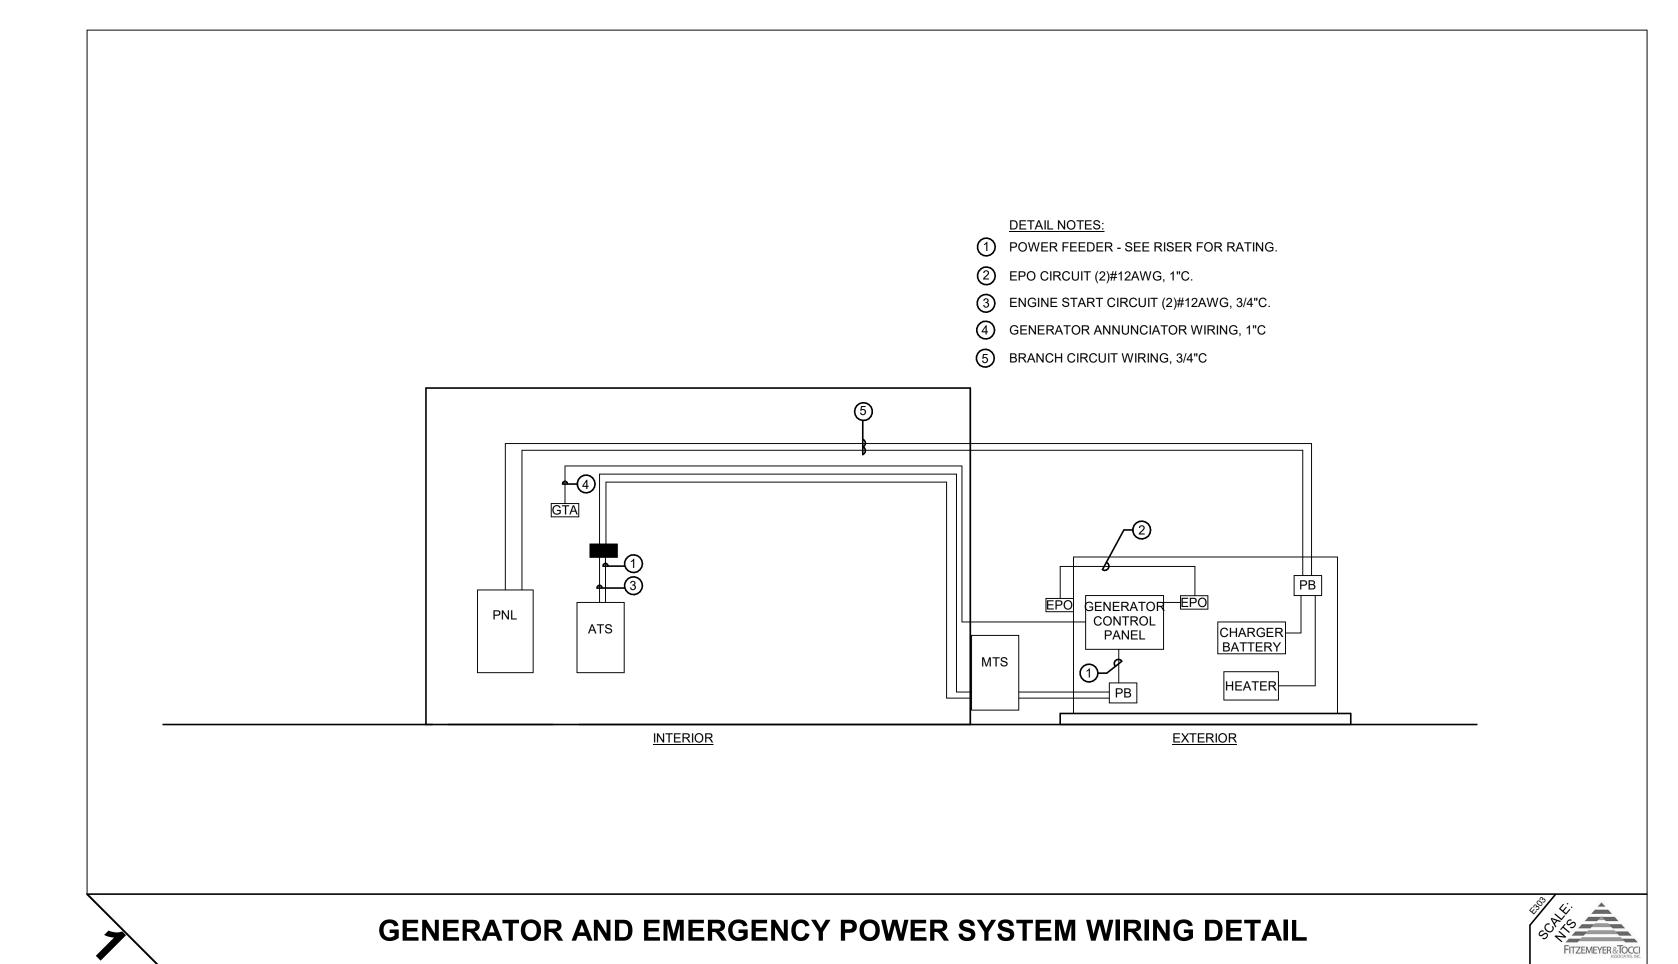Scale

Drawn By


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Drawing No.


Project Number

03/28/2025

210538.12

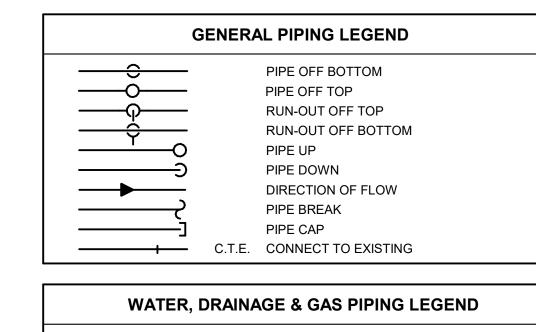

	G GAS (E) EXISTING PIPING TO REMAIN (X) PIPING TO BE REMOVED			
	VALVE LEGEND			
⊣ 0⊢	BV BALL VALVE			
Ø	PG PRESSURE GAUGE			
	DEMOLITION / RELOCATION LEGEND			
E	EXISTING PLUMBING EQUIPMENT, FIXTURE AND/OR SYSTEM TO REMAIN			
x	EXISTING PLUMBING EQUIPMENT, FIXTURE AND/OR SYSTEM TO BE SELECTIVELY DEMOLISHED			
XT	EXISTING PLUMBING EQUIPMENT AND/OR FIXTURE TO BE REMOVEDAND TURNED OVER TO OWNER FOR RE-USE			
XR	EXISTING PLUMBING EQUIPMENT AND/OR FIXTURE TO BE REMOVED, STORED AND RE-LOCATED.			
XL	EXISTING PLUMBING EQUIPMENT AND/OR FIXTURE INDICATED IN NEW LOCATION			
	DEMOLITION / RELOCATION NOTES			
PHASE LABELS SHOWN ABOVE ARE APPLIED IN SELECT AREAS AND MAY NOT ALWAYS BE PRESENT. REFER TO LINETYPE AND LINEWEIGHT TO DETERMINE EXISTING CONDITIONS AND DEMOLISHED EQUIPMENT.				
DRAWING LIST				
SHEET NUMBER	SHEET NAME			
P000 P101	PLUMBING LEGEND, NOTES AND ABBREVIATIONS PLUMBING GAS DEMOLITION PLAN			

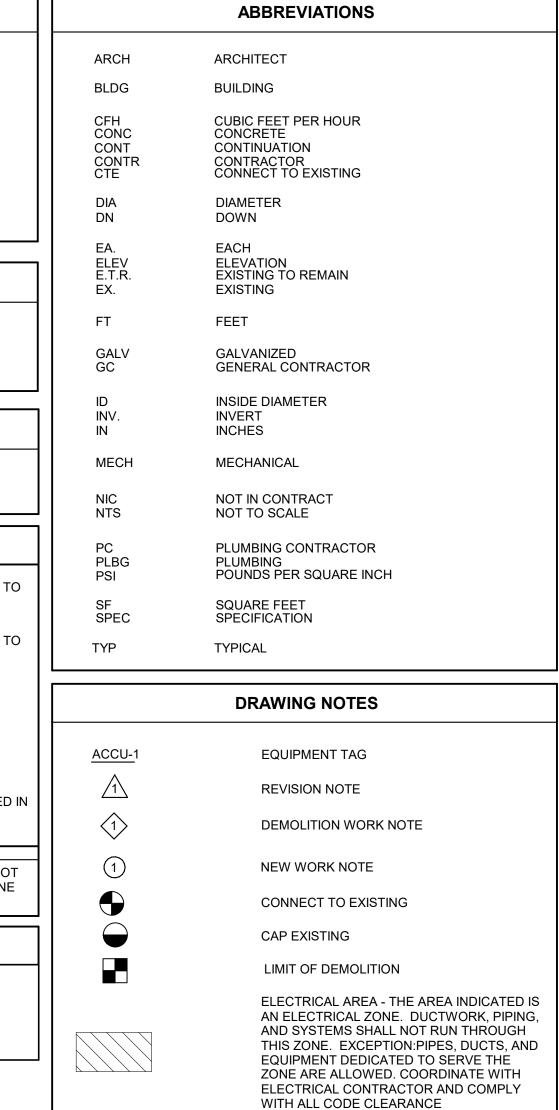

REQUIREMENTS.

DEMOLITION GENERAL NOTES P SHALL VISIT SITE AND IDENTIFY EXISTING

- 1. CONTRACTOR SHALL VISIT SITE AND IDENTIFY EXISTING CONDITIONS AND DIFFICULTIES THAT WILL AFFECT WORK OF THIS SECTION. NO COMPENSATION WILL BE GRANTED FOR ADDITIONAL WORK CAUSED BY UNFAMILIARITY WITH SITE CONDITIONS THAT ARE VISIBLE OR READILY CONSTRUED BY EXPERIENCED OBSERVERS.
- PRIOR TO COMMENCING WORK OF THIS SECTION, EXAMINE SITE AND CONDITIONS UNDER WHICH WORK WILL BE PERFORMED. DETERMINE EXACT LOCATIONS OF EXISTING EQUIPMENT, PIPING AND CONTROLS. REPORT TO OWNER ANY CONDITIONS THAT MIGHT ADVERSELY AFFECT WORK. COMMENCEMENT OF WORK SHALL BE CONSTRUED AS COMMENCED OF EXISTING CONDITIONS AND PREPARATORY
- 3. ABANDONING OF FIXTURES, CARRIERS, PIPING OR EQUIPMENT IN PLACE SHALL NOT BE ALLOWED. COMPLETE REMOVAL REQUIRED UNLESS NOTED OTHERWISE.
- PIPING TO BE REMOVED: REMOVE PORTION OF PIPING INDICATED TO BE REMOVED, PROVIDE FULL PORT BALL VALVE AND CAP REMAINING
- PIPING WITH SAME OR COMPATIBLE PIPING MATERIAL.

 FIXTURES TO BE REMOVED: REMOVE FIXTURES AND ALL ASSOCIATED ACCESSORIES INCLUDING BUT NOT LIMITED TOO, CARRIERS, SUPPORTS, PIPING, FLANGES, OTHER MOUNTING ACCESSORIES AND
- 6. EQUIPMENT TO BE REMOVED: DISCONNECT AND REMOVE EQUIPMENT. ALL UNUSED SERVICES CONNECTED TO DEMOLISHED EQUIPMENT SHALL BE REMOVED BACK TO UNUSED PORTION AND SERVICES CAPPED.
- 7. EQUIPMENT TO BE REMOVED AND SALVAGED: DISCONNECT AND CAP SERVICES, REMOVE EQUIPMENT AND DELIVER TO OWNER. ALL UNUSED POSTUMENTS.
- DOCUMENTS.

 8. COMPLY WITH ALL STATE AND LOCAL CODES AS TO REMOVAL AND
- DISPOSAL OF EQUIPMENT REMOVED FROM THE SITE.9. COMPLY WITH GOVERNING EPA NOTIFICATION REGULATIONS BEFORE BEGINNING SELECTIVE DEMOLITION.
- 10. REMOVE PREVIOUSLY ABANDONED WORK IN THE WAY OF EXISTING CONSTRUCTION, OR AS NOTED.
- 11. COMPLY WITH HAULING AND DISPOSAL REGULATIONS OF AUTHORITIES HAVING JURISDICTION.
- 12. COMPLY WITH ANSI A10.6 (SAFETY REQUIREMENTS FOR DEMOLITION OPERATIONS) AND NFPA 241 (STANDARD FOR SAFEGUARDING CONSTRUCTION, ALTERATION AND DEMOLITION OPERATIONS)
- 13. PERMITS: GIVE ALL REQUIRED NOTICES, FILE ALL REQUIRED PLANS AND SPECIFICATIONS RELATING TO THE WORK OF THIS SECTION WITH THE PROPER AUTHORITIES AND PAY FOR ANY REQUIRED PERMITS.
 14. ALL EQUIPMENT AND SYSTEMS TO BE REMOVED OR DEMOLISHED
- 14. ALL EQUIPMENT AND SYSTEMS TO BE REMOVED OR DEMOLISHED UNDER THIS SECTION AND NOT DESIRED BY OWNER SHALL BECOME THE PROPERTY OF THE CONTRACTOR. THE CONTRACTOR SHALL REMOVE ALL SUCH EQUIPMENT FROM THE SITE PROMPTLY AFTER DETACHMENT FROM BUILDING STRUCTURE.

15. STORAGE OR SALE OF REMOVED ITEMS OR MATERIALS ON-SITE IS NOT

ELECTRICAL AREA - THE AREA INDICATED IS
AN ELECTRICAL ZONE. DUCTWORK, PIPING,
AND SYSTEMS SHALL NOT BUN THROUGH

PERMITTED.

- CONTAINING HAZARDOUS MATERIALS SUSPECTED OF CONTAINING HAZARDOUS MATERIALS ARE ENCOUNTERED, DO NOT DISTURB; IMMEDIATELY NOTIFY ARCHITECT AND OWNER.
- 17. EXISTING PIPING SHOWN ON DRAWINGS DOES NOT INDICATE FULL EXTENT OF PIPING DEMOLITION. FIELD VERIFICATIONS REQUIRED.
- 18. FIXTURES EXISTING TO REMAIN: FIXTURES SHALL BE PROTECTED DURING DEMOLITION. FIXTURES DAMAGED DURING DEMOLITION SHALL BE REPAIRED TO LIKE NEW WORKING CONDITION OR REPLACED WITH SAME FIXTURE. WHERE SAME FIXTURE IS NO LONGER AVAILABLE AN APPROVED EQUAL BY OWNER AND ENGINEER SHALL BE USED. ALL WORK SHALL BE PERFORMED AT NO COST TO OWNER.

GENERAL NOTES

- PIPE ROUTING IS SHOWN DIAGRAMMATICALLY ON PLUMBING DRAWINGS AND SHALL BE ADJUSTED FOR ARCHITECTURAL, STRUCTURAL, MECHANICAL AND ELECTRICAL CLEARANCES AND LIMITATIONS AND FOR EQUIPMENT SELECTION.
- FURNISH AND INSTALL ALL ELEMENTS REQUIRED TO COMPLETE INTENDED PIPING SYSTEMS WHETHER OR NOT THESE ELEMENTS ARE SPECIFICALLY SHOWN ON DRAWINGS OR CALLED FOR IN SPECIFICATIONS.
- 3. CONSULT ALL DRAWINGS, NOTES, ARCHITECTURAL DETAILS AND ALL CONDITIONS THAT MAY AFFECT THE WORK AND CARE FOR SAME, WHILE EXECUTING THE WORK UNDER THIS SECTION. COOPERATE AND COORDINATE WITH THE ARCHITECT, ALL OTHER TRADES, BLDG. MANAGEMENT, AND THE OWNER.
- ALL WORK SHALL CONFORM TO ALL APPLICABLE FEDERAL, STATE, AND LOCAL CODES AND REGULATIONS.
- IN EVENT OF CONFLICT BETWEEN OR AMONG SPECIFIED REQUIREMENTS AND PERTINENT CODES OR REGULATIONS, MORE
- REQUIREMENTS AND PERTINENT CODES OR REGULATIONS, MORE STRINGENT REQUIREMENTS SHALL GOVERN.

 TAKE ALL MEASURES REQUIRED TO PROTECT OWNER'S PROPERTY AND
- EQUIPMENT DURING COURSE OF WORK. SHOULD DAMAGE TO OWNER'S PROPERTY OR EQUIPMENT OCCUR, REPAIR DAMAGE PROMPTLY AT NO COST TO OWNER.

 7. LOCATIONS, PLUMBING MOUNTING HEIGHTS, AND DETAILS SHOWN ON
- LOCATIONS, PLUMBING MOUNTING HEIGHTS, AND DETAILS SHOWN ON ARCHITECTURAL DRAWINGS TAKE PRECEDENCE OVER SAME SHOWN ON PLUMBING DRAWINGS AND DESCRIBED IN SECTIONS OF THE SPECIFICATIONS. WHEN ARCHITECTURAL DRAWINGS DO NOT SHOW PRECISE LOCATIONS OF DEVICES OR EQUIPMENT, LOCATE AS

DIRECTED BY THE ARCHITECT.

300 Unicorn Park Drive, 5th Floor Woburn, Ma 01801 (P) 781.481.0210 (F) 781.481.0203 Key Plan: City of Worcester Project Name: Worcester-MA - Gen Repl Worcester, MA. TERENCE R.
BOLAND
MECHANICAL
No. 50514

		Jona O	3/28/2025
Rev.	Description		Date
Scale	. Rar		
Juan	, Dai.		

PLUMBING LEGEND, NOTES
AND ABBREVIATIONS

 Date
 03/28/2025

 Scale
 NTS

 Drawn By
 LSM


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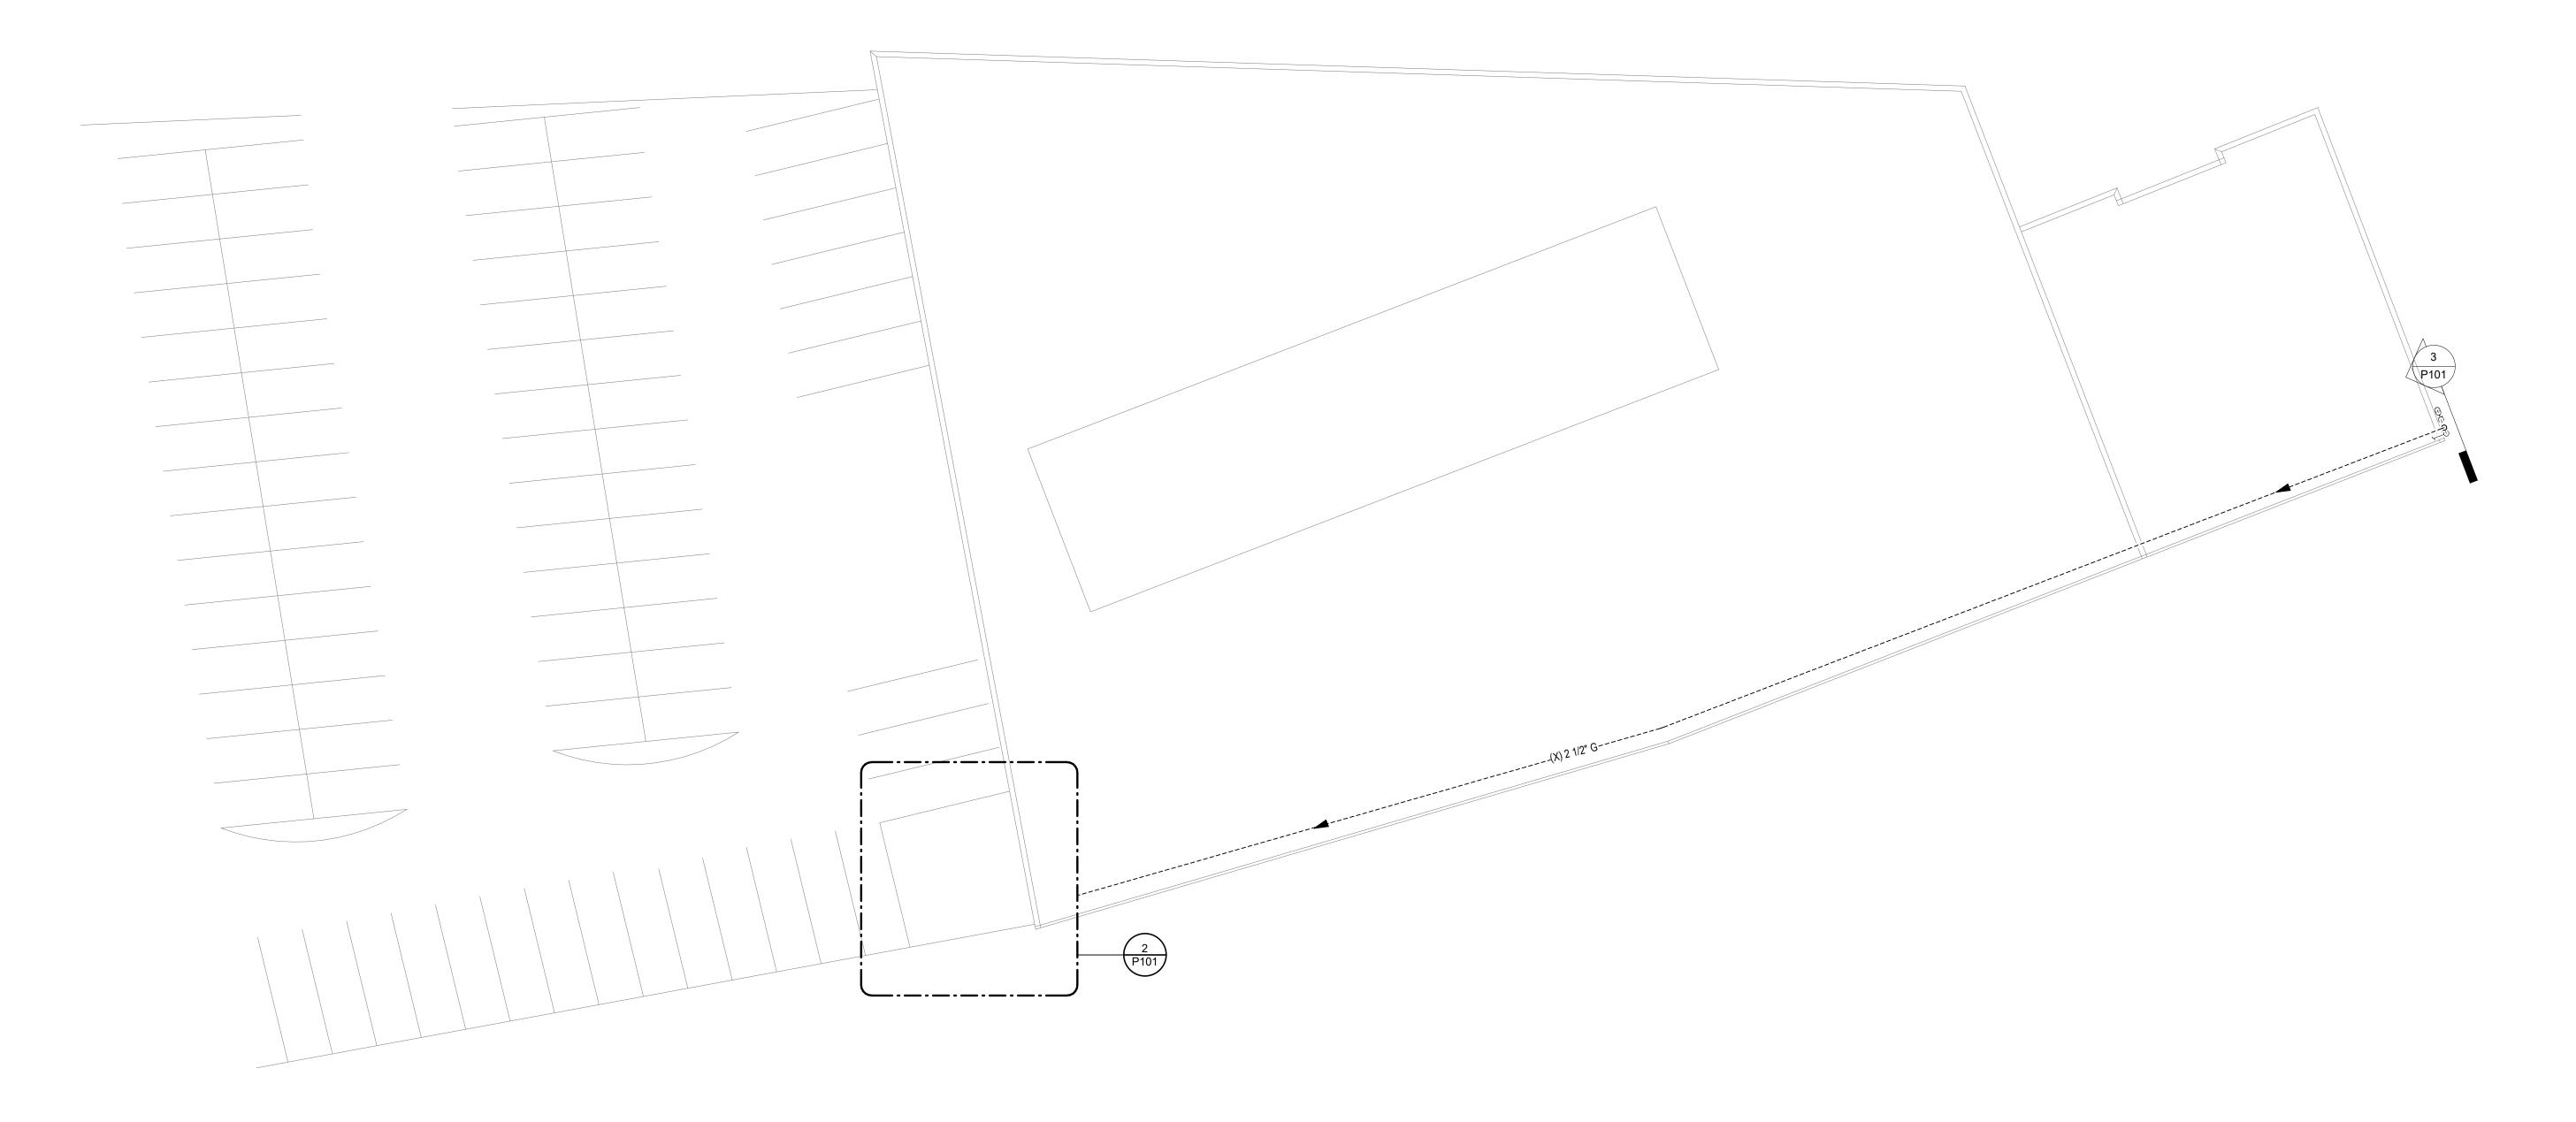
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Drawing No.

Drawing Title:

P000



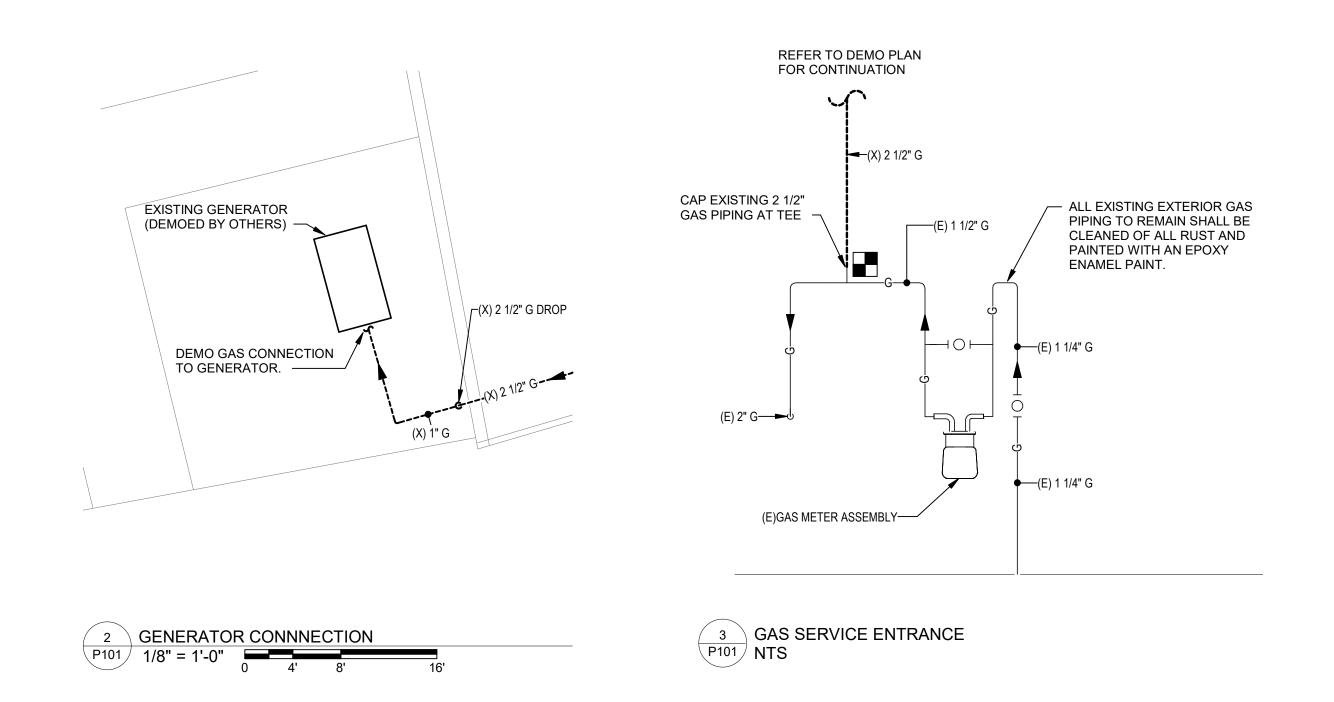

300 Unicorn Park Drive, 5th Floor Woburn, Ma 01801 (P) 781.481.0210 (F) 781.481.0203 Key Plan: City of Worcester Project Name: Worcester-MA - Gen Repl Worcester, MA. Rev. Description PLUMBING GAS **DEMOLITION PLAN** 03/28/2025 Date NTS Scale Drawn By LSM RDB Checked By Project Number 210538.12 Drawing No.

1 Plumbing Demo Plan-01 P101 1/16" = 1'-0" 0 4' 8' 16